



Fisheries and Oceans
Canada

Pêches et Océans
Canada

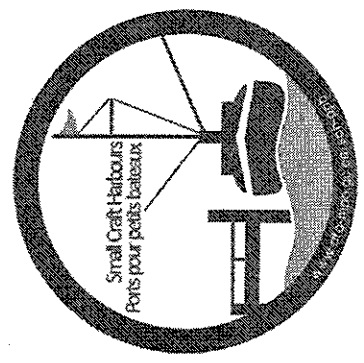

Small Craft Harbours
Newfoundland Region
St. John's, NL.

Ports Pour Petits Bateaux

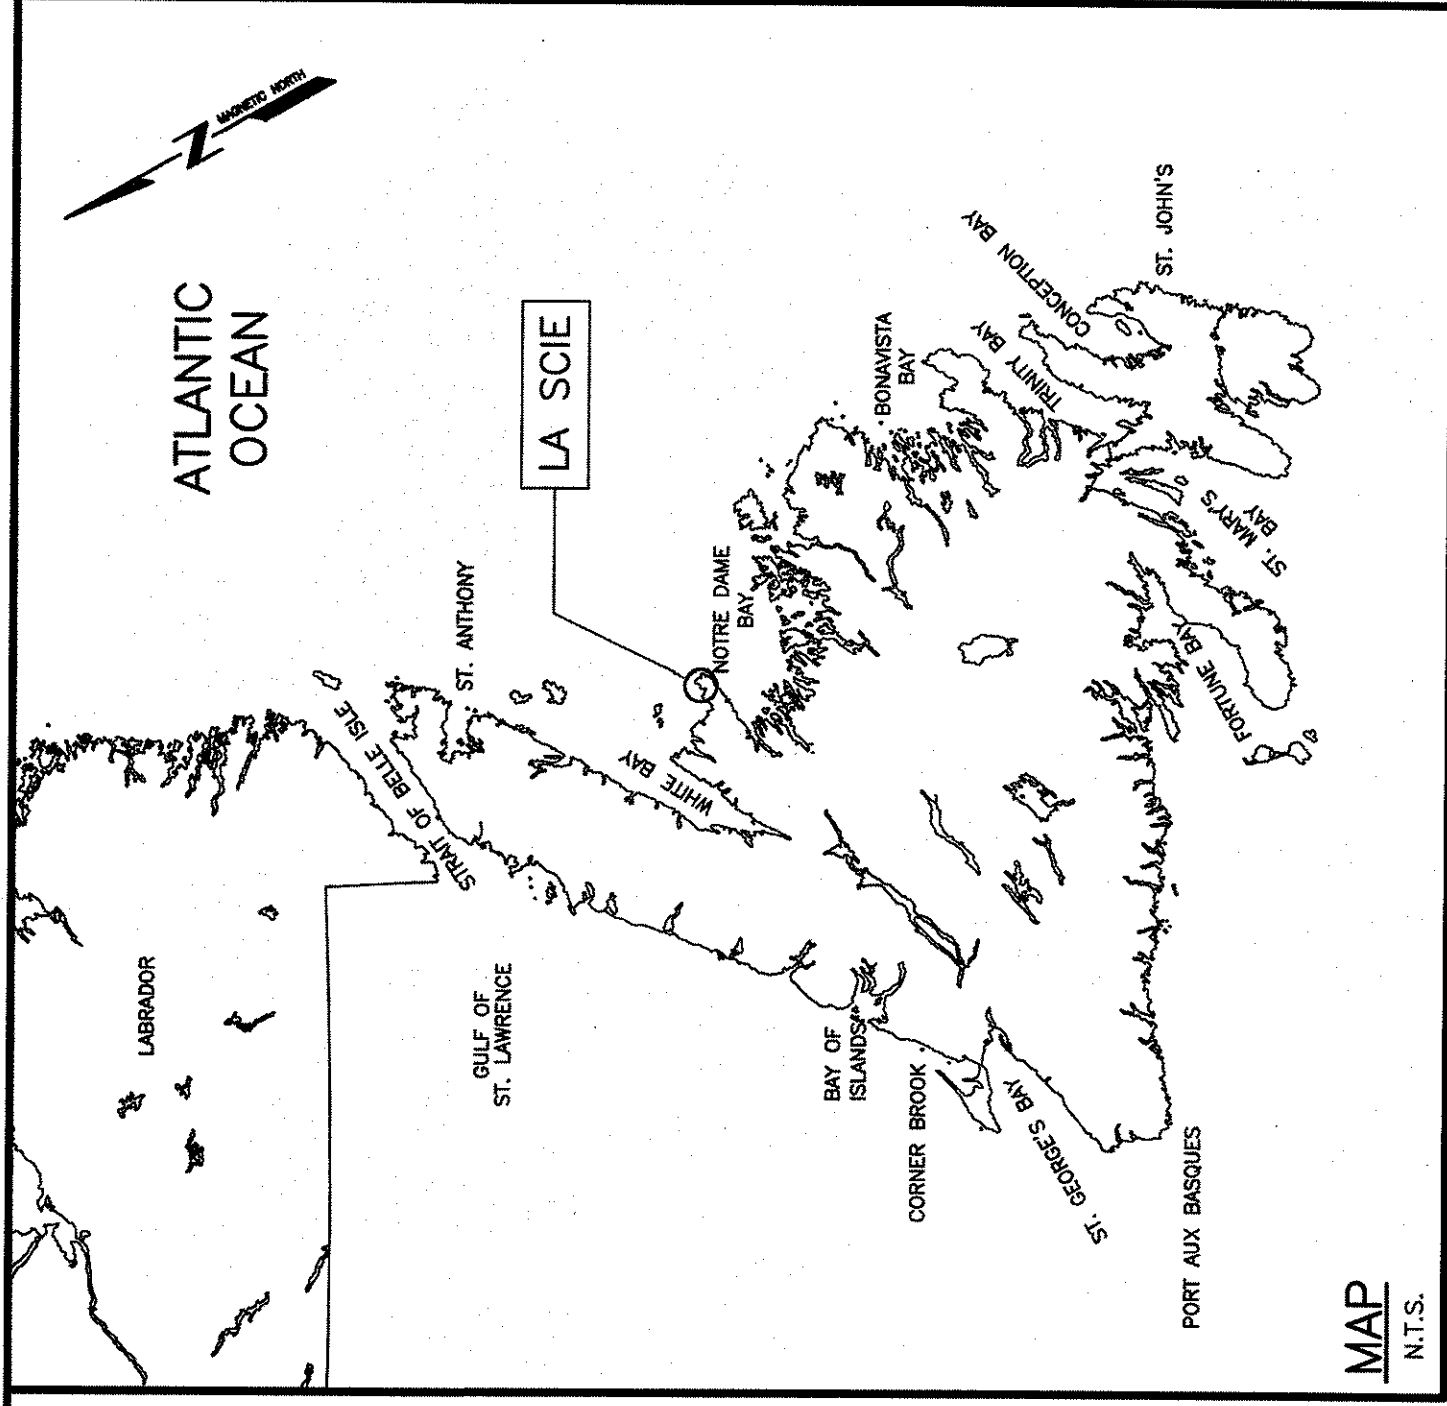

WHARF REPAIRS


LA SCIE

NEWFOUNDLAND AND LABRADOR

PROJECT NO. 723245

DRAWING LIST

<u>CIVIL</u>	
C1 OF 11	EXISTING SITE PLAN – WORK AREA #1
C2 OF 11	WHARF WORK PLAN – WORK AREA #1
C3 OF 11	EXISTING DEMOLITION SECTIONS – WORK AREA #1
C4 OF 11	NEW SECTIONS AND DETAILS – WORK AREA #1
C5 OF 11	NEW ELEVATIONS – WORK AREA #1 (SHEET 1 OF 2)
C6 OF 11	NEW ELEVATIONS – WORK AREA #1 (SHEET 2 OF 2)
C7 OF 11	EXISTING SITE PLAN – WORK AREA #2
C8 OF 11	WHARF WORK PLAN – WORK AREA #2
C9 OF 11	EXISTING DEMOLITION SECTIONS – WORK AREA #2
C10 OF 11	NEW SECTIONS AND DETAILS – WORK AREA #2
C11 OF 11	NEW ELEVATIONS – WORK AREA #2

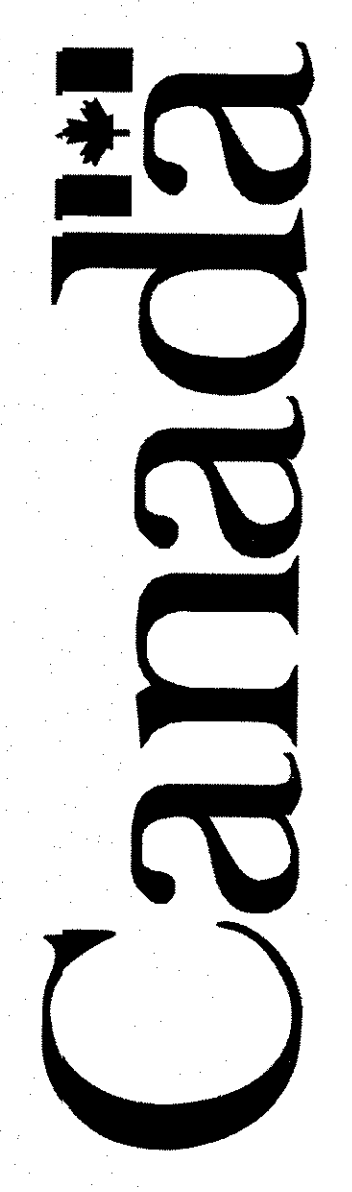


WORK SUMMARY TABLE

SIZE INDICATES NEW MEMBER SIZE WHICH MAY DIFFER FROM EXISTING
N/A - NOT APPLICABLE
CONTRACTOR IS RESPONSIBLE TO VERIFY ALL DIMENSIONS AND
QUANTITIES ON-SITE AND CONFIRM WITH DEPARTMENTAL REPRESENTATIVE
ON ALL ORGANIC MATERIALS

PRIOR TO ORDERING MATERIALS:

10


1. The first step in the process of creating a new product is to identify a market need. This involves conducting market research to understand the preferences and behaviors of potential customers. Once a need is identified, the next step is to develop a concept that addresses this need. This concept should be unique and offer a clear value proposition to the target market.

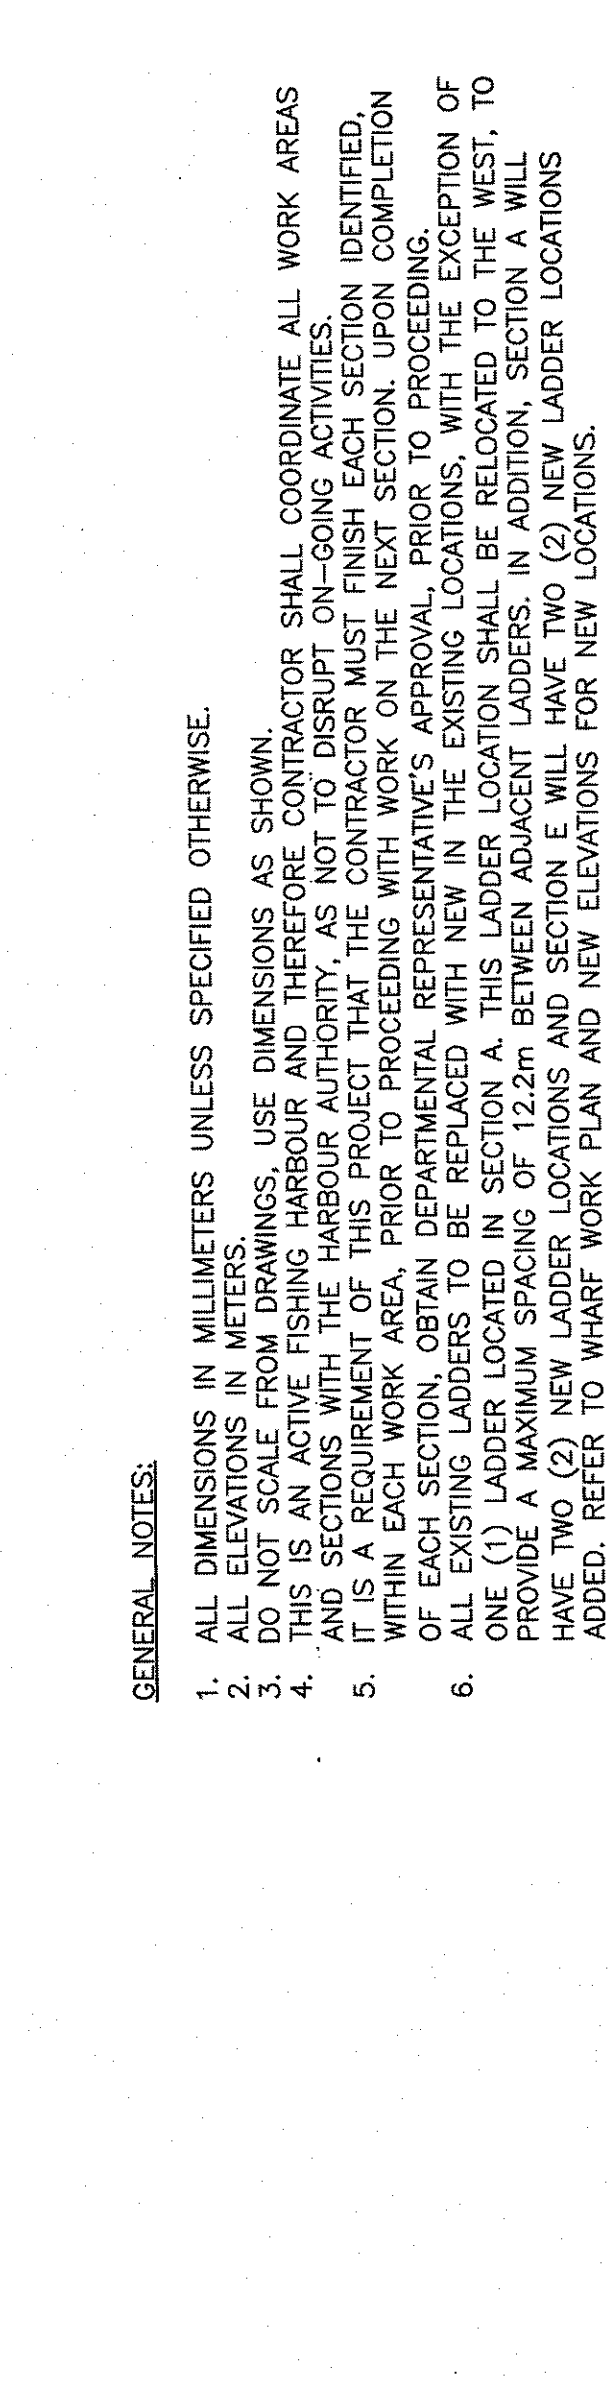

1. ALL DIMENSIONS IN MILLIMETERS UNLESS SPECIFIED OTHERWISE.



SCALE : 1:100

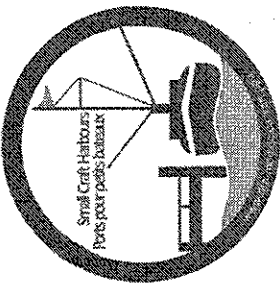




SMALL CRAFT HARBOURS

GENERAL NOTES:





1. ALL DIMENSIONS IN MILLIMETRES UNLESS SPECIFIED OTHERWISE.
2. ALL SOUNDINGS AND ELEVATIONS IN METRES UNLESS OTHERWISE SPECIFIED.
3. DO NOT SCALE FROM DRAWINGS, USE DIMENSIONS AS SHOWN.
4. THE CONTRACTOR SHALL DETERMINE WHAT SAFETY MEASURES NEED TO BE TAKEN DURING DEMOLITION/CONSTRUCTION ACTIVITIES.
5. ENSURE ALL ITEMS WHICH ARE DESIGNATED FOR REMOVAL ARE FULLY EXTRACTED IN THEIR ENTIRETY, CONTRACTOR TO DISPOSE OF ALL DEMOLISHED MATERIALS AT A PROVISIONALLY APPROVED WASTE DISPOSAL PLANTIFY.
6. RELIABLE AS-BUILT INFORMATION IS LIMITED, EXISTING WHARF PLANS AND RECORDS TO BE USED TO DETERMINE THE EXISTING FACTOR TO BASE COSTS FOR DEMOLITION AND ASSOCIATED RISKS ACCORDINGLY.
7. THIS IS AN ACTIVE FISHING HARBOUR AND THEREFORE CONTRACTOR SHALL COORDINATE ALL WORK AREAS AND SECTIONS WITH THE HARBOUR AUTHORITY, AS NOT TO DISRUPT ON-GOING ACTIVITIES.
8. IT IS A REQUIREMENT OF THIS PROJECT THAT THE CONTRACTOR MUST FINISH EACH SECTION IDENTIFIED, WITHIN EACH WORK AREA, PRIOR TO PROCEEDING WITH WORK ON THE NEXT SECTION. UPON COMPLETION OF EACH SECTION, OBTAIN DEPARTMENTAL REPRESENTATIVE'S APPROVAL, PRIOR TO PROCEEDING.
9. REFER TO SECTION 02 41 18-SITE WORK, DEMOLITION AND REMOVAL
10. CONTRACTOR SHALL AVOID DAMAGING EXISTING REMAINING CORING DURING DEMOLITION ACTIVITIES. IF ANY DAMAGE TO EXISTING REMAINING CORING DURING CONSTRUCTION ACTIVITIES, WILL BE REPLACED AT THE CONTRACTOR'S OWN EXPENSE.
11. AS NOTED IN THE WORK SUMMARY TABLE AN ALLOWANCE HAS BEEN MADE TO THE CONTRACTOR TO OBTAIN APPROVAL FROM THE DEPARTMENT OF MARINE AND FISHERIES, OBTAIN APPROVAL, PRIOR TO COPING WITH REPLACEMENT.
12. IF EITHER OF THE ELECTRICAL OR WATERLINE(S) HAVE TO BE DISCONNECTED DURING CONSTRUCTION, THE CONTRACTOR SHALL BE RESPONSIBLE FOR OBTAINING AND INSTANT TEMPORARY ELECTRICAL POWER AND WATER TO THE AFFECTED AREAS.

LEGEND


DENOTES ITEMS TO BE COMPLETELY
REMOVED AND DEMOLISHED

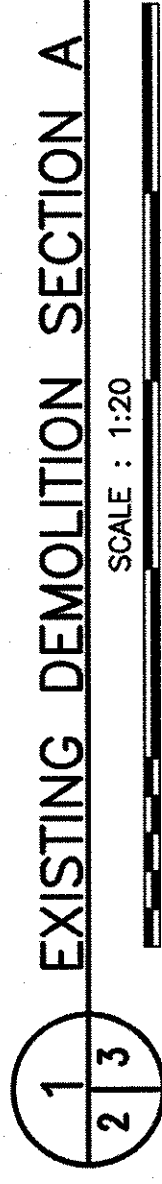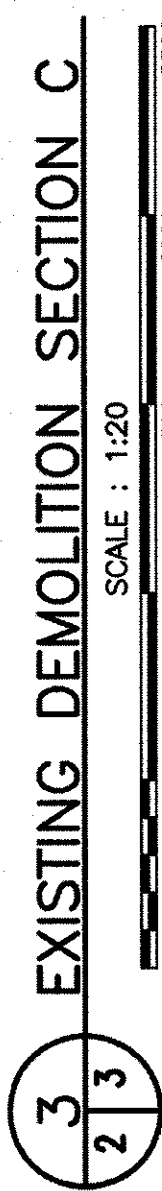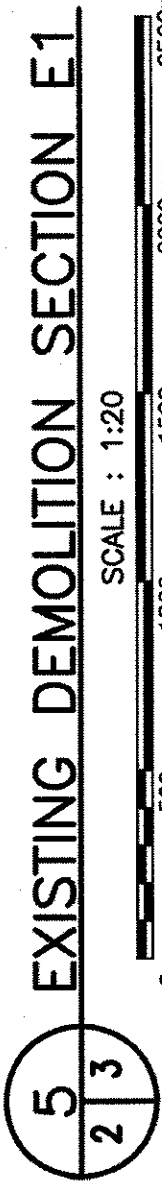


NOTE:
THE ELECTRICAL TECK CABLE
RUNS ALONG A PORTION OF
SECTION A.

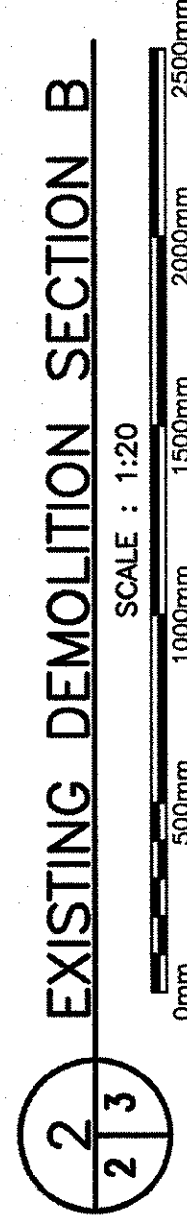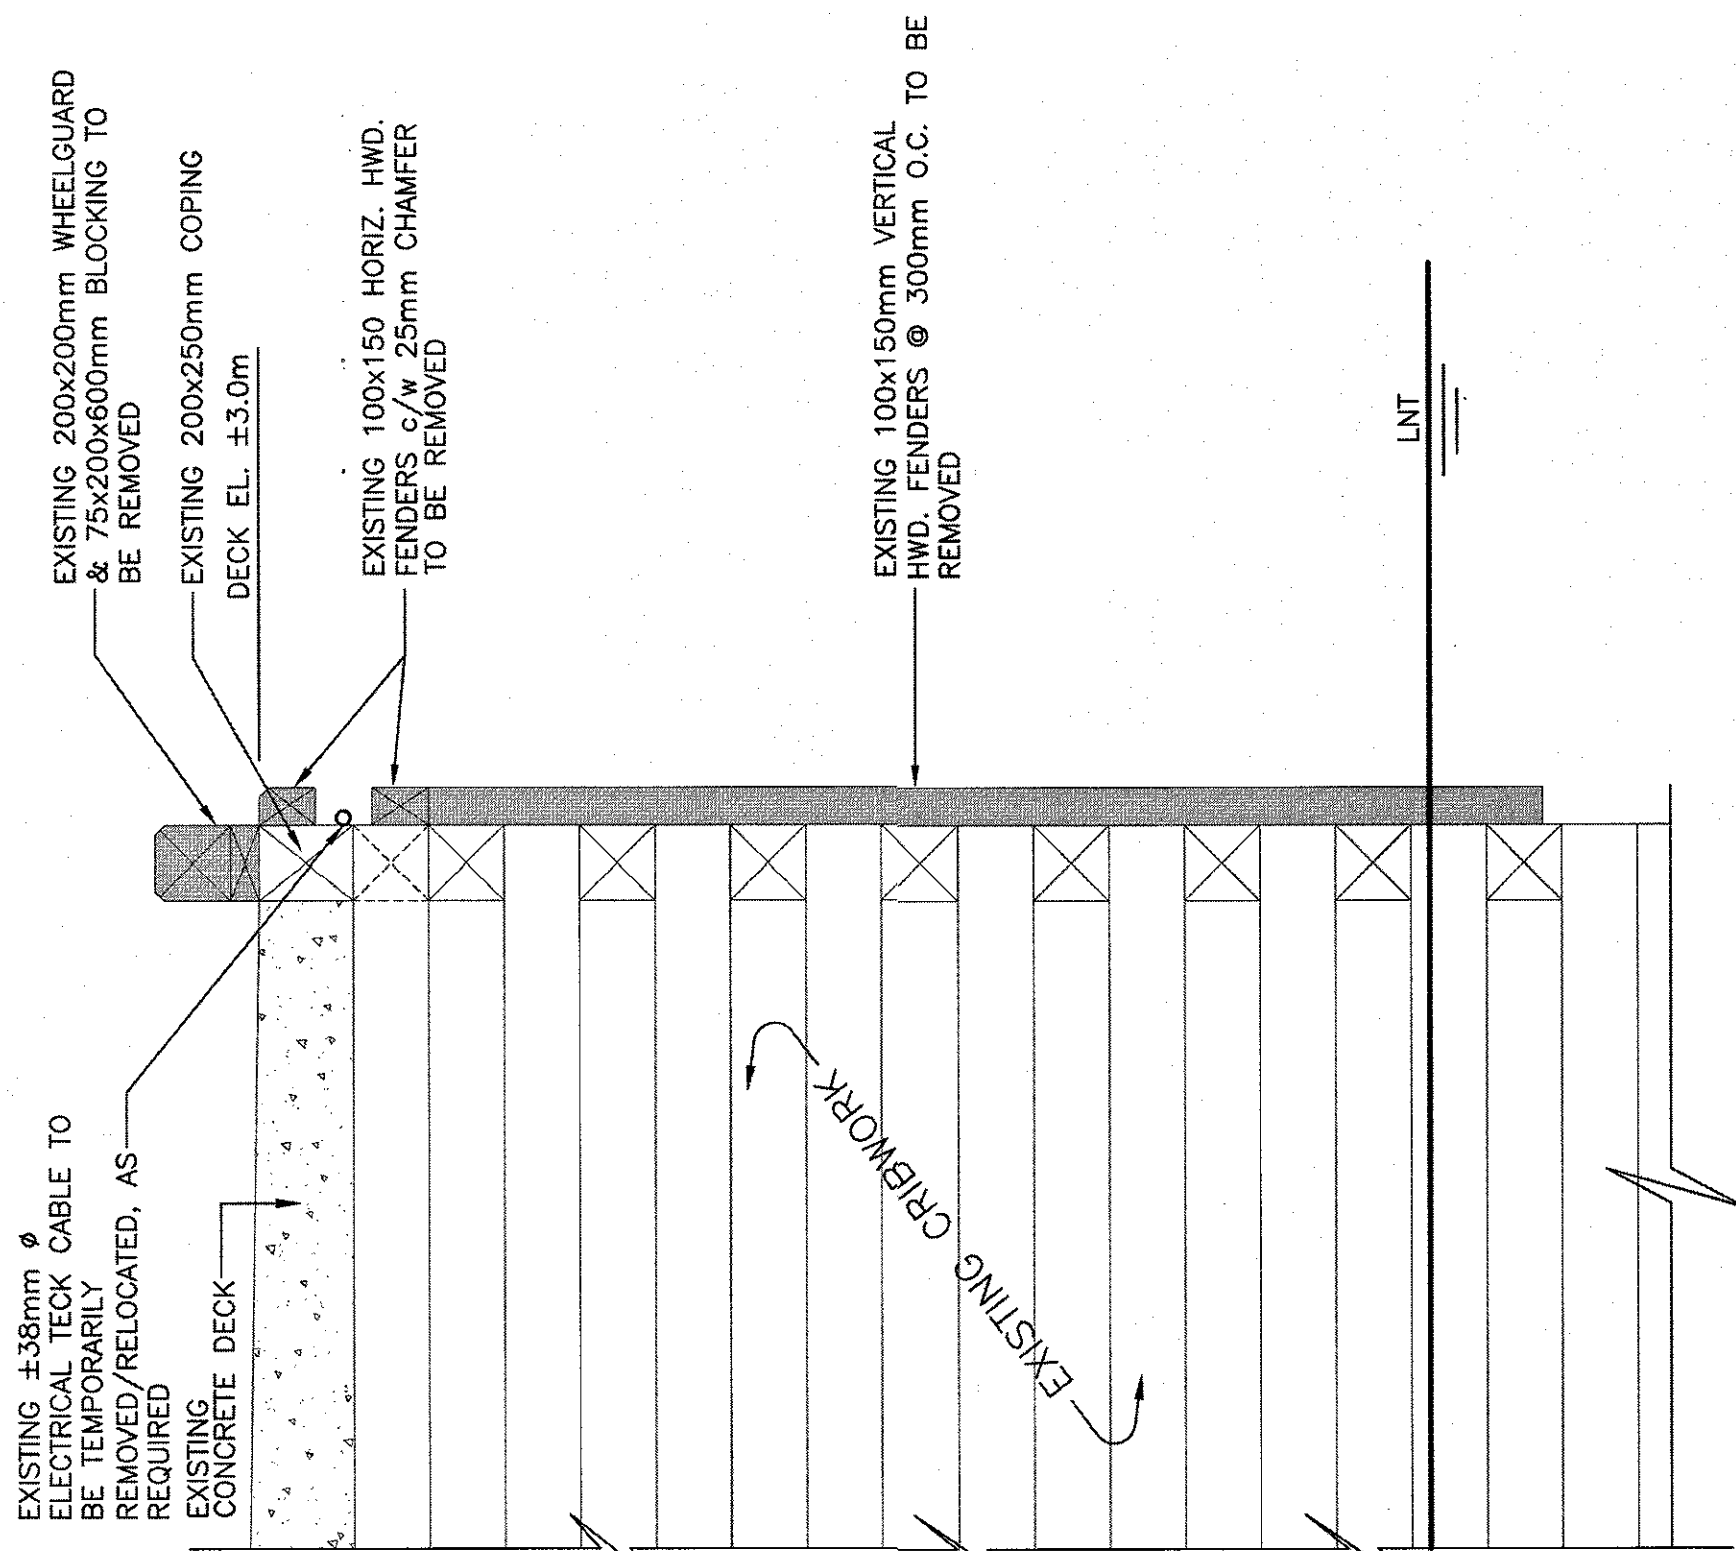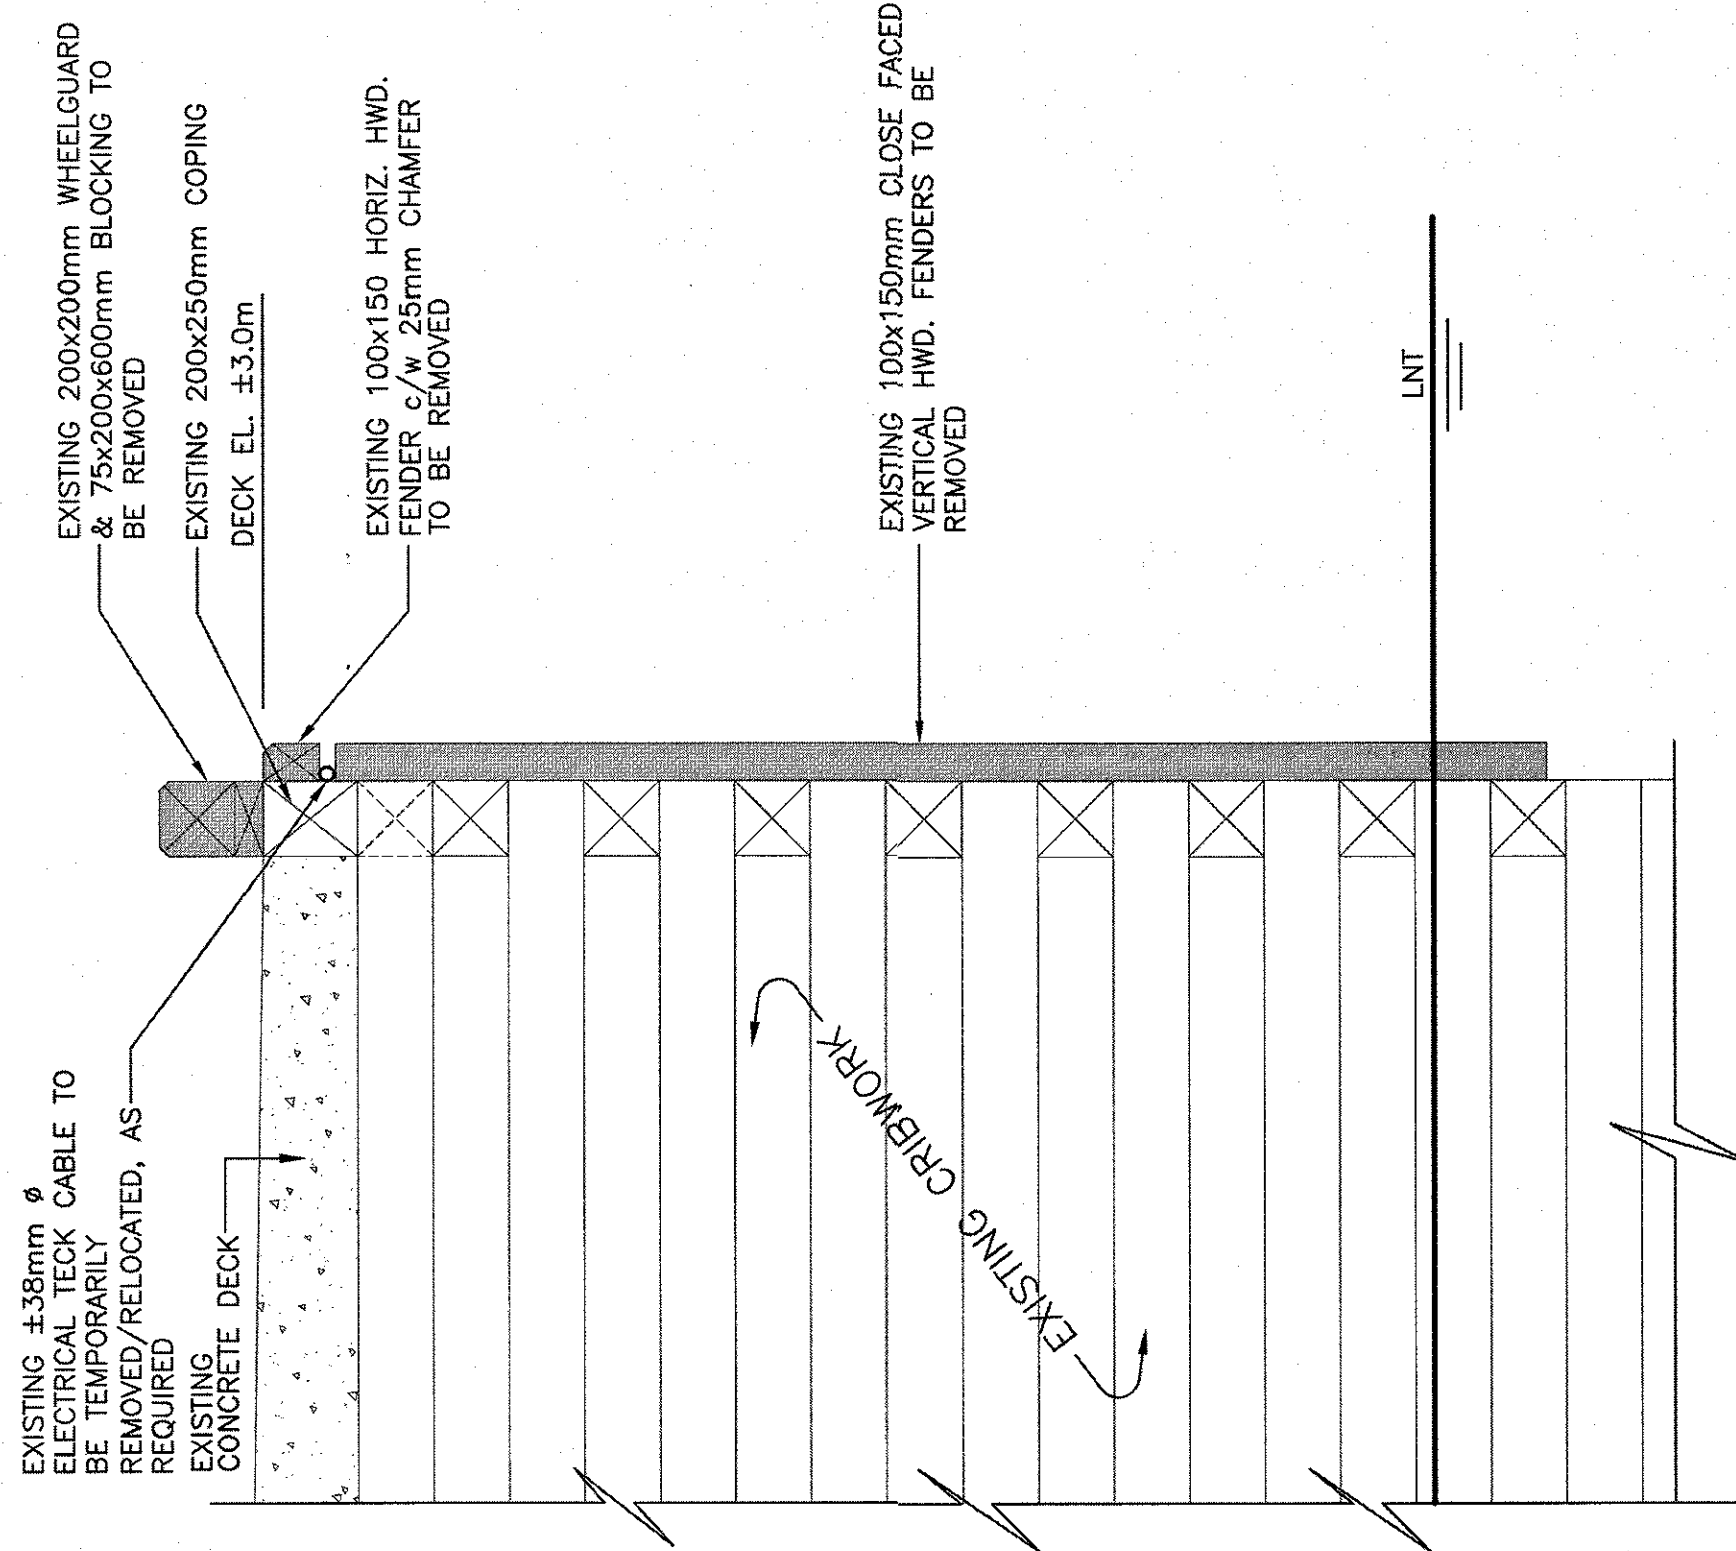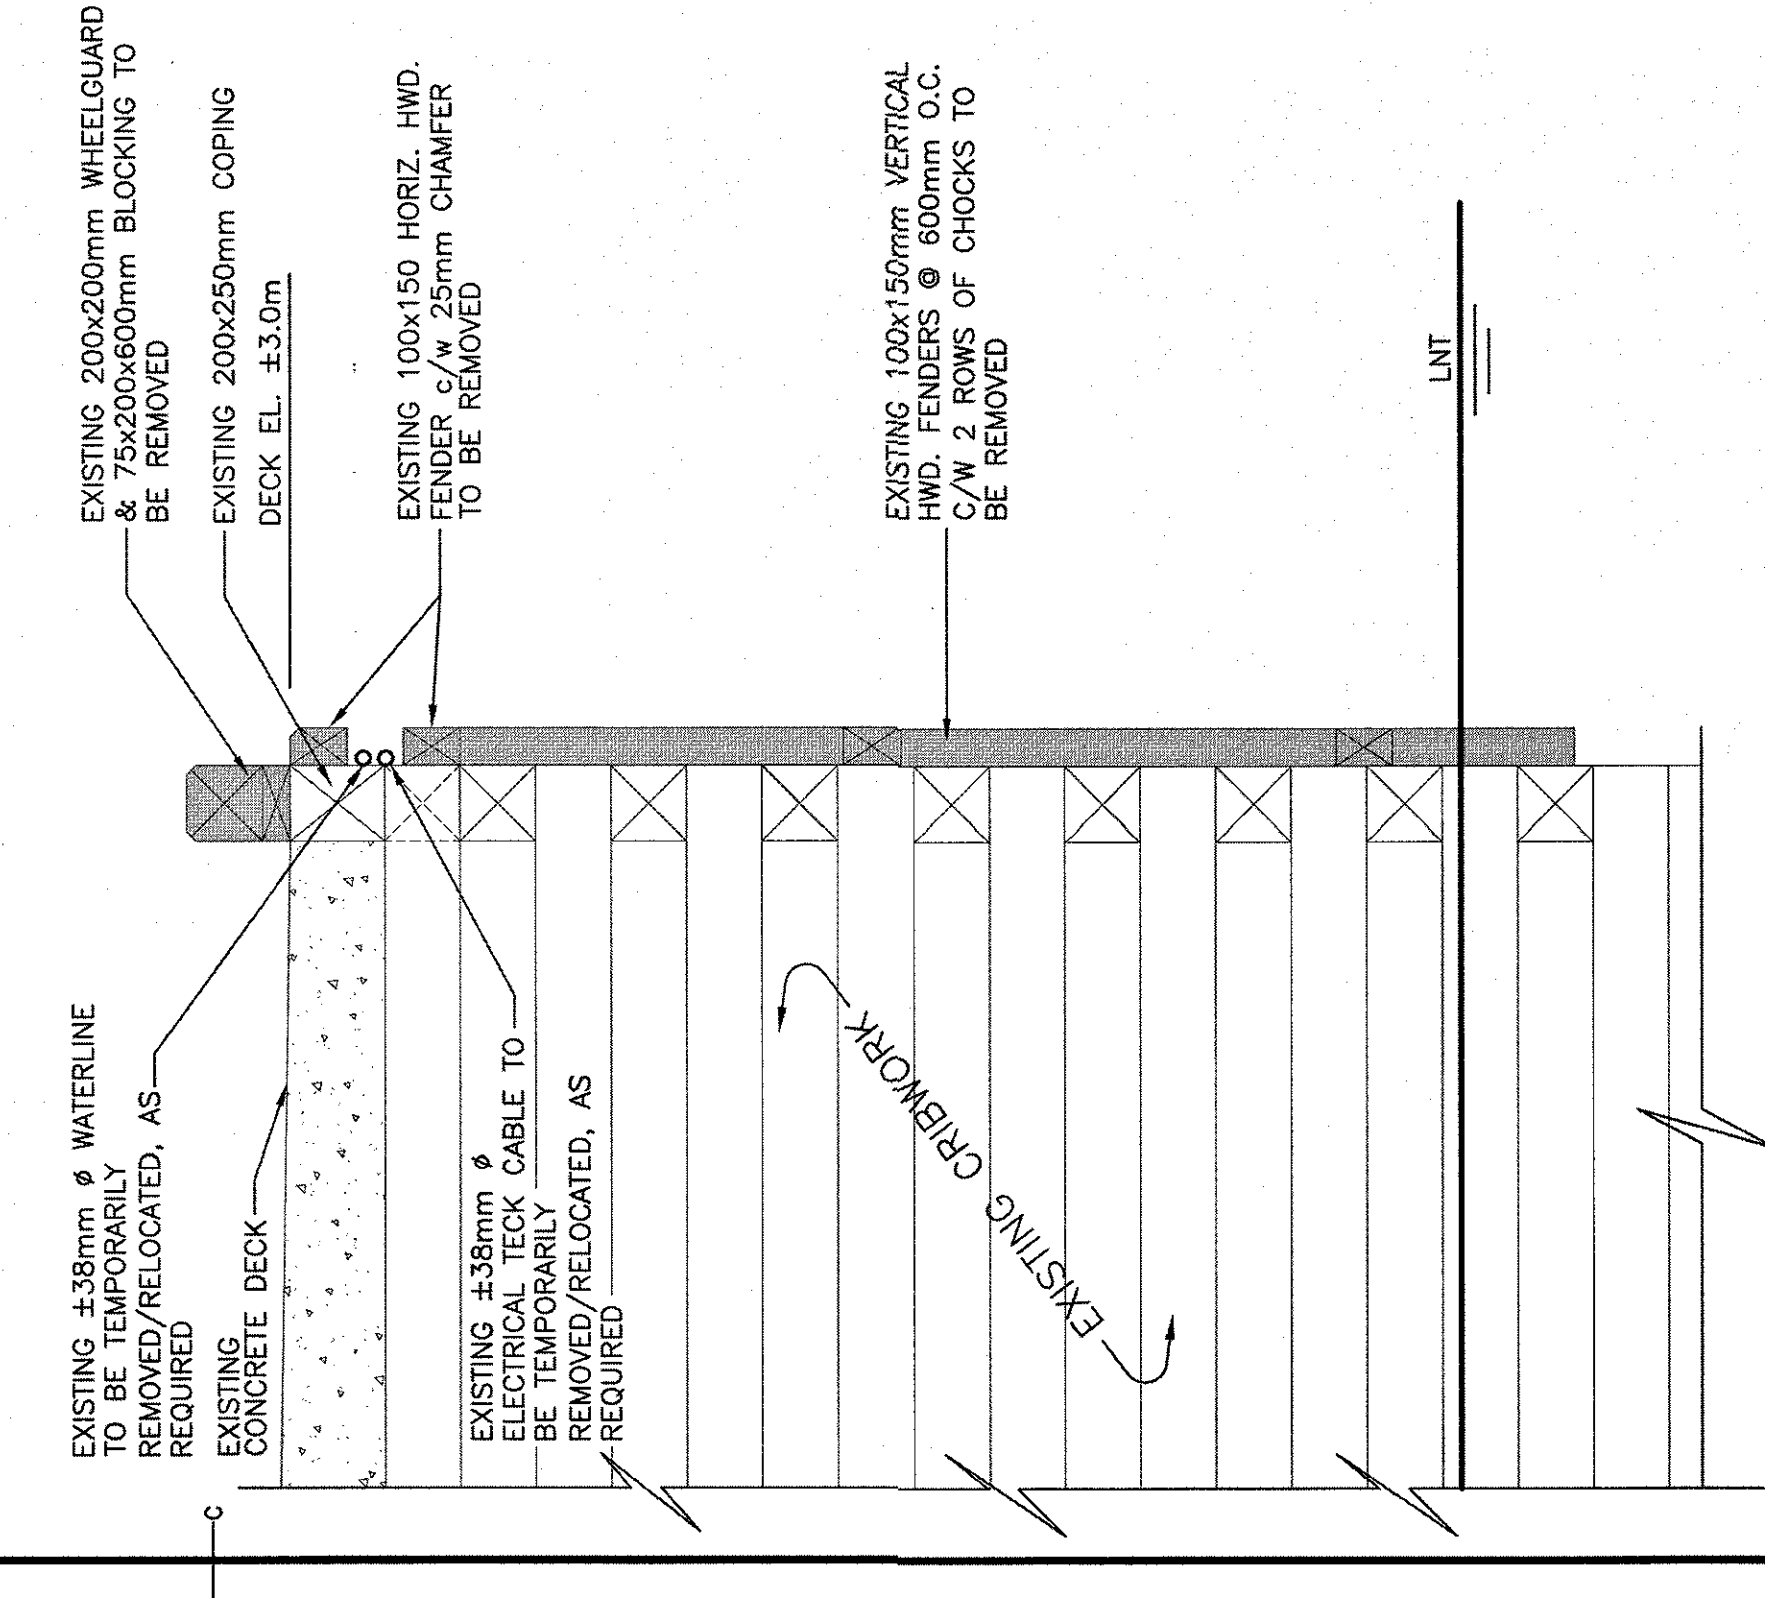


2 EXISTING DEMOLITION SECTION B

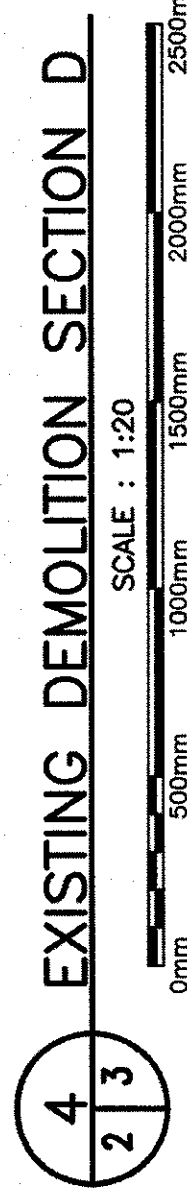

4 EXISTING DEMOLITION SECTION D

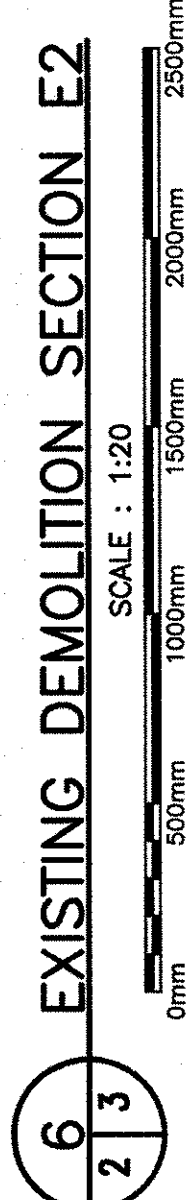

6 EXISTING DEMOLITION SECTION E2

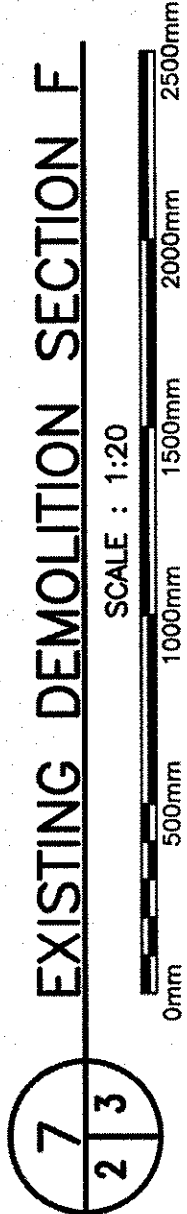

7 EXISTING DEMOLITION SECTION F

WHARF
REPAIRS
LA SCIE, NL

					project
revisions	dette				project
A	ISSUED FOR 33% REVIEW	20/06/22			
B	ISSUED FOR 66% REVIEW	20/06/03			
C	ISSUED FOR 99% REVIEW	20/06/08			
D	ISSUED FOR TENDER	20/06/11			

drawing	dessin

EXISTING DEMOLITION
SECTIONS
WORK AREA #1

designed C	FISHER	conclu

designed C. FISHER
concu[illegible]

date MAY, 2020

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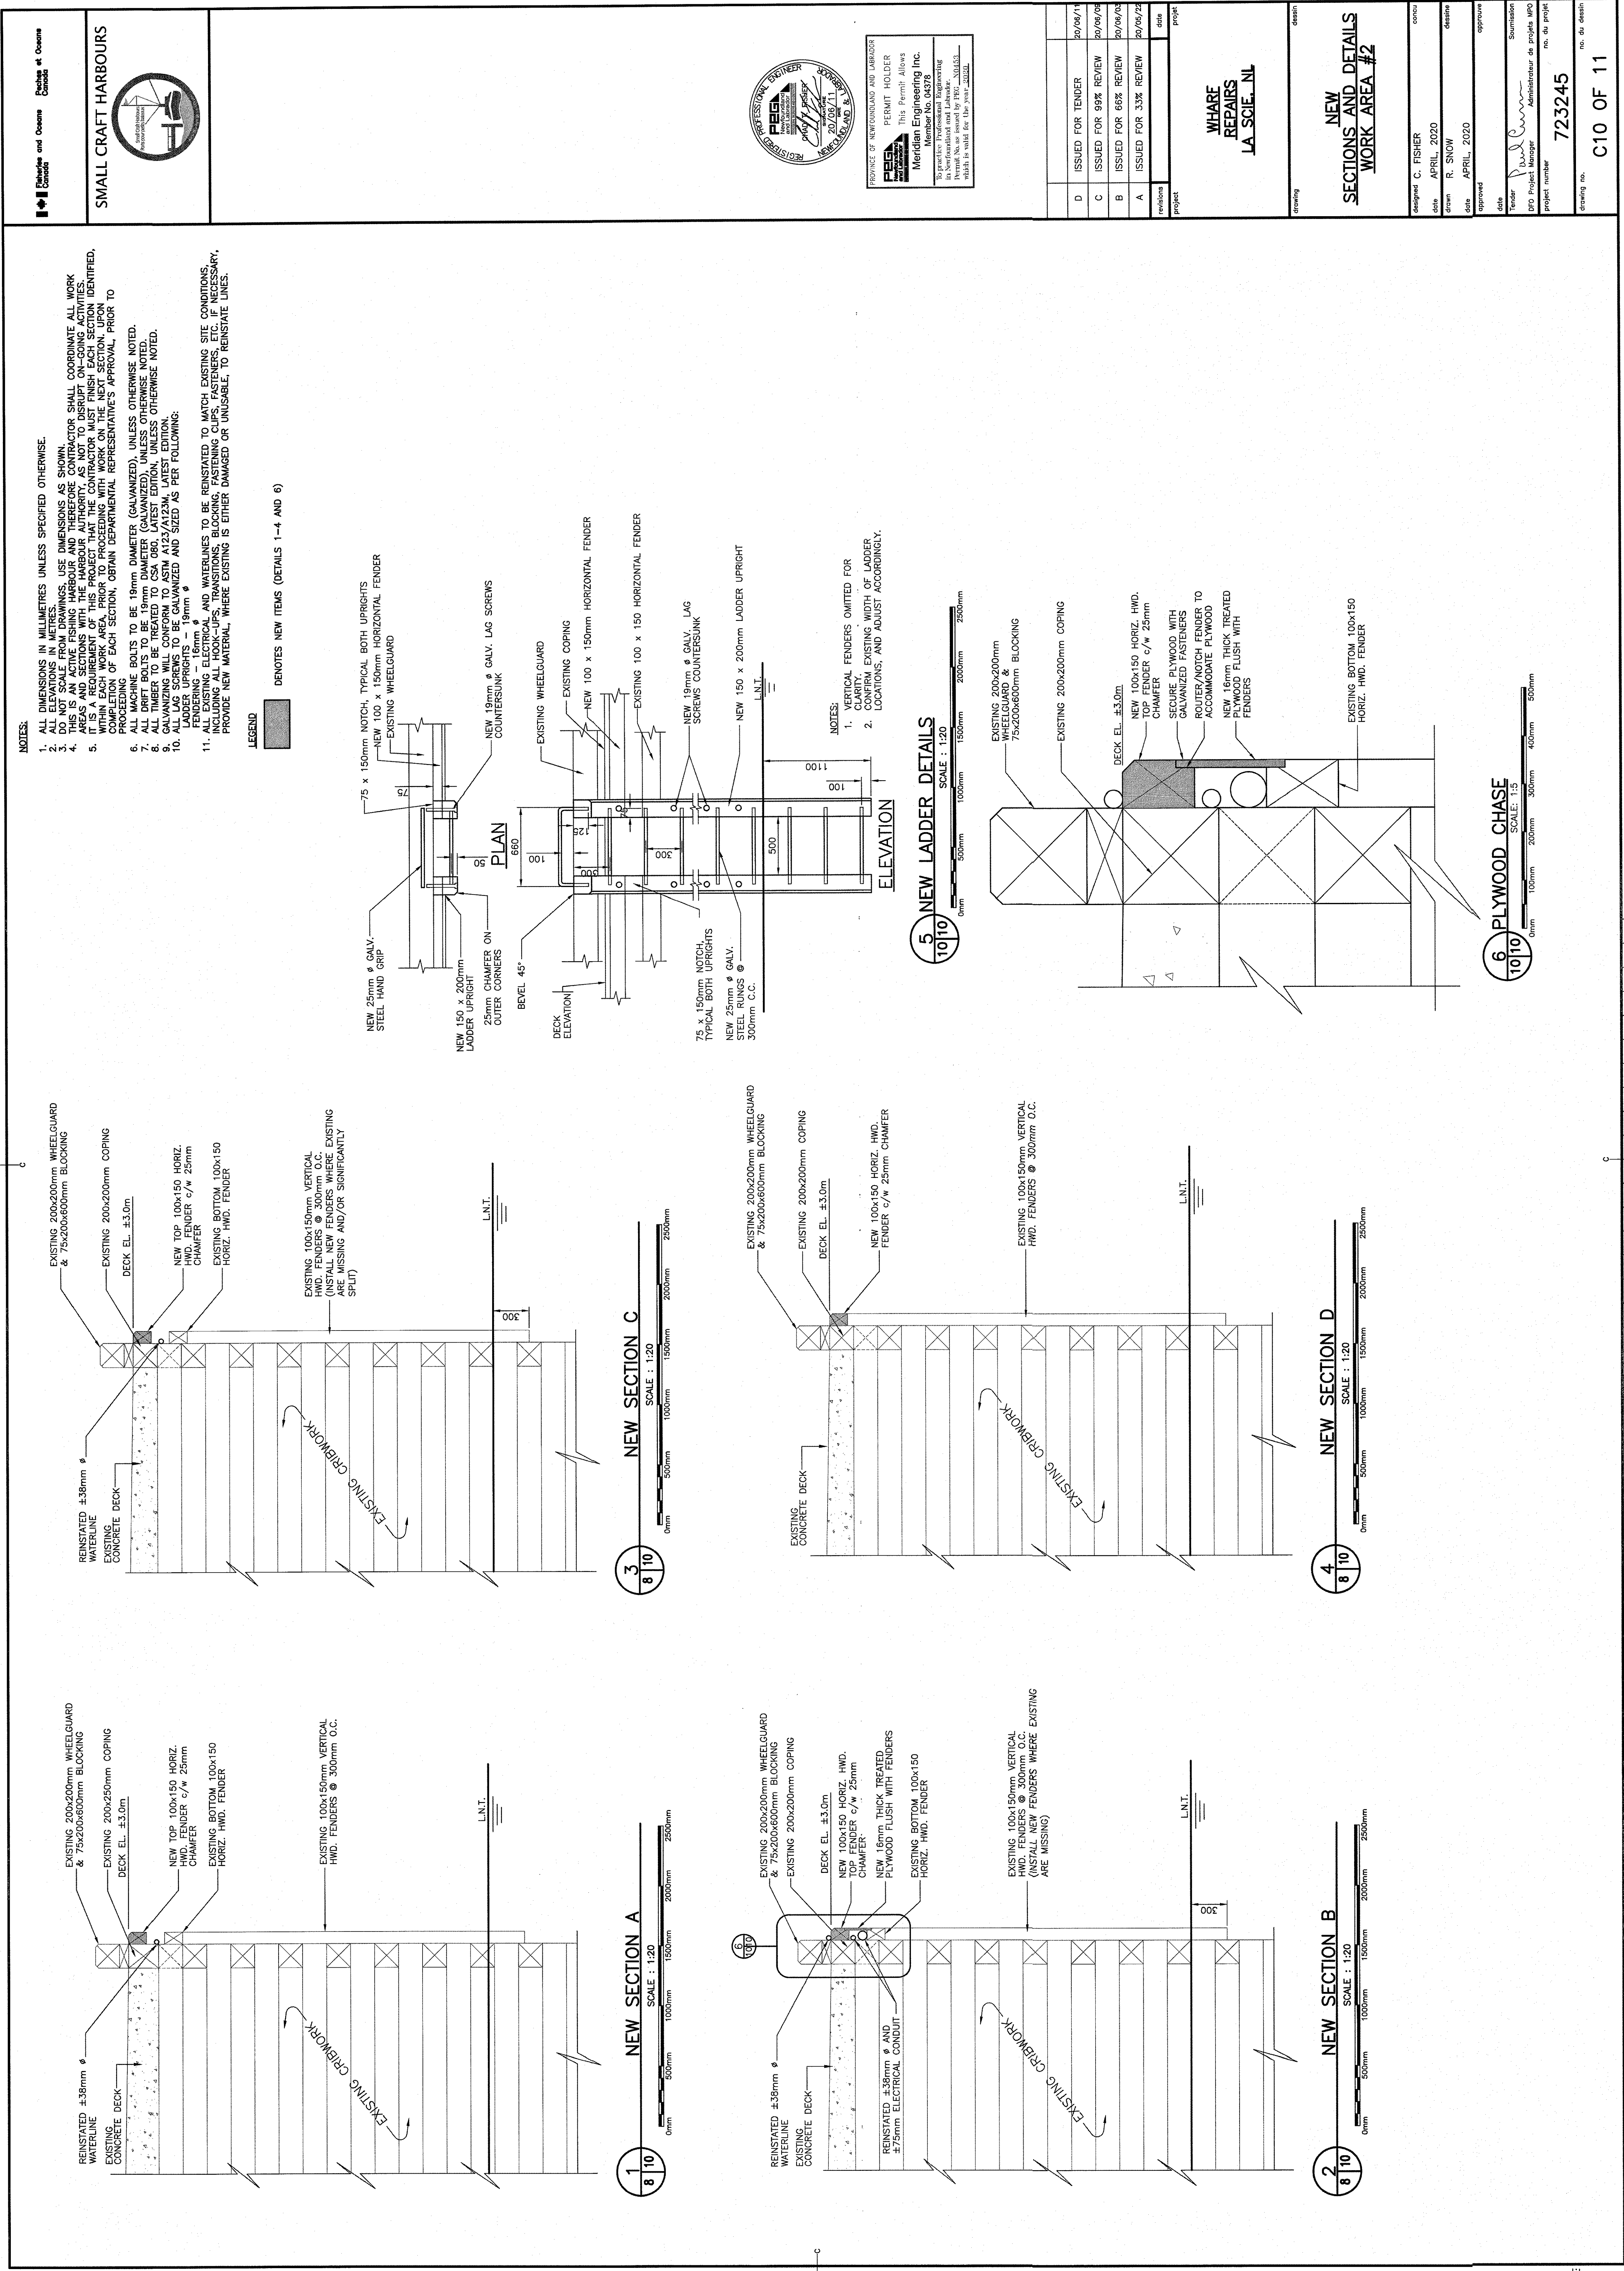
Tender	Submission

DFO Project Manager	Administrateur de projets MPO
---------------------	-------------------------------

793945

drawing no.	no. du dessin
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03 OF 11



- NOTES:
1. ALL DIMENSIONS IN MILLIMETRES UNLESS SPECIFIED OTHERWISE.
 2. ALL ELEVATIONS IN METRES.
 3. ALL FINISHINGS, USE DIMENSIONS AS SHOWN.
 4. THIS IS AN ACTIVE FISHING HARBOUR AND THEREFORE CONTRACTOR SHALL COORDINATE ALL WORK WITH THE HARBOUR AUTHORITY, AS NOT TO DISRUPT ON-GOING ACTIVITIES.
 5. IT IS A REQUIREMENT OF THIS PROJECT THAT THE CONTRACTOR MUST FINISH EACH SECTION IDENTIFIED, WITHIN EACH WORK AREA PRIOR TO PROCEEDING TO THE NEXT SECTION. PRIOR TO THE APPROVAL OF EACH SECTION, OBTAIN DEPARTMENTAL REPRESENTATIVE'S APPROVAL, PRIOR TO PROCEEDING.
 6. ALL MACHINE BOLTS TO BE 19mm DIAMETER (GALVANIZED), UNLESS OTHERWISE NOTED.
 7. ALL DRIFT BOLTS TO BE 19mm DIAMETER (GALVANIZED), UNLESS OTHERWISE NOTED.
 8. ALL TIMBER TO BE TREATED TO CSA 060, LATEST EDITION, UNLESS OTHERWISE NOTED.
 9. ALL LAG BOLTS TO BE 19mm DIAMETER (GALVANIZED), UNLESS OTHERWISE NOTED.
 10. ALL LAG BOLTS TO BE GALVANIZED AND SIZED AS PER FOLLOWING:
LAGGER UPRIGHTS - 19mm
FENDERING - 16mm
FENDER - 16mm
NEW 100x150mm HORIZ. FENDER C/W 25mm CHAMFER
 11. ALL EXISTING ELECTRICAL AND WATERLINES TO BE RENOVATED TO MATCH EXISTING SITE CONDITIONS. PROVIDE NEW MATERIAL, WHERE EXISTING IS EITHER DAMAGED OR UNUSABLE, TO RENOVATE LINES.

LEGEND

■ DENOTES NEW ITEMS (DETAILS 1-4 AND 6)



PROVINCE OF NEWFOUNDLAND AND LABRADOR
PERMIT HOLDER
This Permit Allows
Meridian Engineering Inc.
No. 83378
To practice Professional Engineering
in Newfoundland and Labrador.
Permit No. 83378
Valid to 2024-09-30

D	ISSUED FOR TENDER	20/06/11
C	ISSUED FOR 98% REVIEW	20/06/09
B	ISSUED FOR 66% REVIEW	20/06/03
A	ISSUED FOR 33% REVIEW	20/05/25
revisions		
project		

WHARE
REPAIRS
LA SCIE, NL

desain	
SECTION AND DETAILS WORK AREA #2	

desain	C. FISHER
date	APRIL, 2020
drawn	R. SNOW
date	APRIL, 2020
approved	
date	
Submitted	
Project Manager	
no. of project	723245
no. du dessin	C10 OF 11

