




**PART ROOF PLAN**  
SCALE: 1:400

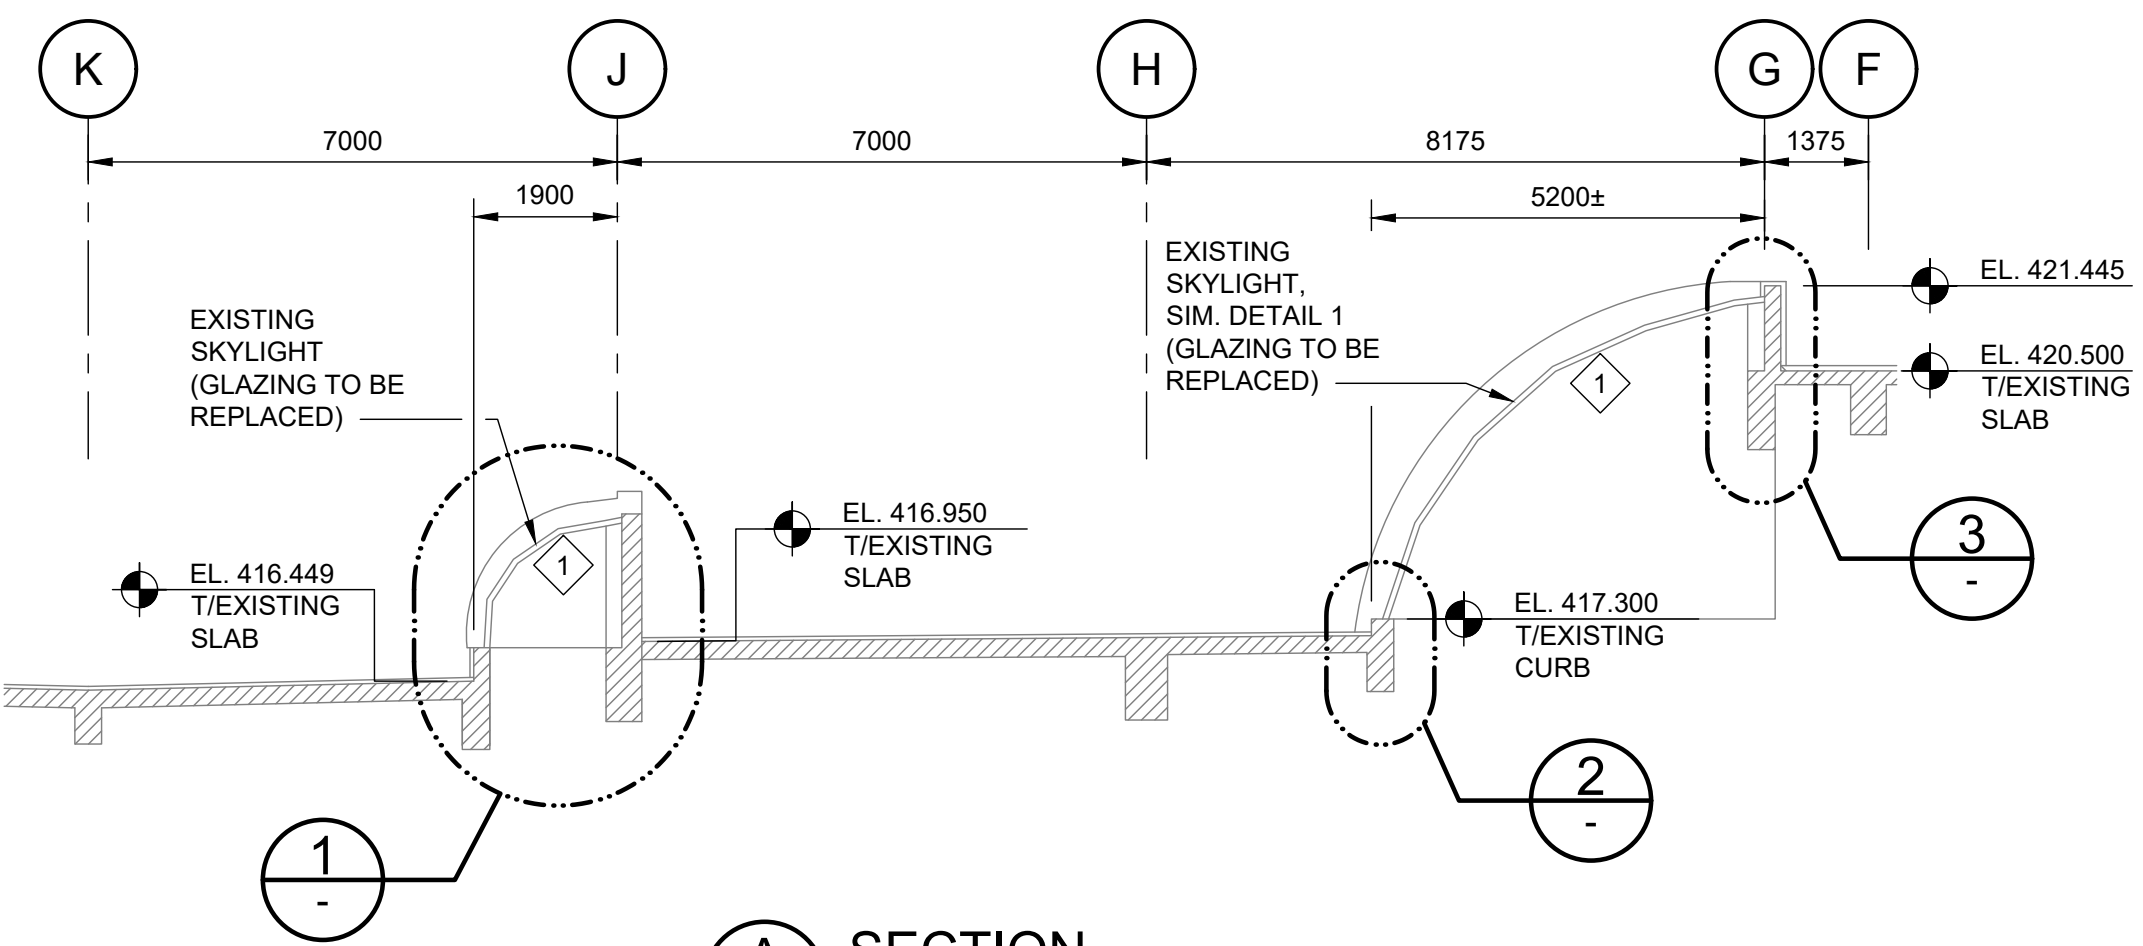


**SECTION A**  
SCALE: 1:100

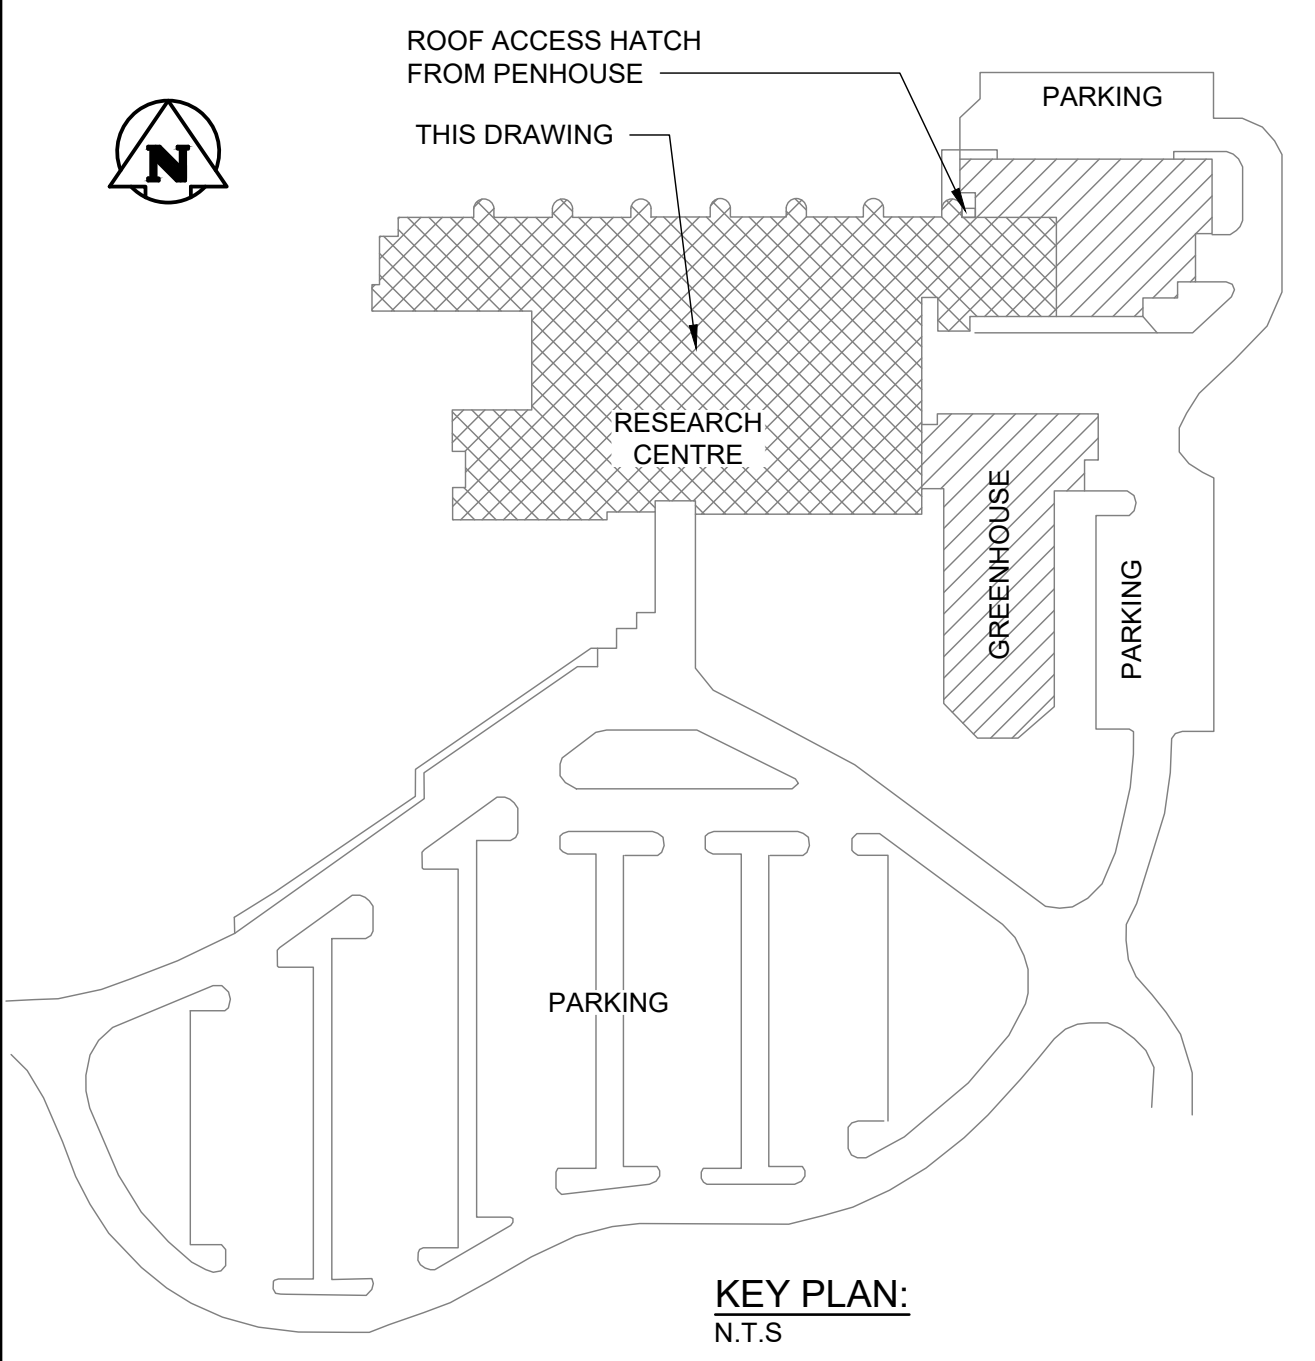


**KEY PLAN:**  
N.T.S.

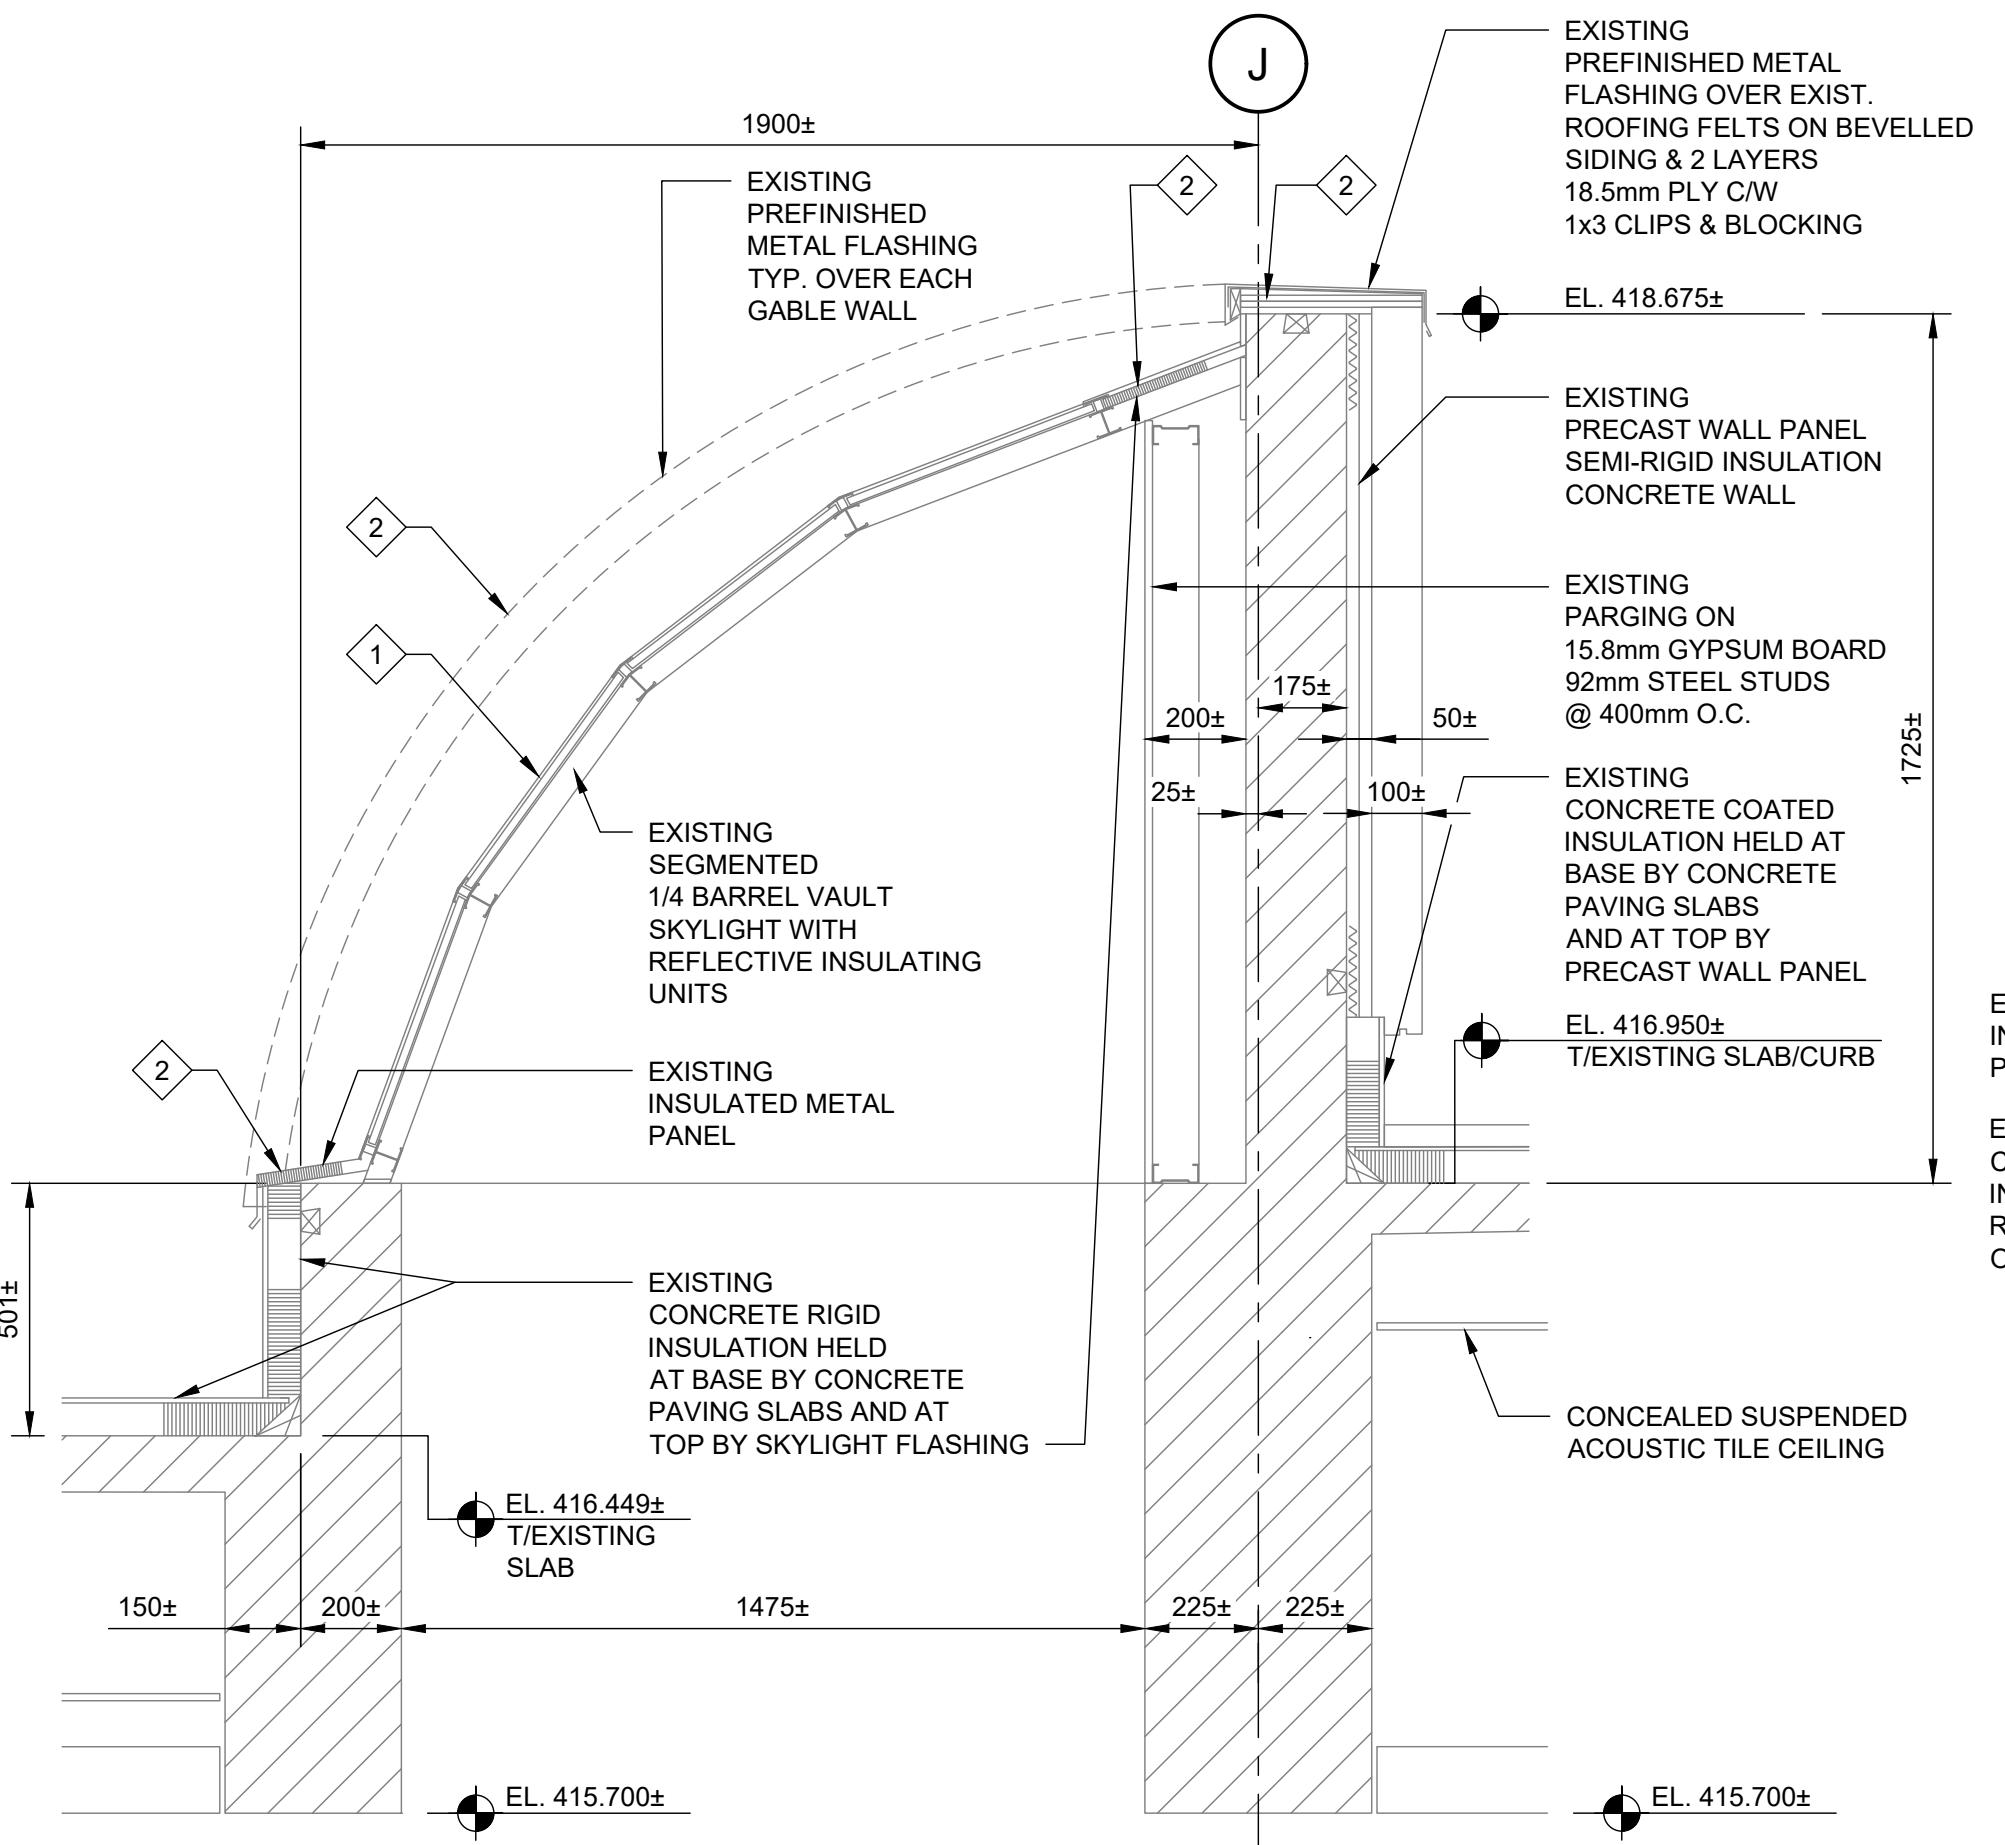

**1 DETAIL**  
SCALE: 1:15

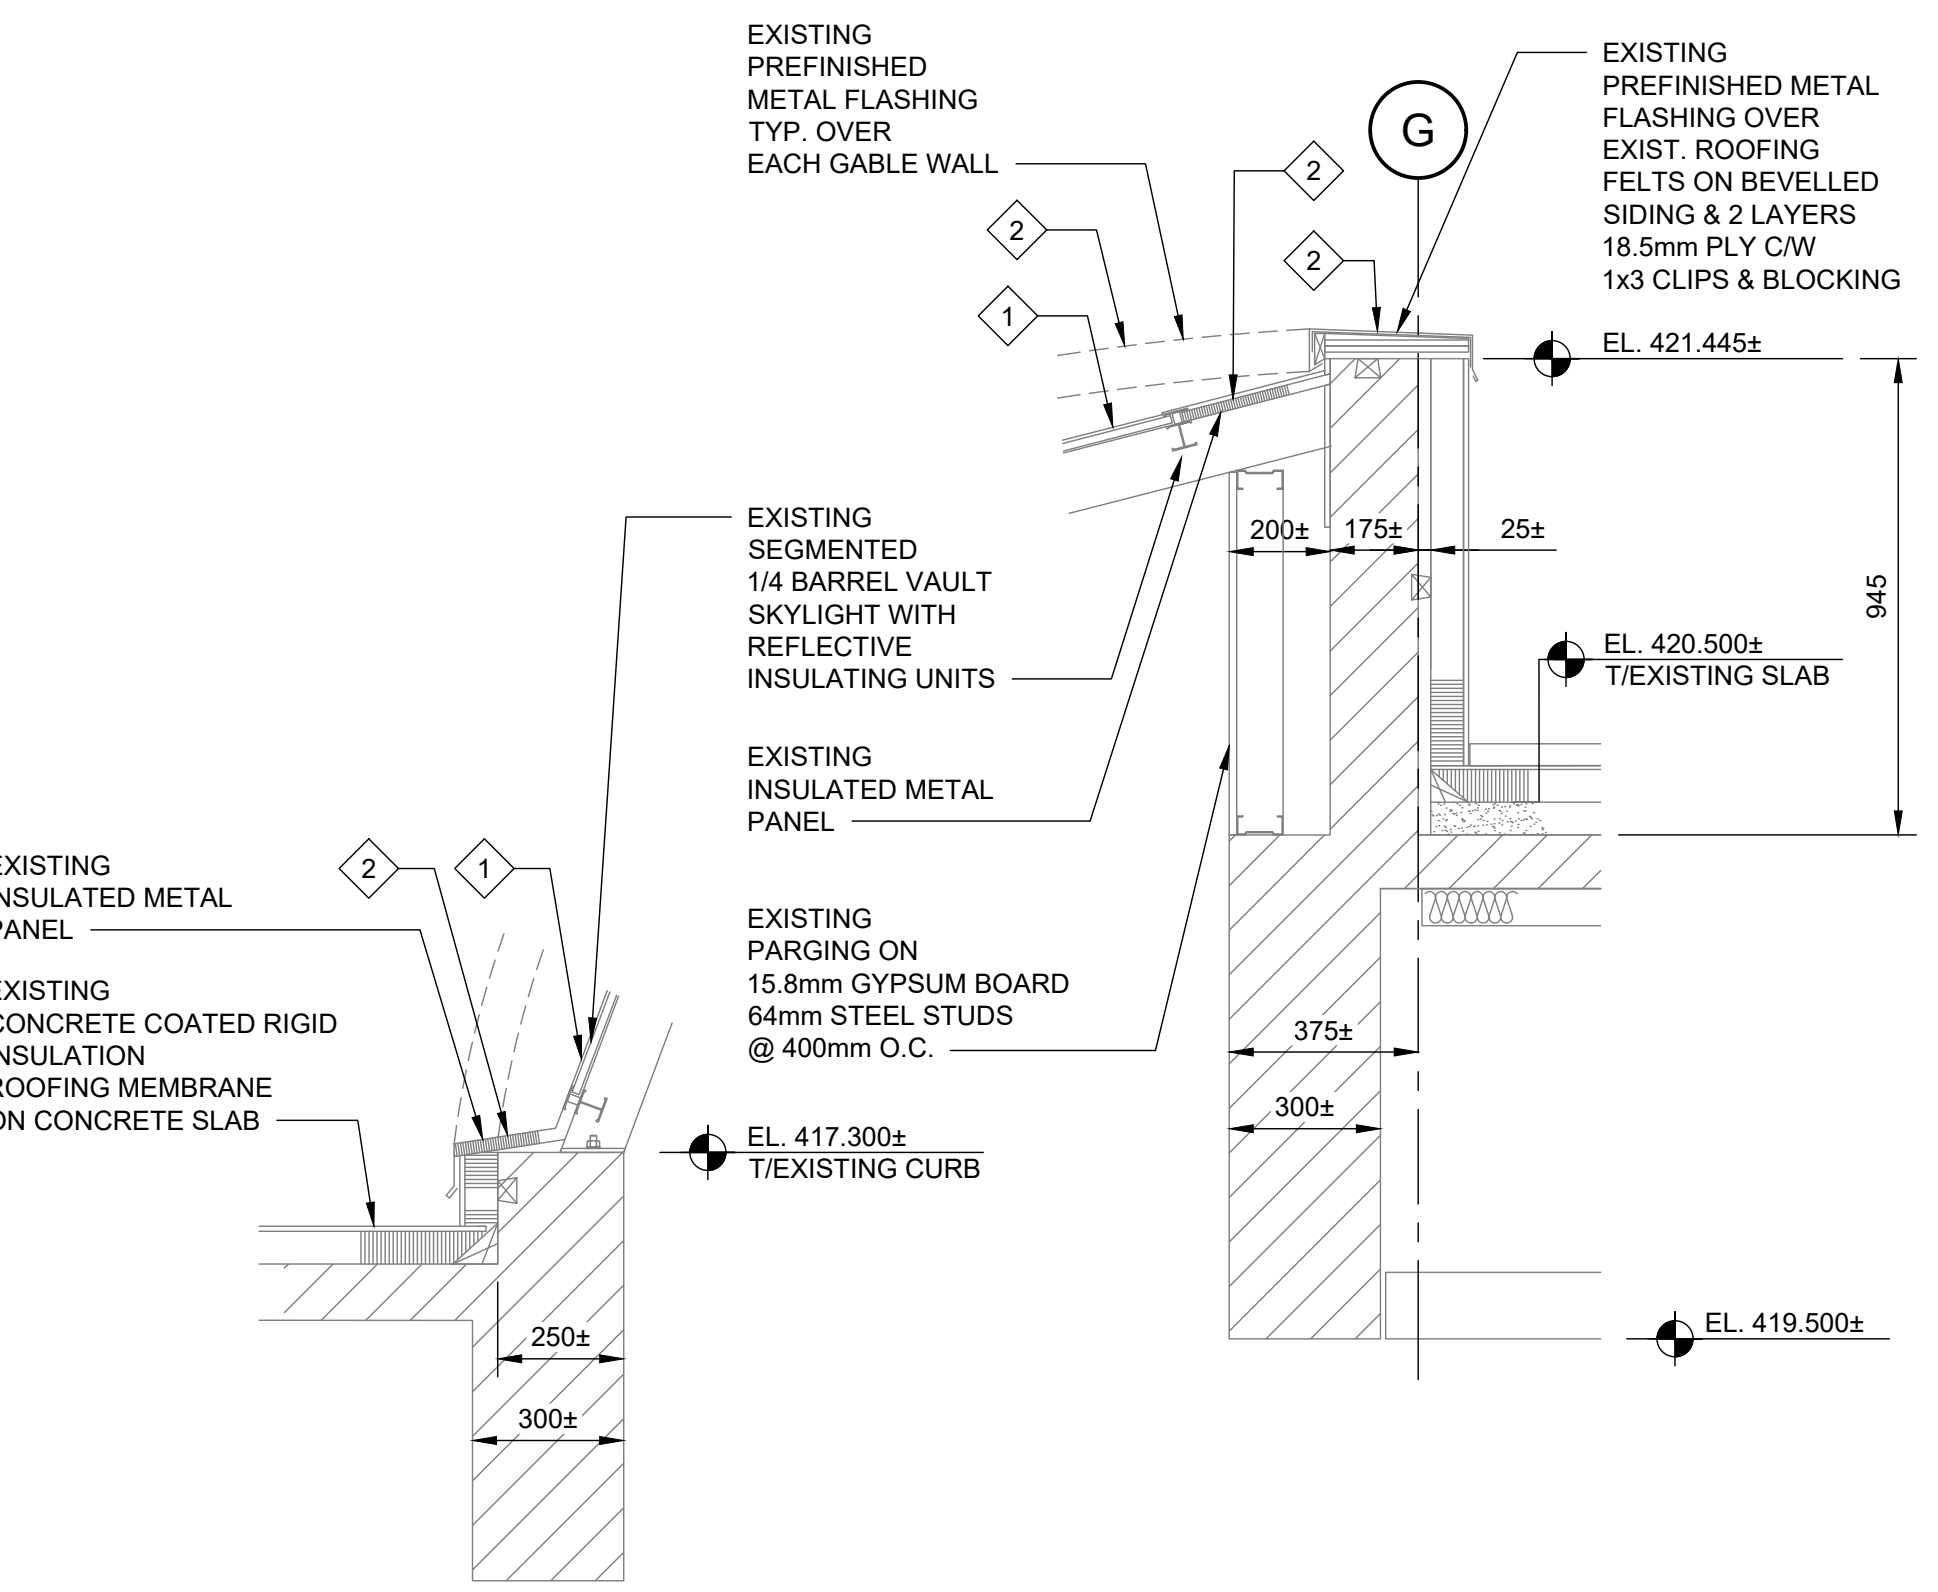

**2 DETAIL**  
SCALE: 1:15

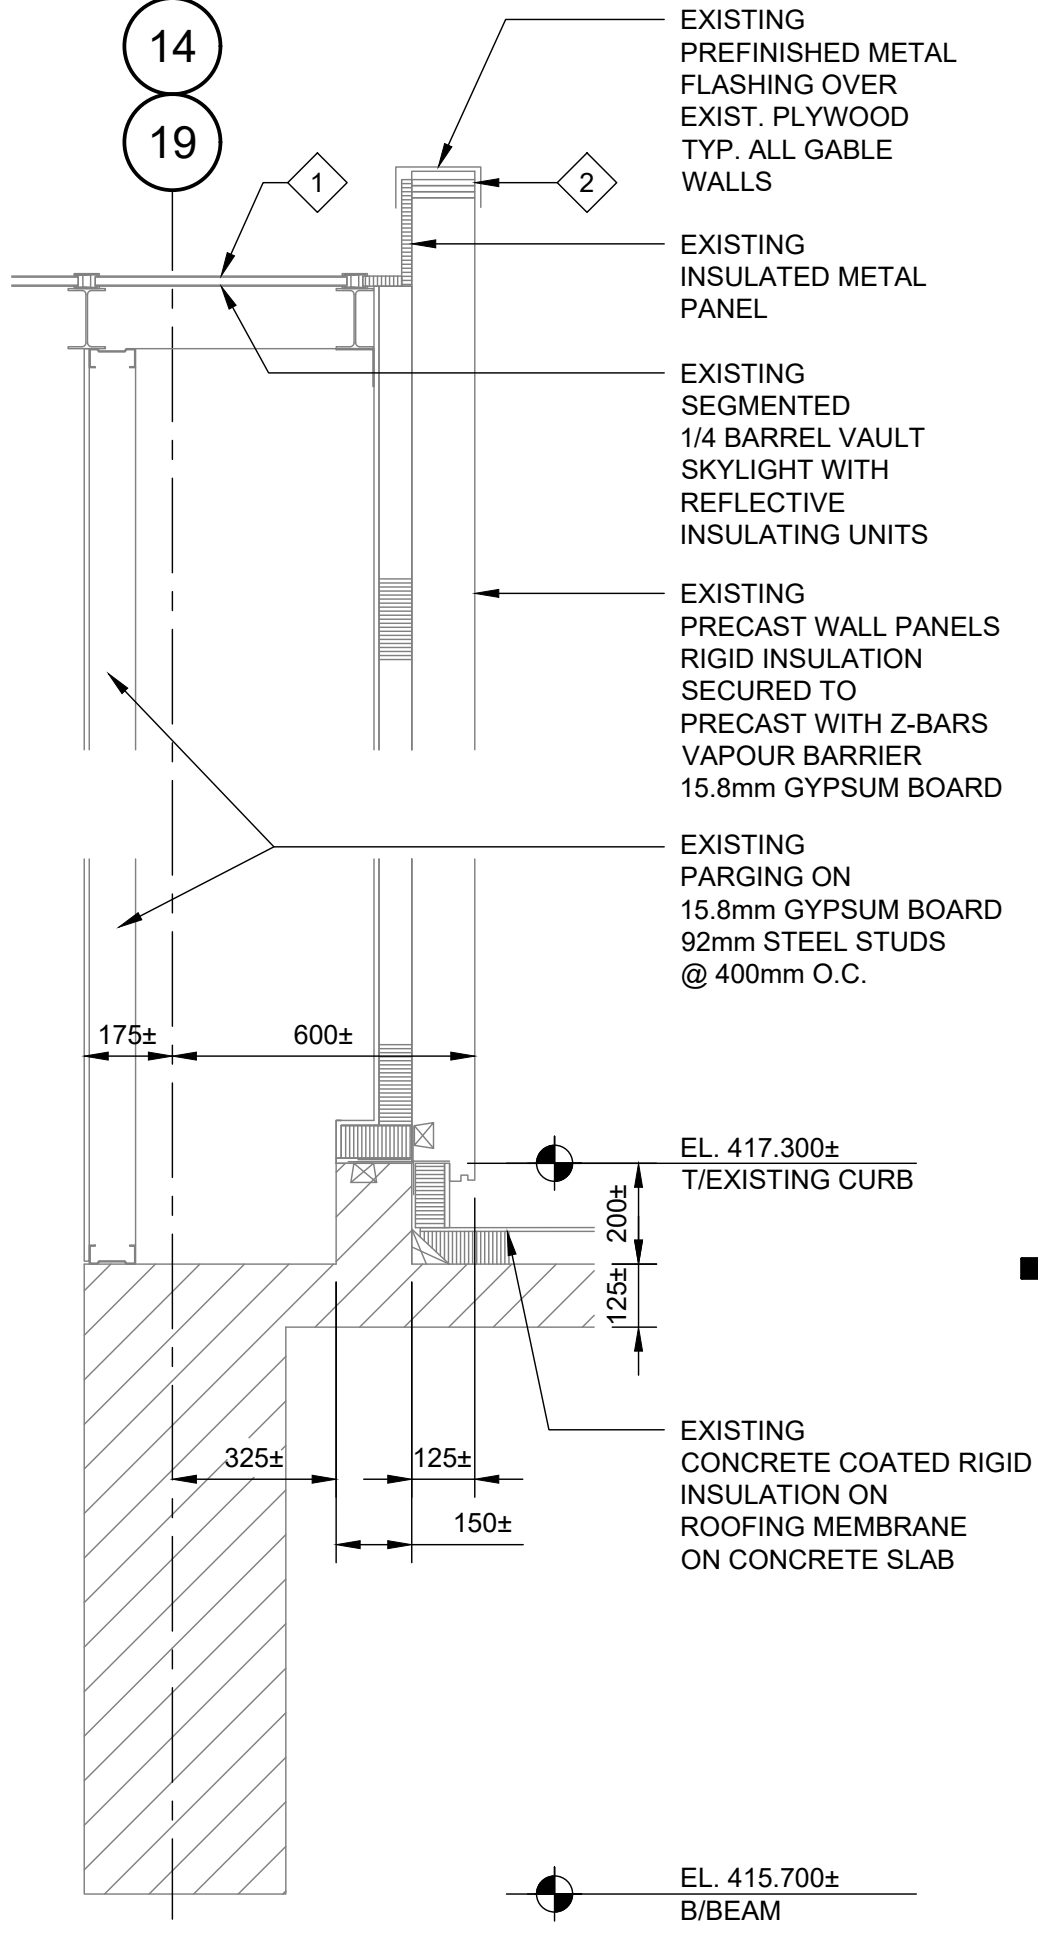

**SECTION B**  
SCALE: 1:15

**CONSTRUCTION KEYNOTES:**

- 1 REMOVE ALL GLAZING UNITS. ALL TRACKS AND FRAMING TO BE CLEANED AND TO REMAIN. INSTALL NEW DUAL PANE, ARGON FILLED GLAZING UNITS WITH LOW-E COATING. INSTALL NEW PRESSURE PLATES AND CAPS TO MATCH EXISTING.
- 2 REMOVE AND REPLACE PREFINISHED METAL FLASHING. FINISH ON NEW FLASHING TO MATCH EXISTING. INSTALL SEALANT IN ACCORDANCE WITH MANUFACTURER'S RECOMMENDATION AND AS REQUIRED BY THE PROJECT SPECIFICATIONS.

NO.	YY/MM/DD	DESCRIPTION	DESIGN BY	DESIGN CHECK
0	20/07/23	ISSUED FOR CONSTRUCTION	DJS	

**REVISIONS / ISSUE**

CLIENT:  
**Agriculture and Agri-Food Canada**

PROJECT:  
**SKYLIGHT GLAZING REPLACEMENT  
AGRICULTURAL RESEARCH CENTRE  
SUMMERLAND, B.C.**

DWG. DESCRIPTION:  
**BUILDING  
PART ROOF - SKYLIGHTS  
PLAN, SECTIONS & DETAILS**

DESIGN BY	DATE (YY/MM/DD)
DJS	20/06/11
DESIGN CHECK	DATE
	20/07/23
DRAWN BY	DATE
FBV	20/06/11
DWG. CHECK	DATE
	20/07/23

DWG. NO. **20-0217-001** B01 REV **0**