
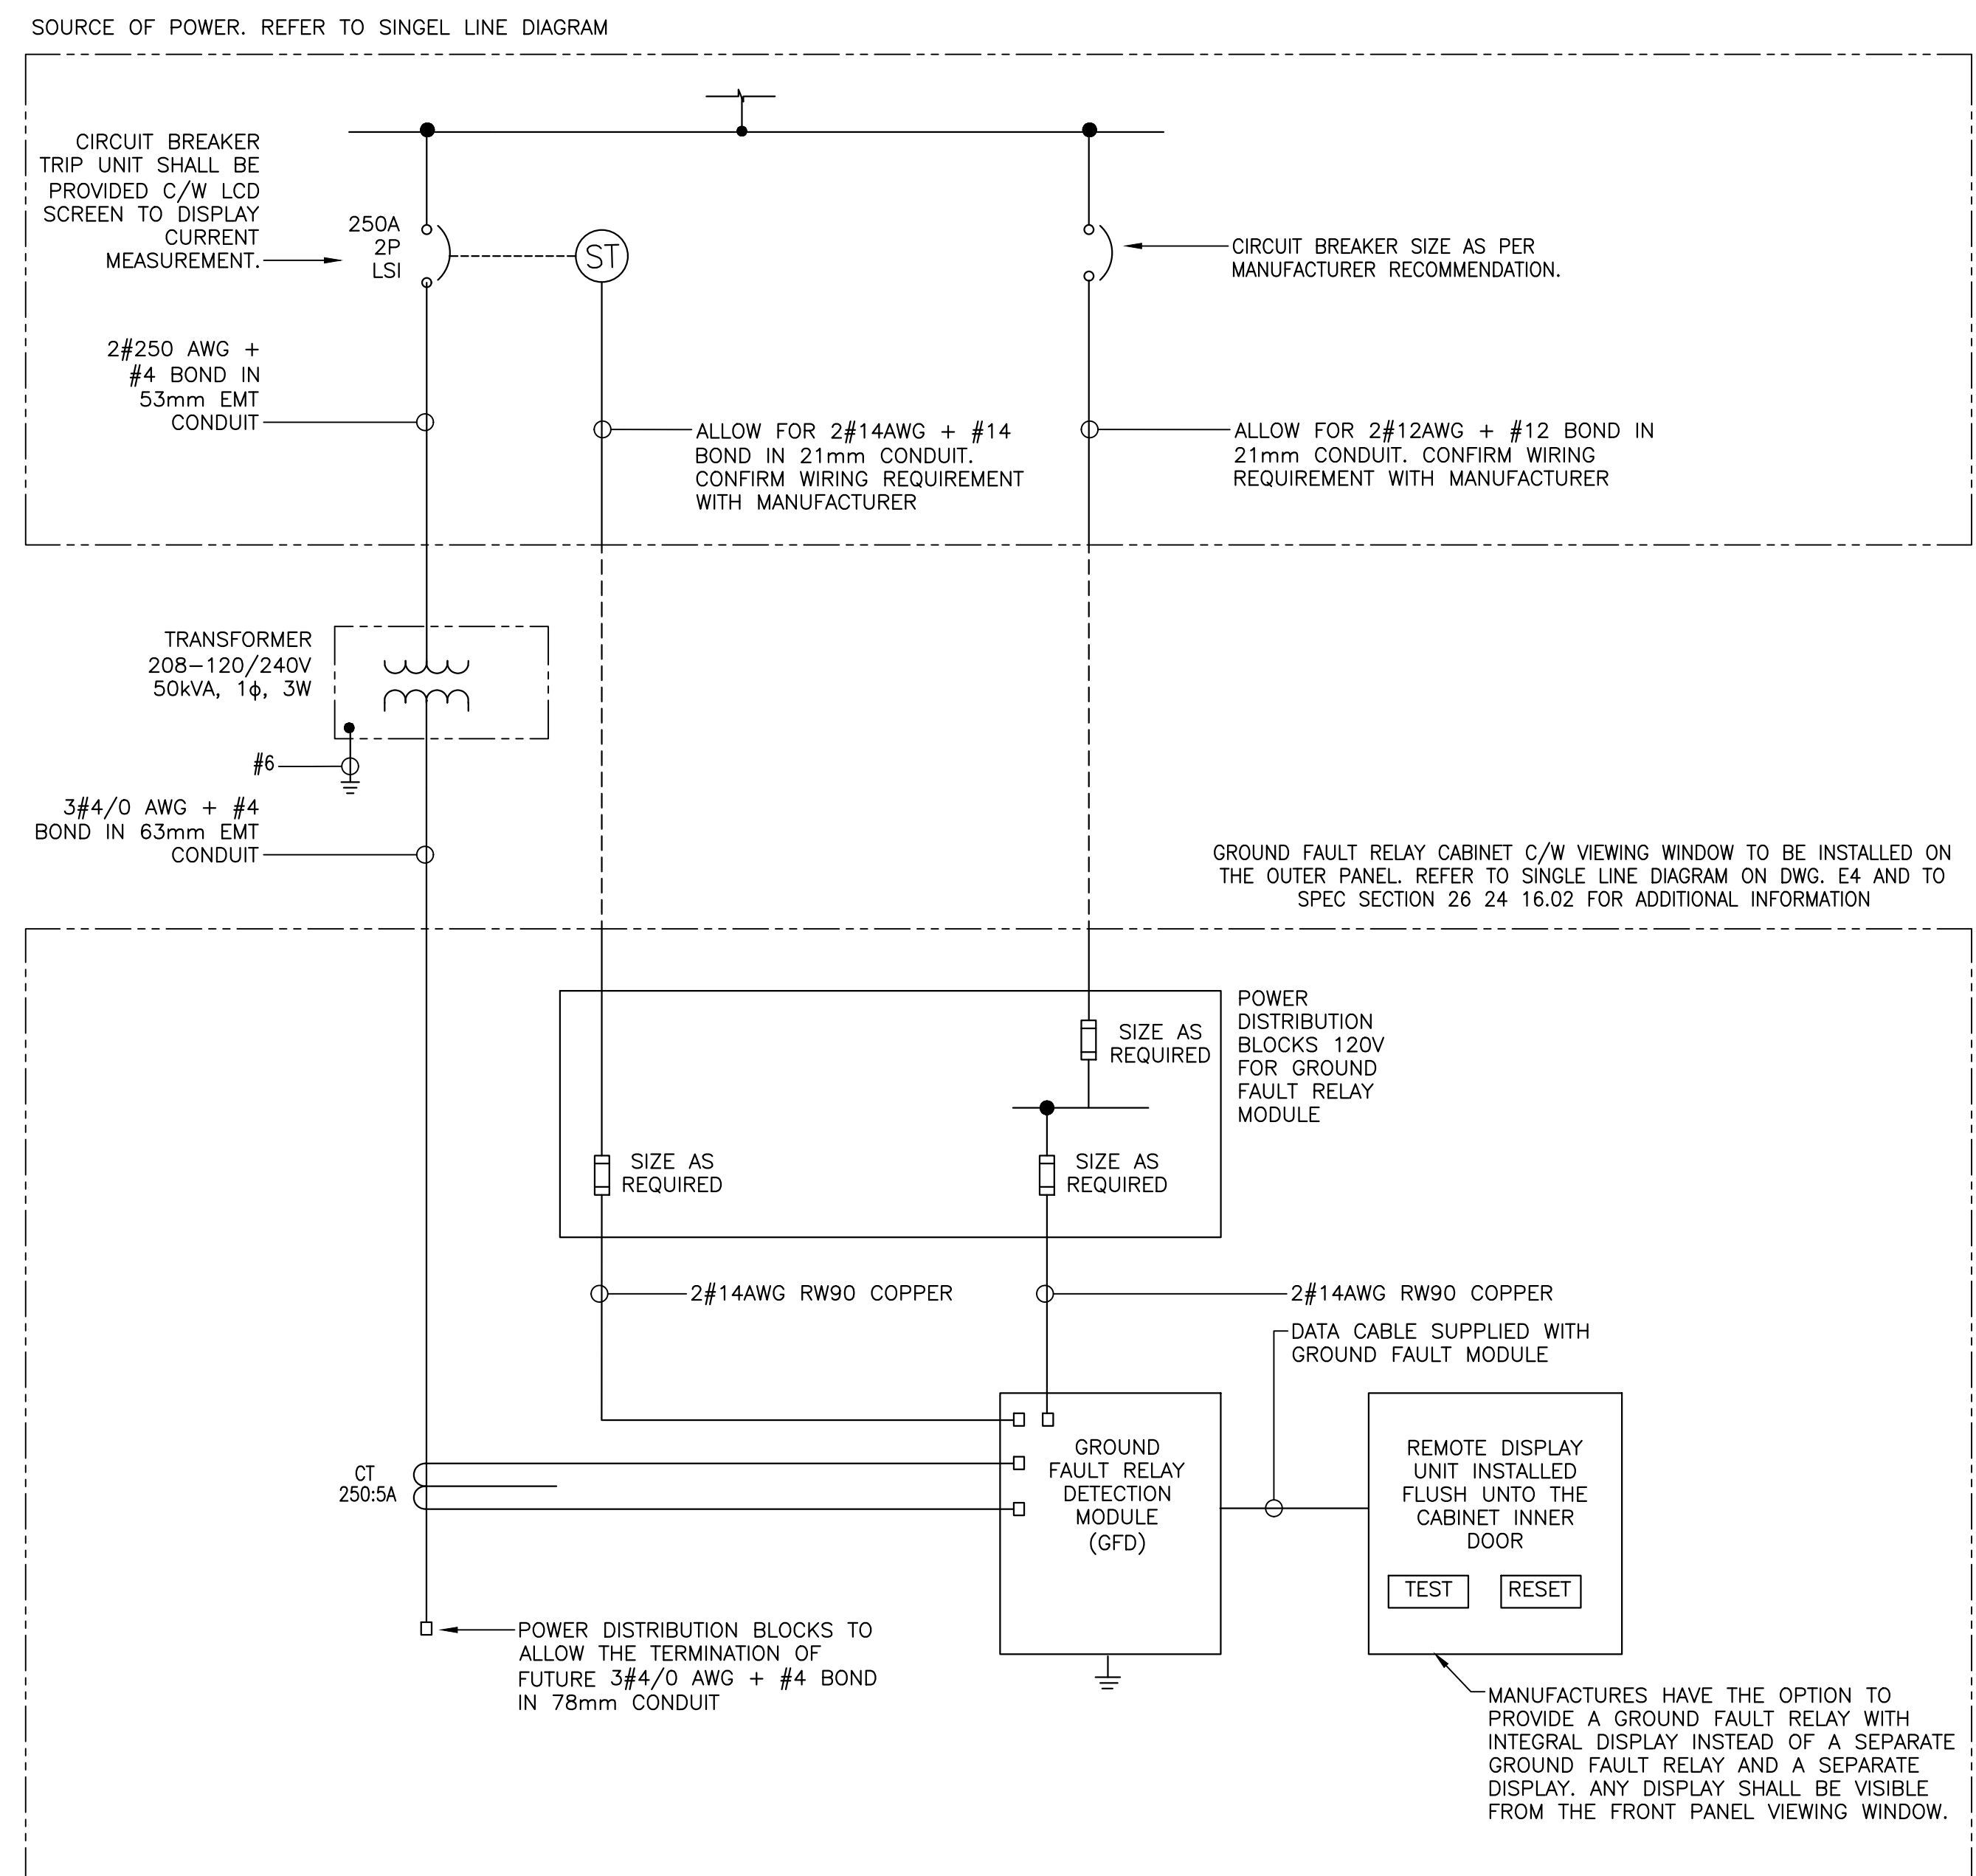




EMERGENCY GENERATOR CONTROL DIAGRAM

SCALE : N.T.S.

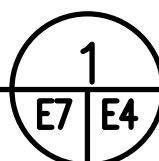


SCHEMATIC – TYPICAL GROUND FAULT RELAY CABINET

SCALE : N.T.S.

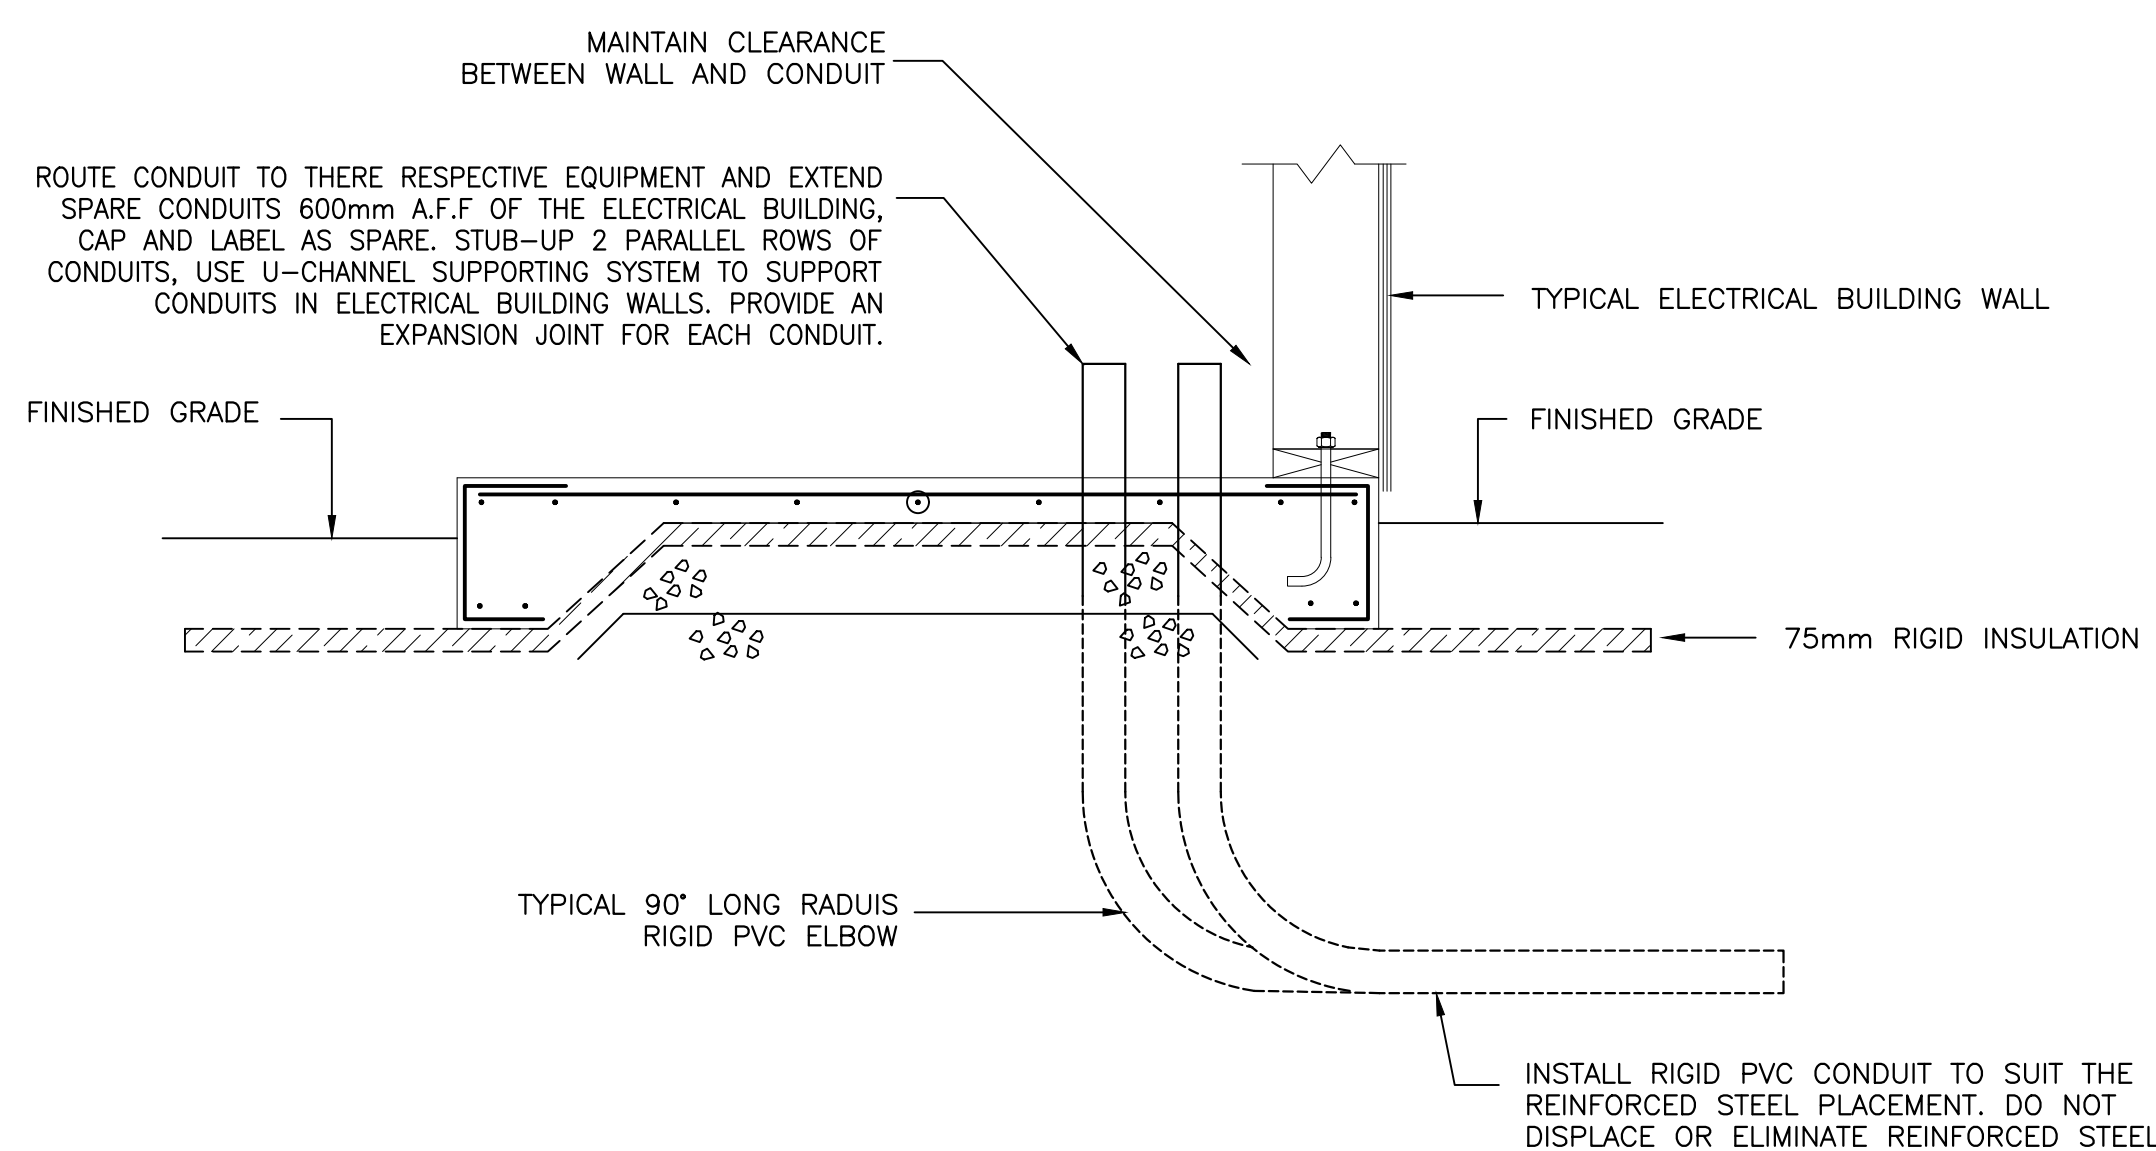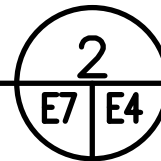


DETAIL – TYPICAL CONDUIT INSTALLATION

SCALE : N.T.S.

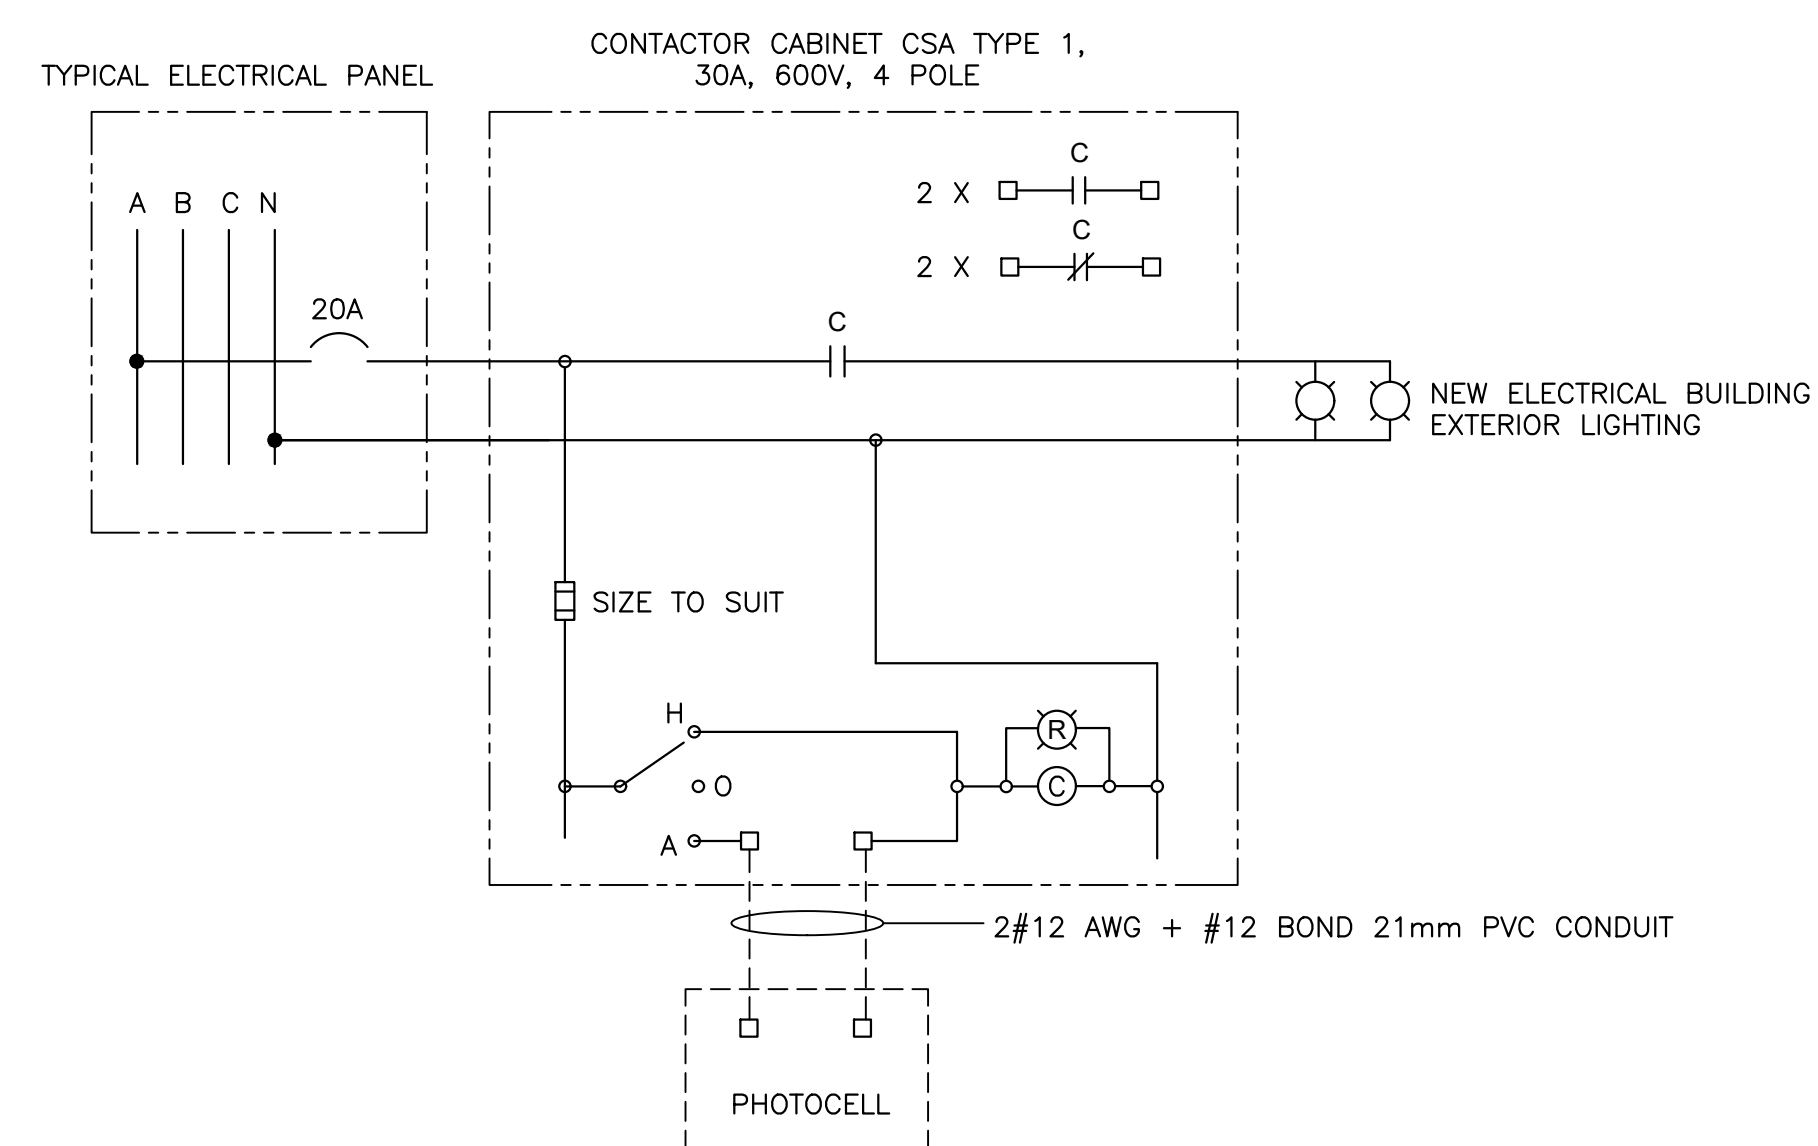

SCHEMATIC – TYPICAL OUTDOOR LIGHTING CONTROL

SCALE : N.T.S.

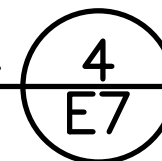

| | | |
|-----------|-------------------|-------------|
| 1 | ISSUED FOR TENDER | 07 OCT 2020 |
| revisions | | date |

| | |
|---------|---------|
| project | project |
|---------|---------|

SEARCH AND RESCUE
STATION EMERGENCY
POWER ADDITION

LOUISBOURG, NS.

| | |
|---------|--------|
| drawing | dessin |
|---------|--------|

ELECTRICAL DETAILS
SHEET 2 OF 2

| | | |
|----------|------------|-------|
| designed | H. BATTIKH | conçu |
|----------|------------|-------|

| | | |
|------|-------------|--|
| date | AUGUST 2020 | |
|------|-------------|--|

| | | |
|-------|----------|---------|
| drawn | K. WOLFE | dessiné |
|-------|----------|---------|

| | | |
|------|-------------|--|
| date | AUGUST 2020 | |
|------|-------------|--|

| | | |
|----------|------------|----------|
| approved | H. BATTIKH | approuvé |
|----------|------------|----------|

| | | |
|------|--|--|
| date | | |
|------|--|--|

| | |
|--------|------------|
| Tender | Soumission |
|--------|------------|

| | |
|-----------------------|---------------------------------|
| PWGSC Project Manager | Administrateur de projets TP50C |
|-----------------------|---------------------------------|

| | |
|----------------|---------------|
| project number | no. du projet |
|----------------|---------------|

R.102094.001

| | |
|-------------|---------------|
| drawing no. | no. du dessin |
|-------------|---------------|

E7