



CTURE 2017 EMPLACEMENT FICHIER : L19380-20-00_10725ReesorRdl2-Dwgs\1-active\9380-20_10725Ree

sorRd.dwg IMPRIMÉ LE: 11/19/2020 2

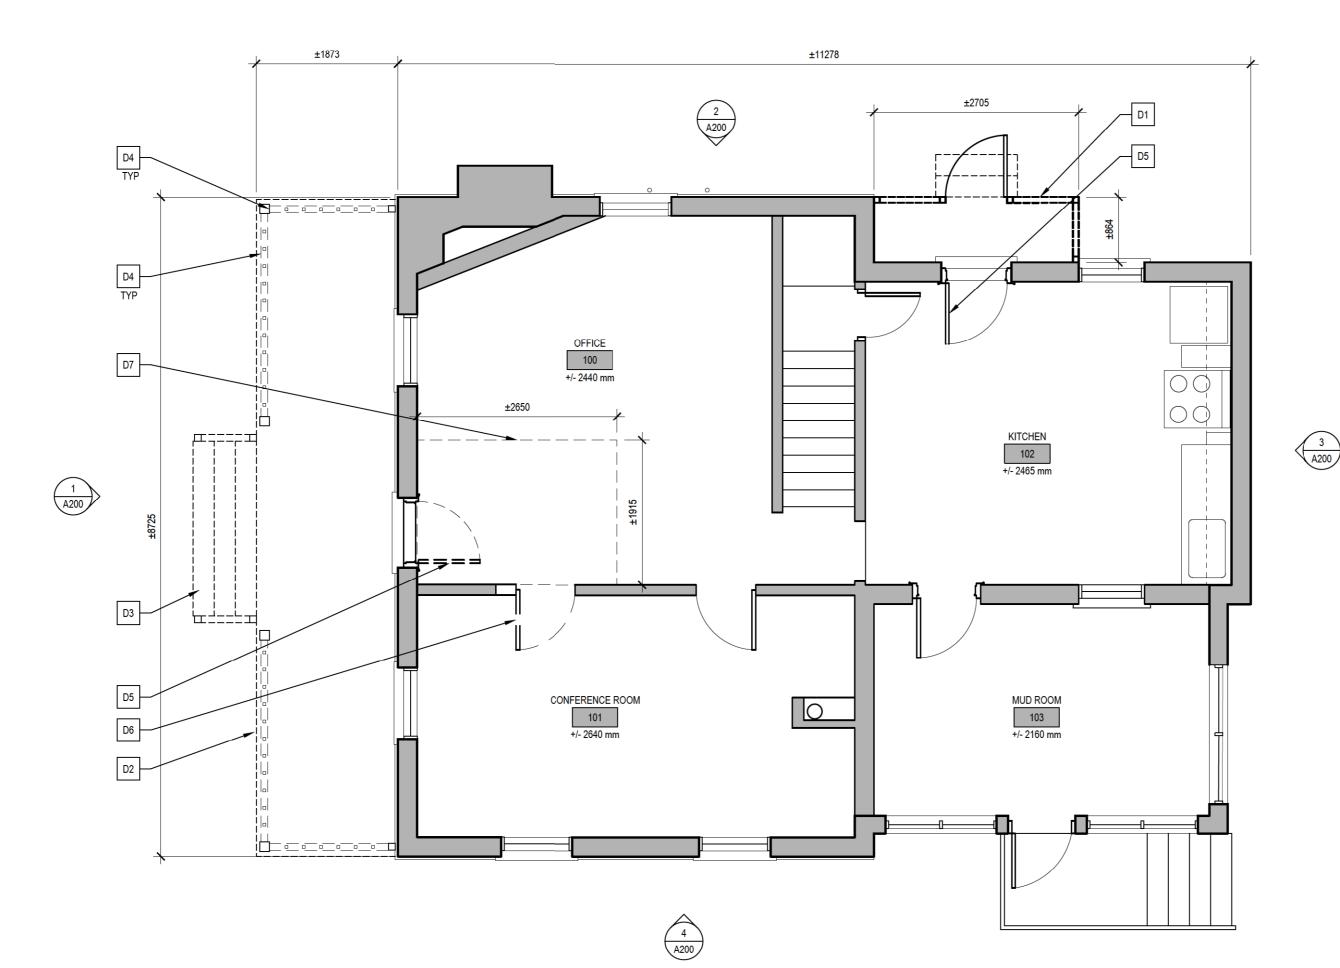


PROJECT Nº:		9380	DRAWING Nº:		A000
222.522.10					
VERIFIED:	DC/JH		SCALE:	AS NOTED	
DRAWN:	HG		DATE:	2020-07-08	
DESIGN:	JH		APPROVED:	DC	

PROPOSED NEW DESIGNATED ACCESSIBLE PARKING SPOT

POTENTIAL AREA FOR STAGING

AREA TO REMAIN ACCESSIBLE TO PUBLIC AND PARK STAFF AT ALL TIMES





JRE 2017 EMPLACEMENT FICHIER : 1/9380-20-00_10725R

SELECTIVE DEMOLITION:

- 1. THE CONTRACTOR IS RESPONSIBLE FOR
- VERIFYING ALL DIMENSIONS. 2. ALL REQUIRED DOCUMENTATION MUST BE SUBMITTED AND REVIEWED PRIOR TO STARTING ANY DEMOLITION OR DISMANTLING WORK.
- PROVIDE PROTECTION OF EXTERIOR WALLS, 3. DOORS, WINDOWS, STAIRS, AND INTERIOR SPACES THAT ARE NOT WITHIN SCOPE PRIOR TO STARTING ANY DEMOLITION OR DISMANTLING WORK.
- 4. NOTES APPLY TO EVERY ELEMENT TYPE DESCRIBED IN EACH NOTE. ABATEMENT PROCEDURES FOR MATERIALS 5
- CONTAINING LEAD (PAINT) AND ASBESTOS (PLASTER AND CEMENT PARGING) TO BE COMPLETED AS PER MINISTRY OF ENVIRONMENT STANDARDS, REFER TO DESIGNATED SUBSTANCES REPORT.
- TEMPORARY SHORING: CONTRACTOR SHALL 6 SUBMIT SHORING DRAWINGS SEALED BY A PROFESSIONAL ENGINEER LICENCED IN THE PROVINCE OF ONTARIO FOR REVIEW PRIOR TO ORDERING SHORING MATERIALS.
- D1 REMOVE AND DISCARD EXISTING METAL PORCH ENCLOSURE AND ROOF, MASONRY / CONCRETE EXTERIOR LANDING, AND EXISTING PRECAST STAIR.
- D2 REMOVE AND DISCARD EXISTING PORCH DECK AND ASSOCIATED STRUCTURE.
- D3 REMOVE AND DISCARD EXISTING EXTERIOR STAIR AND HANDRAIL.
- D4 REMOVE EXISTING PORCH POSTS, GUARDRAILS, AND BALUSTERS. SALVAGE ONE TURNED POST AND ONE BALUSTER FOR REPLICATION OF PROFILE. PROVIDE TEMPORARY SHORING FOR PORCH ROOF.
- REMOVE EXISTING EXTERIOR DOOR AND D5 ASSOCIATED HARDWARE AND ACCESSORIES. REMOVE AND SALVAGE MAIL RECEPTACLE. REMOVE EXISTING STORM DOOR. JAMBS AND CASINGS TO REMAIN.
- D6 EXISTING DOOR, DOOR JAMBS AND TRIMS TO BE REMOVED. EXTENT OF EXISTING WALL AND WAINSCOTING TO BE REMOVED TO SUIT NEW BARRIER-FREE DOOR.
- D7 REMOVE EXISTING CARPET. EXTENT AS SHOWN.



ARCHITECTS:

(G) ojdrovic engineering

4195 Dundas St. W., Suite 233, Toronto ON MX8 1Y4 T 416.925.0333 F 416.925.3980 www.ojdrovic.com

7	ISSUED FOR TENDER	JH	2020-11-25
6	ISSUED FOR 100% REVIEW	JH	2020-09-18
5	PROGRESS REVIEW	JH	2020-08-31
4	PROGRESS REVIEW	JH	2020-08-18
3	PROGRESS REVIEW	JH	2020-07-29
2	CLIENT REVIEW	СВ	2020-07-06
1	CLIENT REVIEW	GR	2020-05-15
N ^o :	DESCRIPTION:	BY	DATE
REVIS	ION		

THE GENERAL CONTRACTOR :

1. SHALL BE RESPONSIBLE FOR VERIFYING ALL DIMENSIONS ON SITE TO ENSURE

 SHALL BE RESPONSIBLE FOR VERIFING ALL DIMENSIONS ON SITE TO ENSURE COMPLIANCE WITH THE DIMENSIONS GIVEN ON THE DRAWINGS.
 SHALL BE RESPONSIBLE TO IMMEDIATELY SUBMIT A REPORT TO THE ARCHITECT OR ENGINEER OUTLINING ANY INACCURACIES.
 SHALL NOT TAKE SCALED MEASUREMENTS OFF THE DRAWINGS.
 ANY INDIVIDUAL OR FIRM THAT HAVE RECEIVED ELECTRONIC DOCUMENT SHALL USE THEM AT THEIR OWN RISK. ONLY ORGINAL DRAWINGS, STAMPED BY THE ARCHITECT, MAY BE USED FOR CONSTRUCTION.



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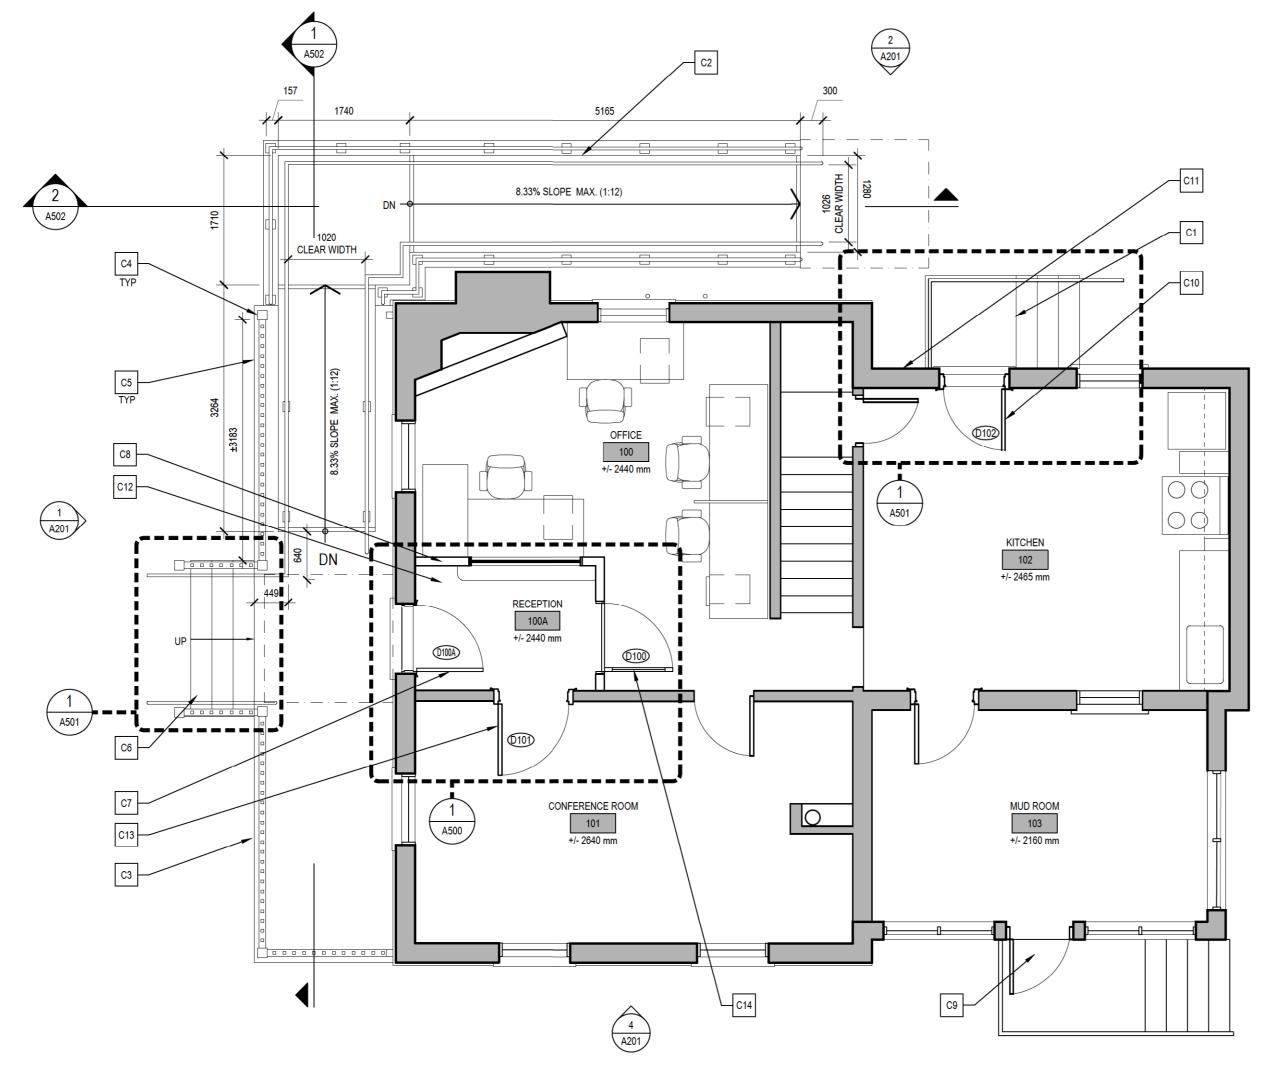
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PROJECT:

REESOR NORTH OFFICE ACCESSIBILITY IMPROVEMENTS 10725 REESOR ROAD, MARKHAM

DRAWING TITLE: DEMOLITION FLOOR PLAN

DESIGN:	JH		APPROVED:	DC	
DRAWN:	JH		DATE:	2020-07-08	
VERIFIED:	DC/JH		SCALE:	1:50	
PROJECT Nº:			DRAWING Nº:		
		0380			$\Delta 100$
		0000			A100





RE 2017 EMPLACEMENT FICHIER : L'19380-20-00_10725R

CONSTRUCTION:

1. THE CONTRACTOR IS RESPONSIBLE FOR VERIFYING ALL DIMENSIONS. 2. NOTES APPLY TO EVERY ELEMENT TYPE

DESCRIBED IN EACH NOTE.

- C1 CONSTRUCT NEW SIDE ENTRANCE STAIR STRUCTURE. REFER TO DETAILS AND STRUCTURAL DRAWINGS.
- C2 CONSTRUCT NEW ACCESS RAMP TO MAIN ENTRANCE. REFER TO RAMP DETAILS AND STRUCTURAL.
- CONSTRUCT NEW FRONT WOOD PORCH C3 STRUCTURE WITH NEW PAINTED BOARD AND BATTEN SKIRT. FOOTPRINT OF PORCH TO MATCH EXISTING. REFER TO DETAILS.
- CONSTRUCT NEW TURNED PORCH POSTS TO SUIT HEIGHT OF NEW PORCH, TO BE PAINTED. PROFILE TO MATCH EXISTING. REFER TO PORCH DETAILS.
- CONSTRUCT NEW WOOD GUARDRAIL WITH TURNED BALUSTERS, TO BE PAINTED. PROFILE TO MATCH EXISTING. REFER TO DETAILS.
- CONSTRUCT NEW WOOD STAIR WITH METAL HANDRAIL AND WOOD RAILING. REFER TO STAIR DETAILS.
- C7 PROVIDE AND INSTALL NEW EXTERIOR DOOR WITH OFFSET PIVOT HINGES, POWER DOOR OPENER WITH ACCESSIBLE DOOR
- OPERATOR AND ELECTRIC STRIKE. REINSTALL MAIL RECEPTACLE. REFER TO DOOR DETAILS. PERFORM MINOR REPAIRS TO WOOD JAMBS, TRIMWORK THRESHOLD AS REQUIRED.
- C8 CONSTRUCT NEW ENTRANCE RECEPTION VESTIBULE. REFER TO INTERIOR DETAILS. CONSTRUCT NEW ENTRANCE RECEPTION

3 A201

- C9 PROVIDE NEW EXTERIOR-GRADE PORCH LIGHTING; INSTALLED TO U/S OF PORCH SOFFIT.
- C10 INSTALL NEW EXTERIOR WOOD DOOR. REFER TO DOOR DETAILS. PERFORM MINOR REPAIRS TO WOOD JAMBS, TRIMWORK THRESHOLD AS REQUIRED.
- C11 REMOVE PAINT FINISH FROM EXISTING BRICKWORK. REPARGE STONE BASE AS REQUIRED.
- C12 INSTALL NEW NON-SLIP VINYL FLOORING.
- CONSTRUCT NEW BARRIER-FREE O INSTALL NEW DOOR, DOOR JAMBS, CONSTRUCT NEW BARRIER-FREE OPENING. TRIMWORK AND HARDWARE FOR EXISTING DOOR. INSTALL NEW SECURITY HARDWARE. REFER TO DOOR SCHEDULE.
- C14 INSTALL NEW INTERIOR WOOD DOOR AND WOOD FRAME

OUTLINE OF REQUIRED BARRIER-FREE RAMP 1700 MM X 1700 MM

EVOQ 366 ADELAIDE ST. EAST, SUITE 225 TORONTO (ONTARIO) M5A 3X9 T. 647-723-2030

(a) ojdrovic engineering

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3	PROGRESS REVIEW	JH	2020-07-29
2	CLIENT REVIEW	СВ	2020-07-06
1	CLIENT REVIEW	GR	2020-05-15
N°:	DESCRIPTION:	BY	DATE
		1	

REVISION:

ARCHITECTS:

CLIENT

STRUCTURAL ENGINEER:

THE GENERAL CONTRACTOR :

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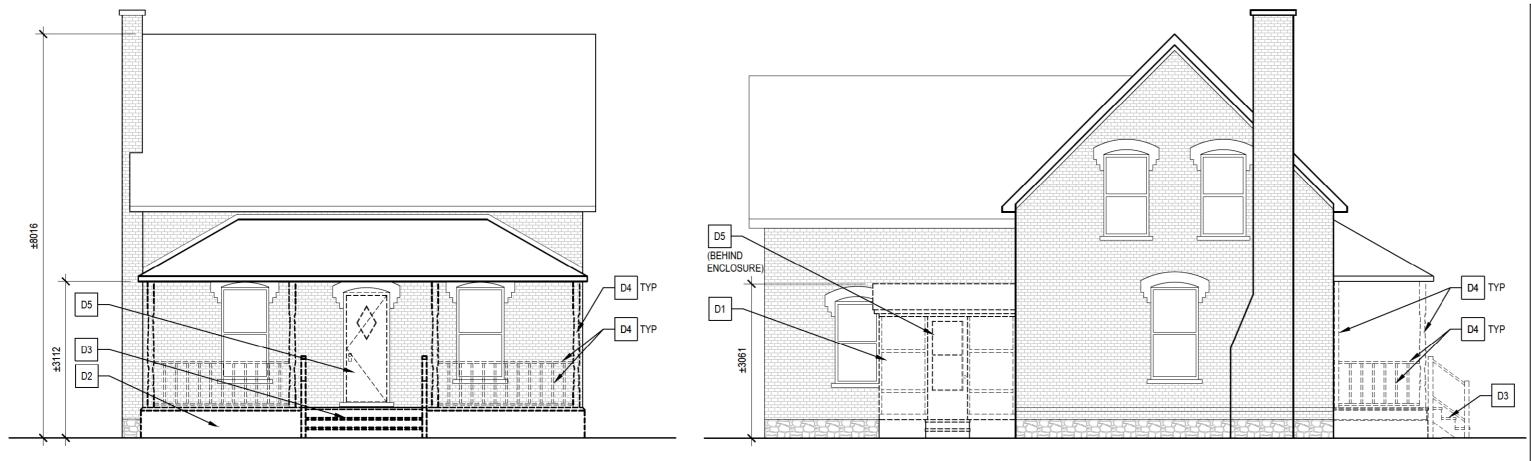
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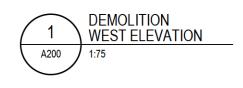
PROJECT

REESOR NORTH OFFICE ACCESSIBILITY IMPROVEMENTS 10725 REESOR ROAD, MARKHAM

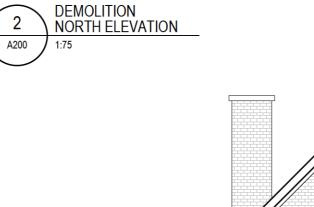
DRAWING TITLE: PROPOSED FLOOR PLAN

DESIGN: JH APPROVED: DC DRAWN: JH DATE: 2020-07-08 VERIFIED: DC/JH SCALE: 1:50 PROJECT Nº: DRAWING Nº: 9380 A101

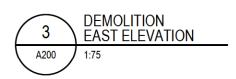


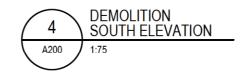






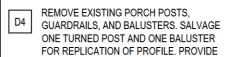






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- 4. NOTES APPLY TO EVERY ELEMENT TYPE DESCRIBED IN EACH NOTE.
- ABATEMENT PROCEDURES FOR MATERIALS CONTAINING LEAD (PAINT) AND ASBESTOS (PLASTER AND CEMENT PARGING) TO BE COMPLETED AS PER MINISTRY OF ENVIRONMENT STANDARDS. REFER TO DESIGNATED SUBSTANCES REPORT.
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- REMOVE AND DISCARD EXISTING METAL D1 PORCH ENCLOSURE AND ROOF, MASONRY / CONCRETE EXTERIOR LANDING, AND EXISTING PRECAST STAIR.
- REMOVE AND DISCARD EXISTING PORCH D2 REMOVE AND DISCARD EARTING FORM
- D3 REMOVE AND DISCARE STAIR AND HANDRAIL. REMOVE AND DISCARD EXISTING EXTERIOR



- ONE TURNED POST AND ONE BALUSTER FOR REPLICATION OF PROFILE. PROVIDE TEMPORARY SHORING FOR PORCH ROOF.
- D5 REMOVE EXISTING EXTERIOR DOOR AND ASSOCIATED HARDWARE AND ACCESSORIES. REMOVE AND SALVAGE MAIL RECEPTACLE. REMOVE EXISTING STORM DOOR. JAMBS AND CASINGS TO REMAIN.
- D6 EXISTING DOOR, DOOR JAMBS AND TRIMS TO BE REMOVED. EXTENT OF EXISTING WALL AND WAINSCOTING TO BE REMOVED TO SUIT NEW BARRIER-FREE DOOR.



ARCHITECTS:

7	ISSUED FOR TENDER	JH	2020-11-25
6	ISSUED FOR 100% REVIEW	JH	2020-09-18
5	PROGRESS REVIEW	JH	2020-08-31
4	PROGRESS REVIEW	JH	2020-08-18
3	PROGRESS REVIEW	JH	2020-07-29
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1	CLIENT REVIEW	GR	2020-05-15
N ⁰ :	DESCRIPTION:	BY	DATE
REVISI	ON:	1	

THE GENERAL CONTRACTOR :

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 SHALL BE RESPONSIBLE TO IMMEDIATELY SUBMIT A REPORT TO THE ARCHITECT OR ENGINEER OUTLINING ANY INACCURACIES.

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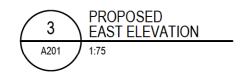
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PROJECT: **REESOR NORTH OFFICE** ACCESSIBILITY IMPROVEMENTS 10725 REESOR ROAD, MARKHAM

DEMOLITION ELEVATIONS

DESIGN:	JH		APPROVED:	DC	
DRAWN:	JH		DATE:	2020-07-08	
VERIFIED:	DC/JH		SCALE:	1:75	
PROJECT Nº:			DRAWING Nº:		
		9380			A200

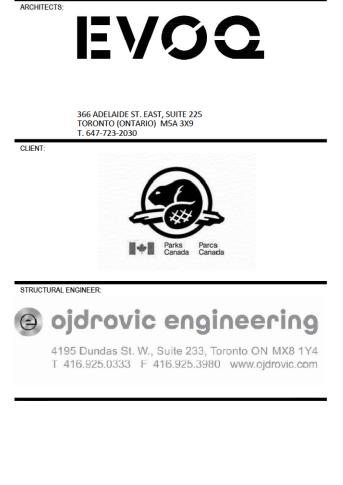




4	PROPOSED SOUTH ELEVATION
A201	1:75



- 1. THE CONTRACTOR IS RESPONSIBLE FOR VERIFYING ALL DIMENSIONS. 2. NOTES APPLY TO EVERY ELEMENT TYPE
- DESCRIBED IN EACH NOTE. CONSTRUCT NEW SIDE ENTRANCE STAIR
- CONSTRUCT NEW SIDE ENTRANCE STAT STRUCTURE. REFER TO DETAILS AND STRUCTURAL DRAWINGS.
- C2 CONSTRUCT NEW ACCESS RAMP TO MAIN ENTRANCE. REFER TO RAMP DETAILS AND STRUCTURAL.
- CONSTRUCT NEW FRONT WOOD PORCH CONSTRUCT NEW FRONT WOOD FORCH STRUCTURE WITH NEW PAINTED BOARD AND BATTEN SKIRT. FOOTPRINT OF PORCH TO MATCH EXISTING. REFER TO DETAILS.
- CONSTRUCT NEW TURNED PORCH POSTS CONSTRUCT NEW TURNED PORCH POST TO SUIT HEIGHT OF NEW PORCH, TO BE PAINTED. PROFILE TO MATCH EXISTING. REFER TO PORCH DETAILS.
- CONSTRUCT NEW WOOD GUARDRAIL WITH CONSTRUCT NEW WOOD GUARDRAIL W TURNED BALUSTERS, TO BE PAINTED. PROFILE TO MATCH EXISTING. REFER TO DETAILS.
- CONSTRUCT NEW WOOD STAIR WITH METAL CONSTRUCT NEW WOOD STAIR WITH META HANDRAIL AND WOOD RAILING. REFER TO STAIR DETAILS.
- C7 PROVIDE AND INSTALL NEW EXTERIOR DOOR WITH OFFSET PIVOT HINGES, POWER PROVIDE AND INSTALL NEW EXTERIOR DOOR OPENER WITH ACCESSIBLE DOOR OPERATOR AND ELECTRIC STRIKE. REINSTALL MAIL RECEPTACLE. REFER TO DOOR DETAILS. PERFORM MINOR REPAIRS TO WOOD JAMBS, TRIMWORK THRESHOLD AS REQUIRED.
- CONSTRUCT NEW ENTRANCE RECEPTION C8 CONSTRUCT NEW ENTRANCE RECEPTION VESTIBULE. REFER TO INTERIOR DETAILS.
- C9 PROVIDE NEW EXTERIOR-GRADE PORCH LIGHTING; INSTALLED TO U/S OF PORCH SOFFIT.
- C10 INSTALL NEW EXTERIOR WOOD DOOR. REFER TO DOOR DETAILS. PERFORM MINOR REPAIRS TO WOOD JAMBS, TRIMWORK THRESHOLD AS REQUIRED.
- C11 REMOVE PAINT FINISH FROM EXISTING BRICKWORK. REPARGE STONE BASE AS REQUIRED.
 - APROXIMATE EXTENT OF BRICK TO BE CLEANED OF PAINT



7	ISSUED FOR TENDER	JH	2020-11-25
6	ISSUED FOR 100% REVIEW	JH	2020-09-18
5	PROGRESS REVIEW	JH	2020-08-31
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N°:	DESCRIPTION:	BY	DATE
REVIS	ON:	1	

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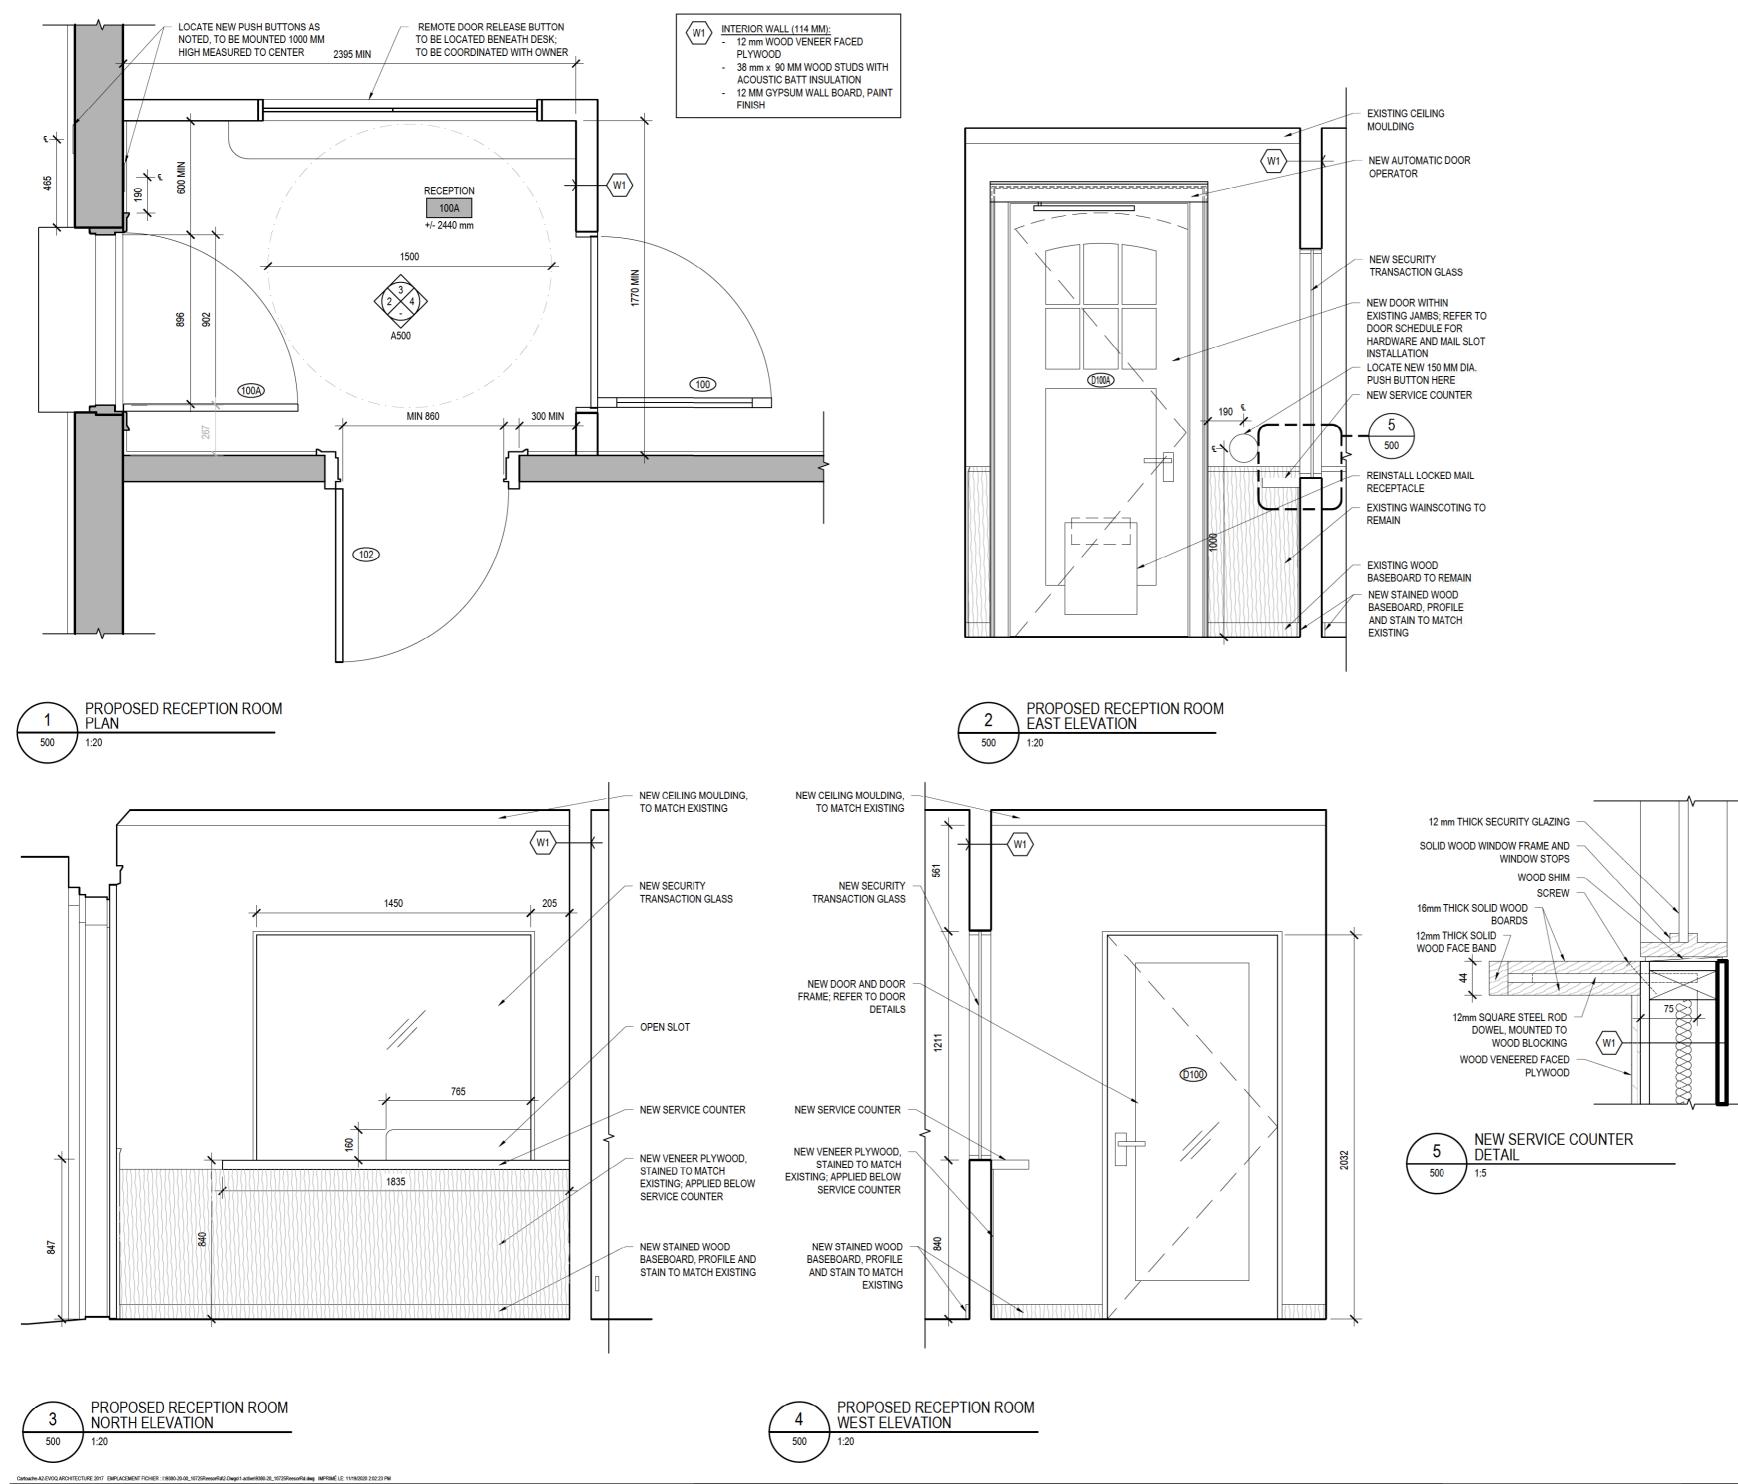
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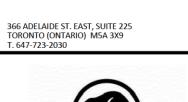
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PROJECT: **REESOR NORTH OFFICE** ACCESSIBILITY IMPROVEMENTS 10725 REESOR ROAD, MARKHAM

PROPOSED ELEVATIONS

DESIGN:	JH		APPROVED:	DC	
DRAWN:	JH		DATE:	2020-07-08	
VERIFIED:	DC/JH		SCALE:	AS NOTED	
PROJECT Nº:		9380	DRAWING Nº:		A201





EVOQ





STRUCTURAL ENGINEER:

CLIEN

ARCHITECTS:

(a) ojdrovic engineering

4195 Dundas St. W., Suite 233, Toronto ON MX8 1Y4 T 416.925.0333 F 416.925.3980 www.ojdrovic.com

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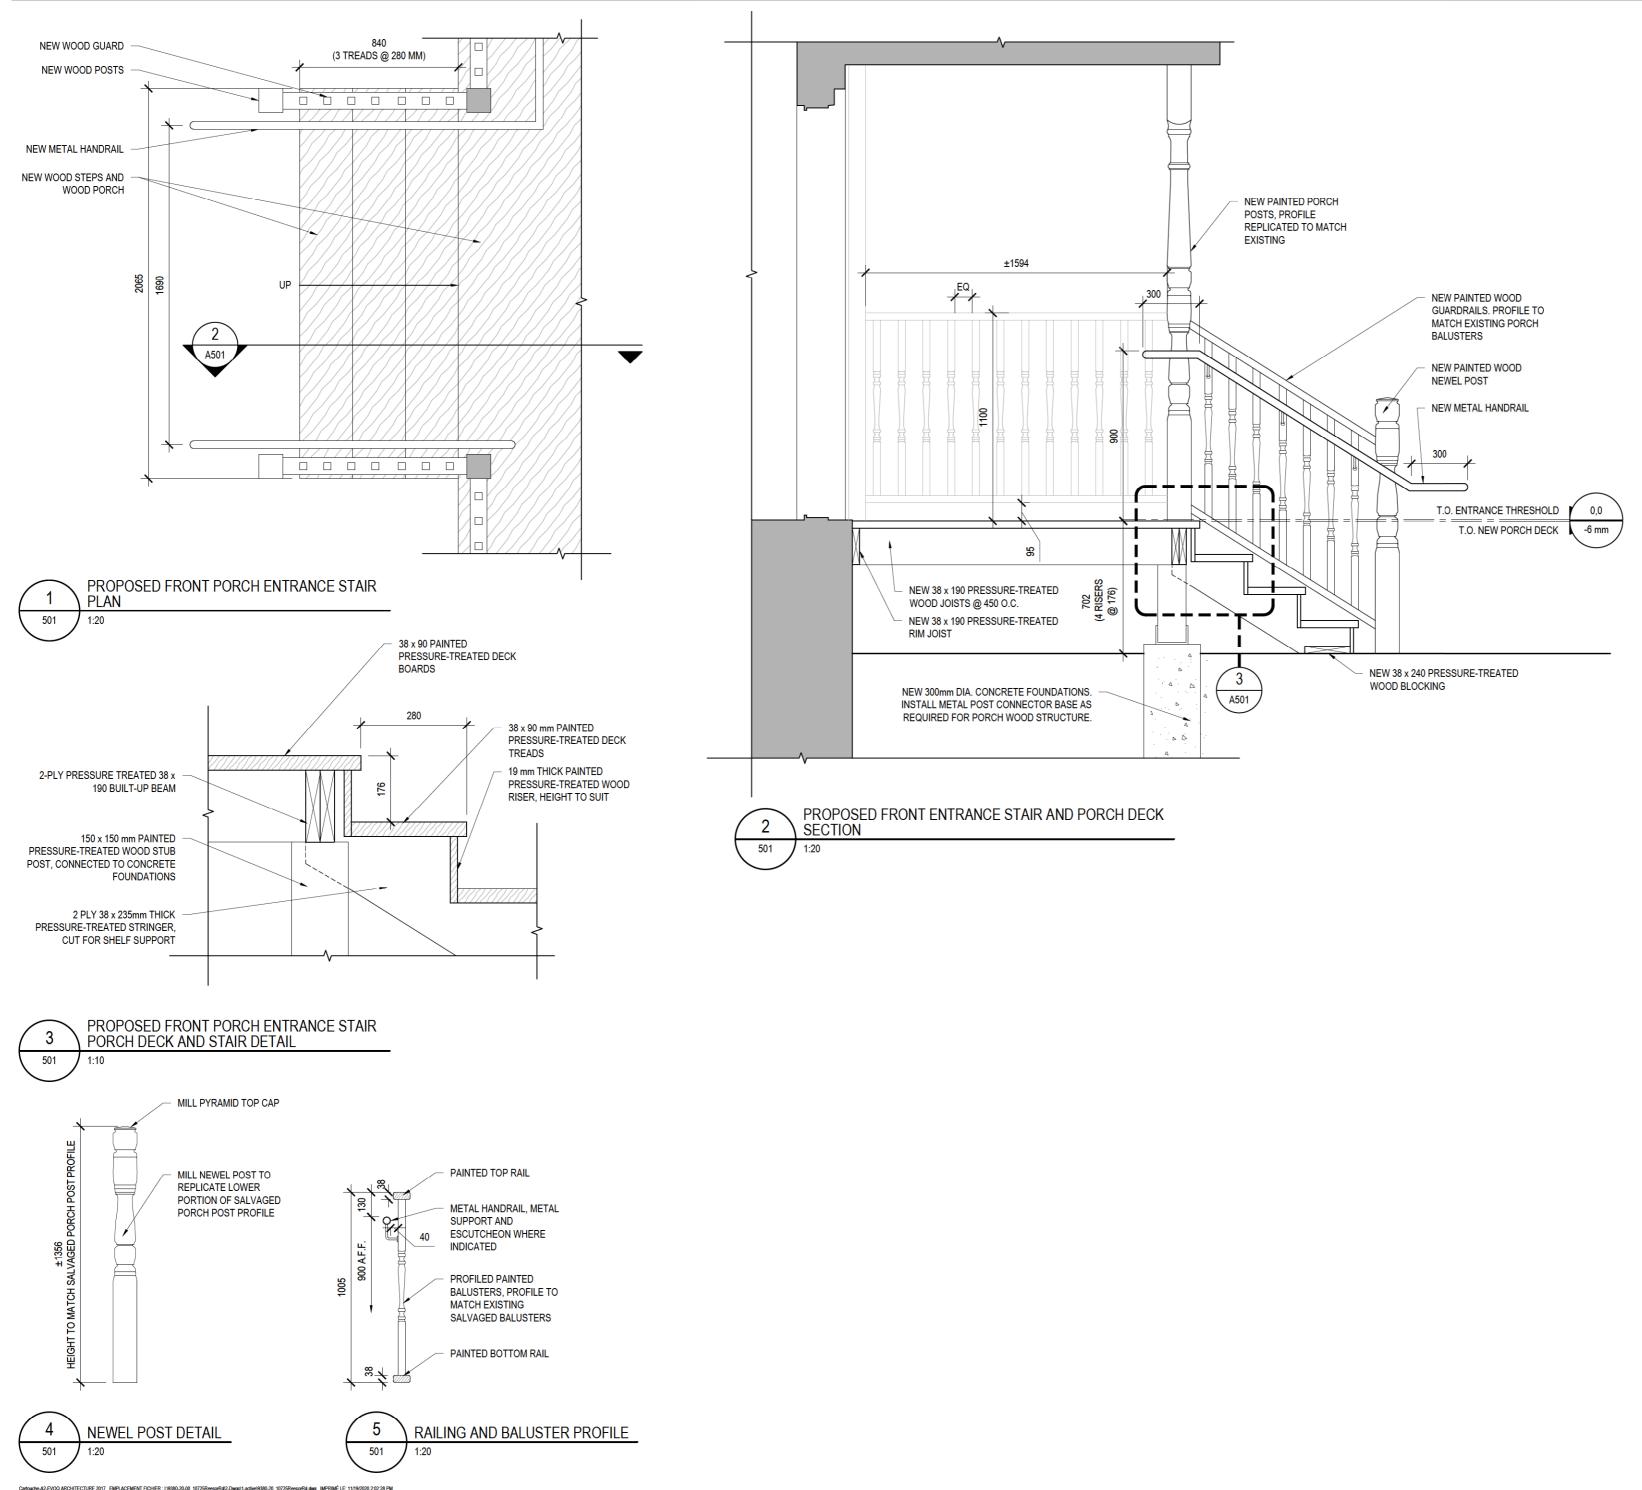
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PROJECT: **REESOR NORTH OFFICE** ACCESSIBILITY IMPROVEMENTS 10725 REESOR ROAD, MARKHAM

INTERIOR RECEPTION DETAILS

PROJECT Nº:		9380	DRAWING Nº:		A500
VERIFIED:	DC/JH		SCALE:	AS NOTED	
DRAWN:	JH		DATE:	2020-07-08	
DESIGN:	JH		APPROVED:	DC	



touche-A2-EVOQ ARCHITECTURE 2017 EMPLACEMENT FICHIER: 1:9380-20-00_10725ReesorRd/2-Dwgs11-active/9380-20_10725ReesorRd.dwg IMPRIMÉ LE: 11/19/2020 2:02:28 PM



366 ADELAIDE ST. EAST, SUITE 225 TORONTO (ONTARIO) M5A 3X9 T. 647-723-2030





STRUCTURAL ENGINEER:

CLIEN

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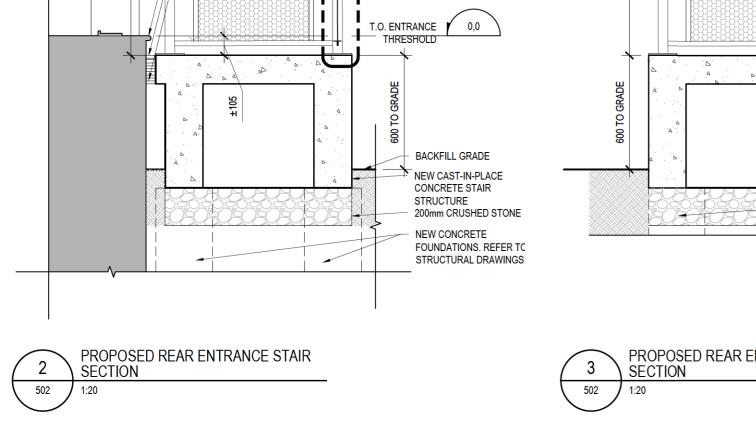
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PROJECT: **REESOR NORTH OFFICE** ACCESSIBILITY IMPROVEMENTS 10725 REESOR ROAD, MARKHAM

FRONT PORCH STAIR DETAILS

VERIFIED: CB/JH SCALE: AS NOTED PROJECT N°: DRAWING N°:	
VERIFIED: CB/JH SCALE: AS NOTED	
DRAWN: CB/JH DATE: 2020-07-08	
DESIGN: CB/JH APPROVED: DC	





NEW METAL RAILING SUPPORTED ON METAL

ŚIM

NEW PERFORATED METAL

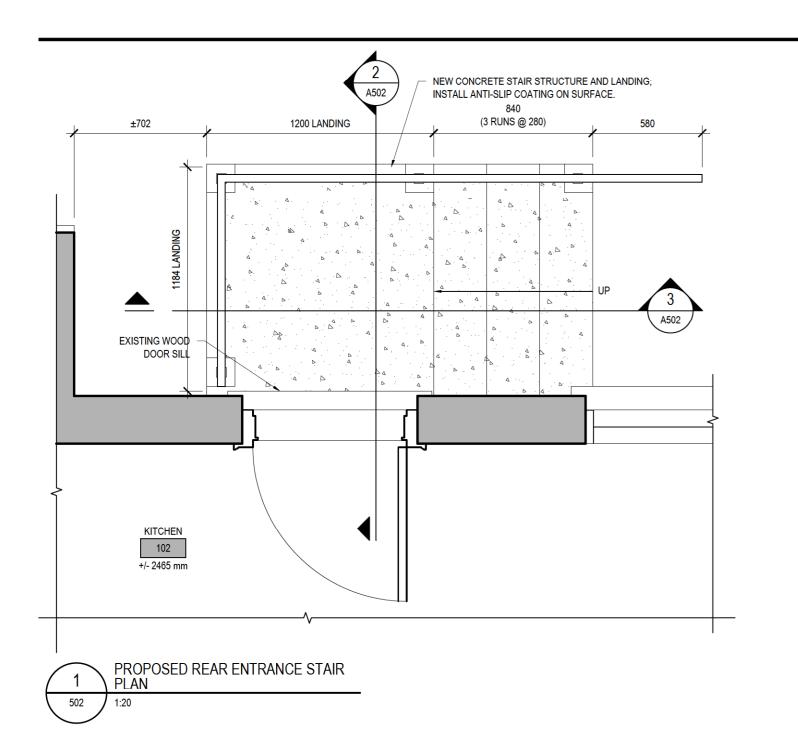
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MESH PANEL

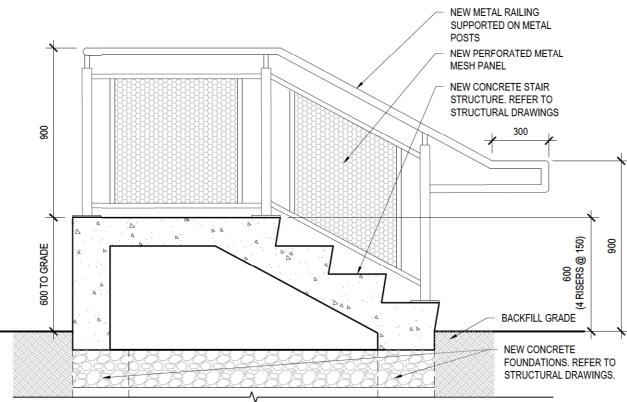
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 LOCALIZED REPAIRS TO EXISTING WOOD THRESHOLD JOINT SEALING COMPOUND

ISOLATION JOINT FOAM

MATERIAL



PROPOSED REAR ENTRANCE STAIR

ARCHITECTS: EVOQ

366 ADELAIDE ST. EAST, SUITE 225 TORONTO (ONTARIO) M5A 3X9 T. 647-723-2030

CLIENT

STRUCTURAL ENGINEER:



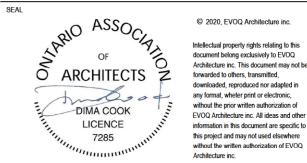


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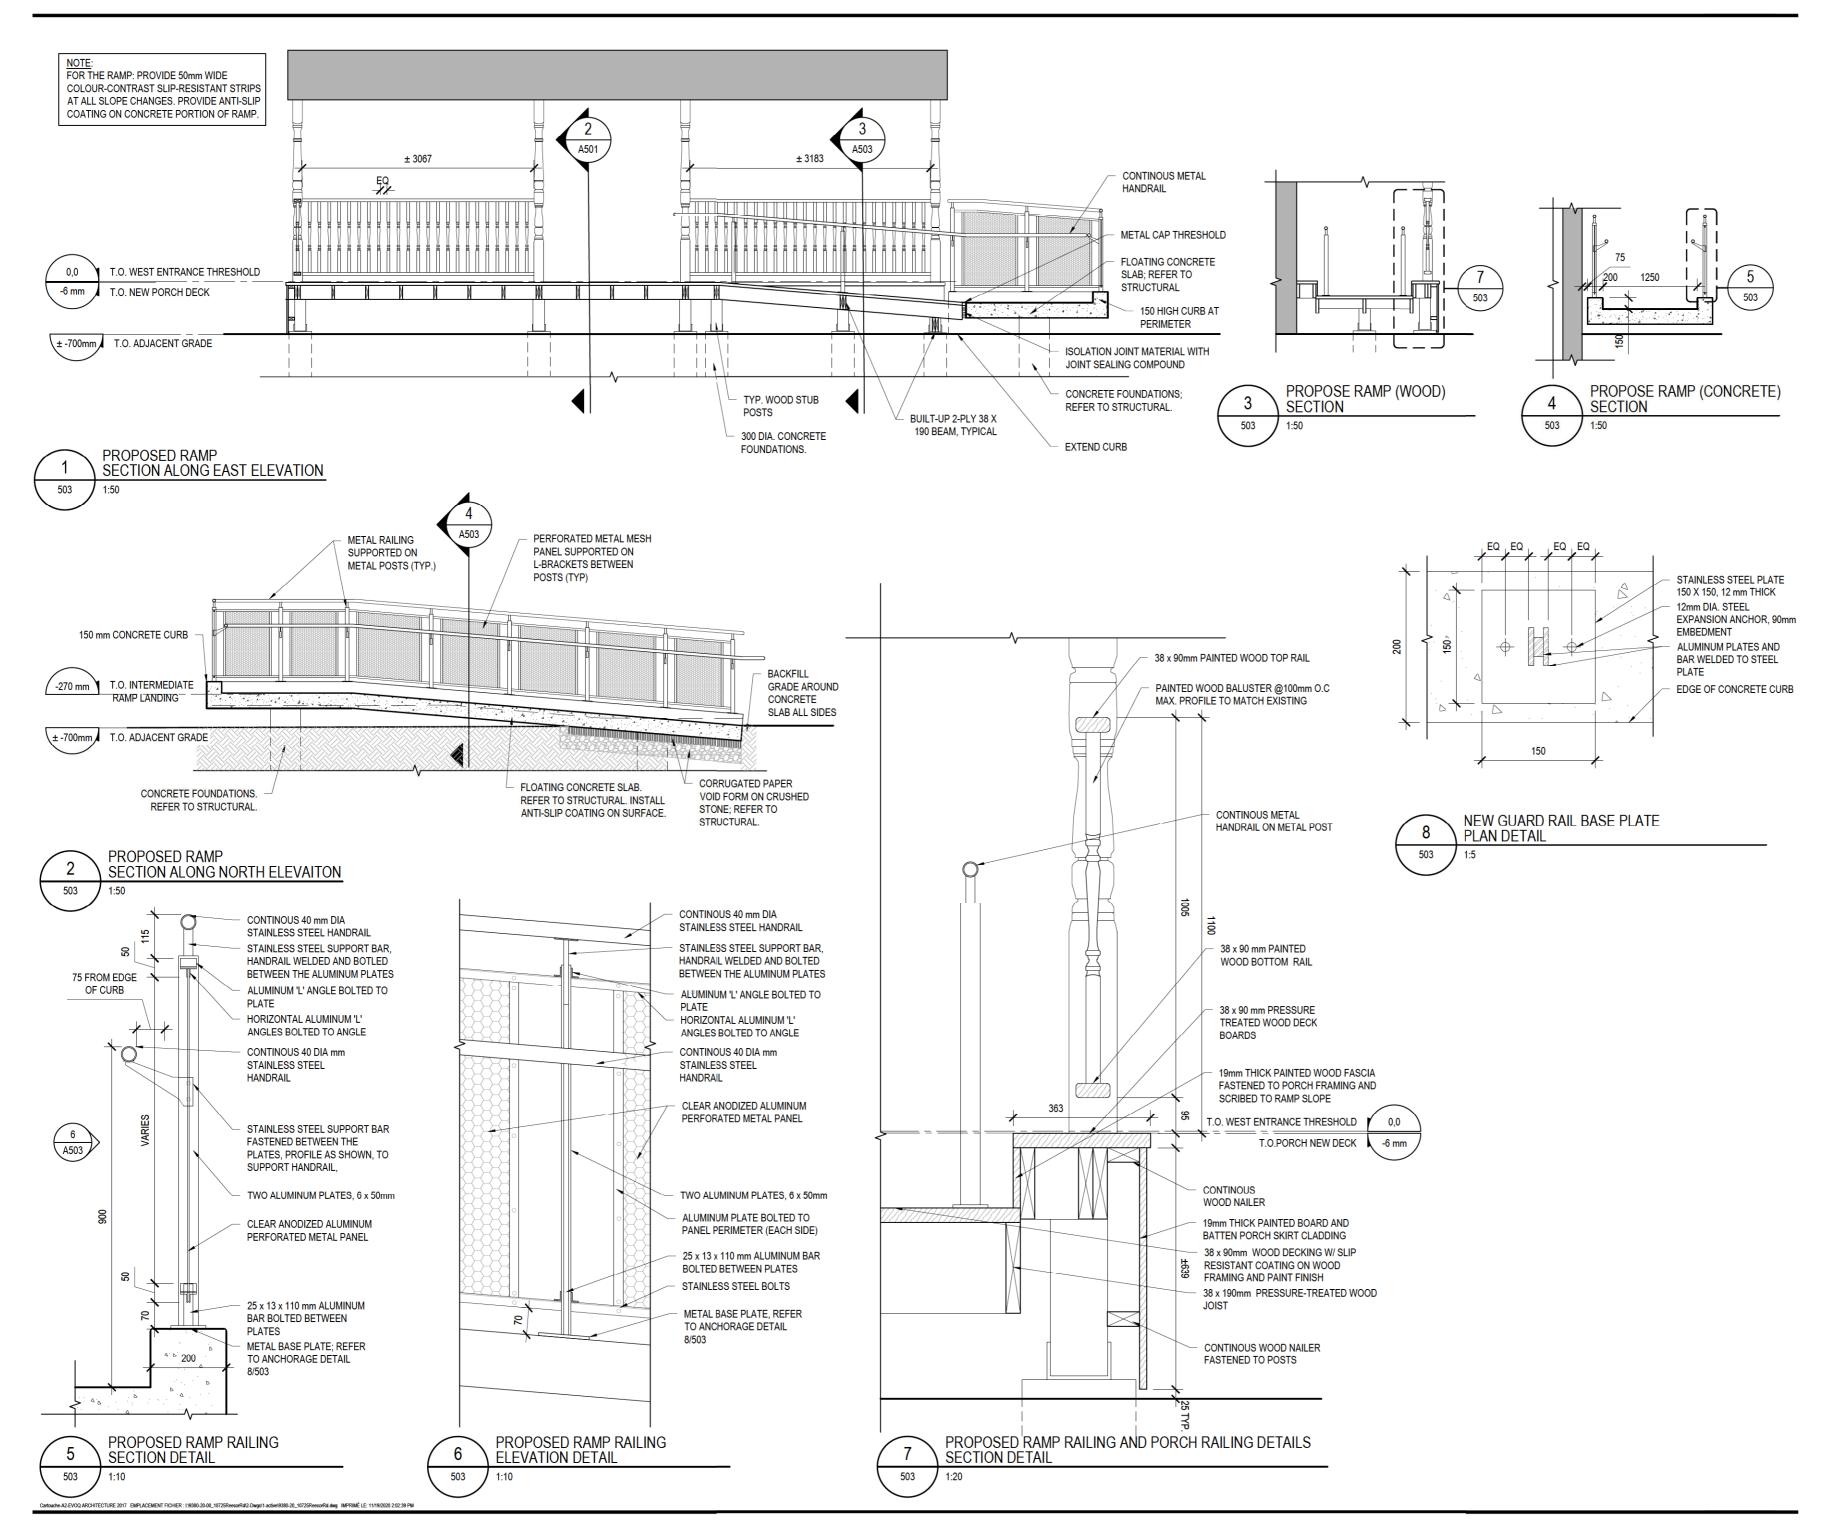
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PROJECT: REESOR NORTH OFFICE ACCESSIBILITY IMPROVEMENTS 10725 REESOR ROAD, MARKHAM

REAR ENTRANCE STAIR DETAILS

		9380			A502
PROJECT Nº:			DRAWING N°:		
VERIFIED:	CB/JH		SCALE:	AS NOTED	
DRAWN:	CB/JH		DATE:	2020-07-08	
DESIGN:	CB/JH		APPROVED:	DC	
DESIGN:	CB/JH		APPROVED:	DC	





366 ADELAIDE ST. EAST. SUITE 225

STRUCTURAL ENGINEER:



ojdrovic engineering

4195 Dundas St. W., Suite 233, Toronto ON MX8 1Y4 T 416.925.0333 F 416.925.3980 www.ojdrovic.com

7	ISSUED FOR TENDER	JH	2020-11-25
6	ISSUED FOR 100% REVIEW	JH	2020-09-18
5	PROGRESS REVIEW	JH	2020-08-31
4	PROGRESS REVIEW	JH	2020-08-18
3	PROGRESS REVIEW	JH	2020-07-29
2	CLIENT REVIEW	СВ	2020-07-06
1	CLIENT REVIEW	GR	2020-05-15
N°:	DESCRIPTION:	BY	DATE
REVISI	ON:		

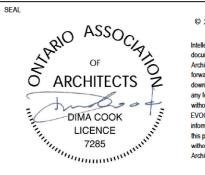
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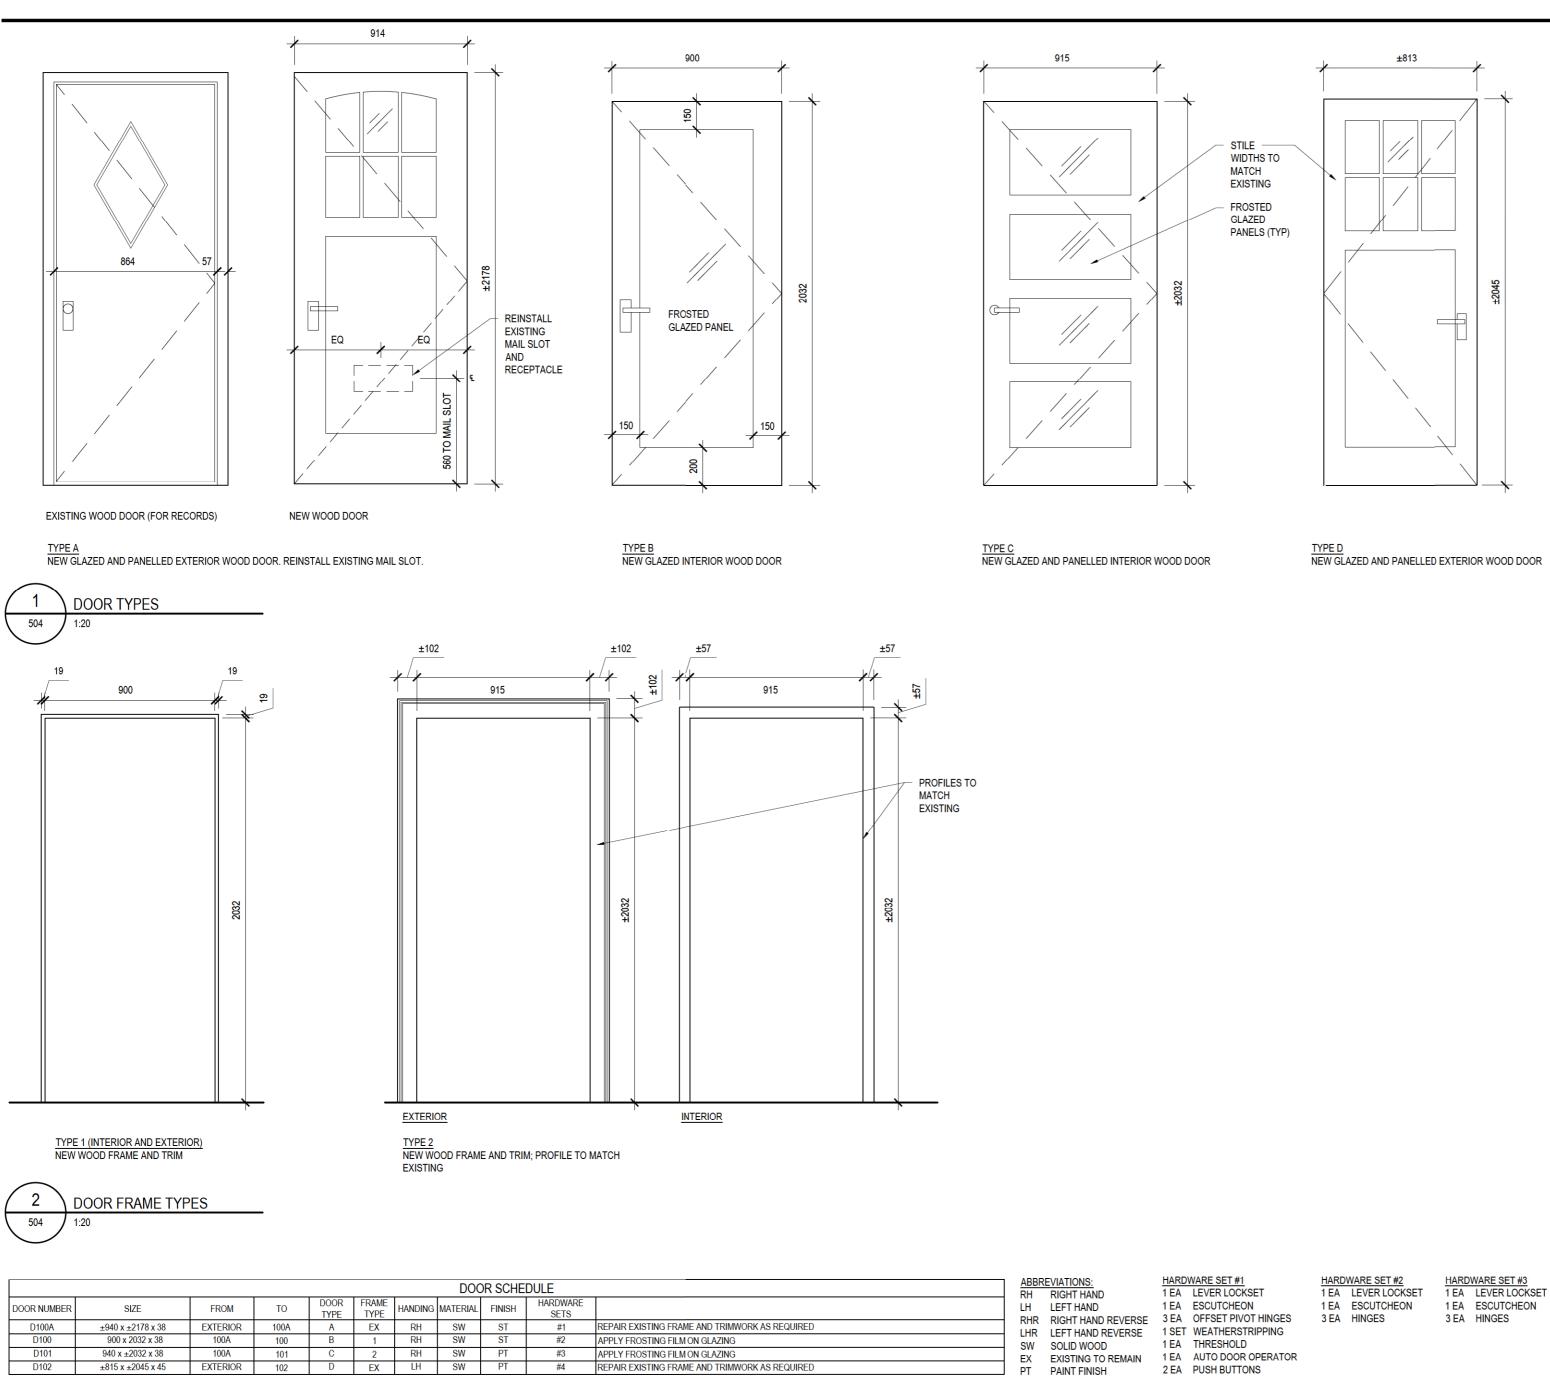
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REESOR NORTH OFFICE ACCESSIBILITY IMPROVEMENTS 10725 REESOR ROAD, MARKHAM

RAMP DETAILS

DESIGN:	JH		APPROVED:	DC	
DRAWN:	JH		DATE:	2020-07-08	
VERIFIED:	DC/JH		SCALE:	AS NOTED	
PROJECT Nº:			DRAWING Nº:		
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		3000			ADUS



3 DOOR SCHEDULE 504 N.T.S.

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ARCHITECTS: EVOQ

366 ADELAIDE ST. EAST, SUITE 225 TORONTO (ONTARIO) M5A 3X9 T. 647-723-2030

CLIEN

STRUCTURAL ENGINEER:





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N°:	DESCRIPTION:	BY	DATE

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PROJECT: **REESOR NORTH OFFICE** ACCESSIBILITY IMPROVEMENTS 10725 REESOR ROAD, MARKHAM

DOOR DETAILS & DOOR SCHEDULE

PROJECT Nº:		9380	DRAWING Nº:		A504
VERIFIED:	DC/JH		SCALE:	AS NOTED	
DRAWN:	JH		DATE:	2020-07-08	
DESIGN:	JH		APPROVED:	DC	

ST

STAIN FINISH

- 1 EA ELECTRIC STRIKE C/W WITH REMOTE DOOR RELEASE ACCESS

1 EA THRESHOLD

HARDWARE SET #4 1 EA LEVER LOCKSET 1 EA ESCUTCHEON 1 SET WEATHERSTRIPPING 3 EA HINGES

GENERAL NOTES

- A. GENERAL
- 1. THESE DRAWINGS SHOW STRUCTURAL CONTENT ONLY. SEE DRAWINGS OF OTHER DISCIPLINES FOR LIFE SAFETY, ARCHITECTURAL, MECHANICAL AND ELECTRICAL.
- 2. READ STRUCTURAL DRAWINGS IN CONJUNCTION WITH ALL OTHER CONTRACT DOCUMENTS
- 3. BEFORE PROCEEDING WITH WORK, VERIFY ALL DIMENSIONS SHOWN ON STRUCTURAL DRAWINGS WITH ACTUAL DIMENSIONS OF EXISTING STRUCTURE. REPORT ANY DISCREPANCIES TO ENGINEER BEFORE PROCEEDING WITH WORK.
- 4. ALL DIMENSIONS, UNLESS OTHERWISE NOTED, ARE METRIC. ALL LEVELS, UNLESS OTHERWISE NOTED, ARE IN mm. DO NOT SCALE DRAWINGS.
- 5. THESE DRAWINGS SHOW THE COMPLETED STRUCTURE. THE CONTRACTOR IS RESPONSIBLE FOR SAFETY ON THE JOB SITE, AND DESIGN, INSTALLATION AND SUPERVISION OF ALL TEMPORARY BRACING, SHORING, FORM WORK AND FALSE WORK, REQUIRED TO COMPLETE THE WORK.
- 6. THE USE OF THESE DRAWINGS SHALL BE STRICTLY LIMITED TO THE INSTRUCTIONS IN THE REVISION BLOCK. BUILDING FROM THESE DRAWINGS SHALL PROCEED ONLY WHEN "ISSUED FOR CONSTRUCTION".
- 7. ANY DAMAGE TO EXISTING BUILDING OR TO NEIGHBOURING PROPERTIES IS NOT PERMITTED. CONTRACTOR IS RESPONSIBLE TO MAKE GOOD ALL UNAVOIDABLE DAMAGE.
- SHORE ALREADY EXISTING WORK, AND EXISTING STRUCTURE AS REQUIRED UNTIL ALL NEW WORK HAS BEEN COMPLETED AND REVIEWED BY THE CONSULTANT.
- 9. SHORE FLOORS AS REQUIRED TO SUPPORT CRANES, HOISTS AND OTHER CONSTRUCTION EQUIPMENT, UNTIL COMPLETION OF CONSTRUCTION.
- 10. CONFORM WITH ALL APPLICABLE CODES AND BY LAWS CONCERNING SAFETY, NOISE AND VIBRATIONS.
- 11. INFORMATION ABOUT EXISTING BUILDING STRUCTURE IS TRANSFERRED FROM AVAILABLE EXISTING BUILDING DRAWINGS. ENGINEER IS NOT RESPONSIBLE FOR DISCREPANCIES BETWEEN SHOWN EXISTING BUILDING AND ACTUAL CONDITIONS ON SITE
- 12. CONTRACTOR IS RESPONSIBLE FOR ALL WORK NOT EXPLICITLY SHOWN, NECESSARY TO ACHIEVE FINAL RESULT SHOWN ON CONTRACT DRAWINGS.

B. ALTERATIONS AND CONNECTIONS TO EXISTING STRUCTURE

- THE CONTRACTOR SHALL VERIFY ALL DIMENSIONS SHOWN ON PLANS AND ASSUME FULL RESPONSIBILITY FOR THE 1. ACCURACY OF CONSTRUCTION.
- 2. INSPECT THE EXISTING BUILDING AND BECOME THOROUGHLY FAMILIAR WITH THE EXISTING CONDITIONS.
- CHECK ALL DRAWINGS AGAINST ACTUAL CONDITIONS ON SITE PRIOR TO FABRICATING ANY REINFORCEMENT, ORDERING ANCHORS, ETC. REPORT DISCREPANCIES TO THE ENGINEER BEFORE PROCEEDING WITH THE WORK.

C. CODES AND STANDARDS

- PERFORM ALL WORK IN ACCORDANCE WITH THE REQUIREMENTS OF THE ONTARIO BUILDING CODE, 2012.
- 2. COMPLY WITH THE OCCUPATIONAL HEALTH AND SAFETY ACT AND REGULATIONS FOR CONSTRUCTION PROJECTS (LATEST EDITION).

D. MATERIAL AND DESIGN DATA

1. CONCRETE: CONFORM TO THE REQUIREMENTS OF CAN/CSA-A23.1-14 - CONCRETE MATERIALS AND METHODS OF CONCRETE CONSTRUCTION.

RAMP AND STAIRS: CLASS C-1, fc = 32 MPa AT 28 D.

CONCRETE MAY CONTAIN UP TO 50% OF FLY ASH (ASTM C618) OR GROUND GRANULATED BLAST FURNACE SLAG (ASTM C989) PROVIDED THAT CONCRETE SUPPLIER CERTIFIES THAT REQUIREMENTS FOR CONCRETE CLASS AND COMPRESSIVE STRENGTH SPECIFIED ABOVE ARE MET. CONTRACTOR SHALL ARRANGE FOR CONCRETE QUALITY TESTING AS PER CAN CSA A23.2-04.

2. CONCRETE REINFORCEMENT: CONFORM TO CSA G30.18, MIN. fy = 400 MPa.

4.8 kPa

E. ENVIRONMENTAL DATA AND LOADS

ENVIRONMENTAL DESIGN DATA FOR TORONTO

SNOW 1/50:	Ss = 0.9 kPa
RAIN 1/50:	Sr = 0.4 kPa

LIVE LOAD

F. SITE REVIEW RESPONSIBILITIES

- 1. OJDROVIC ENGINEERING (OE) WILL PROVIDE GENERAL REVIEW OF CONSTRUCTION IN ACCORDANCE WITH THE PERFORMANCE STANDARDS OF THE ASSOCIATION OF PROFESSIONAL ENGINEERS OF ONTARIO BY MEANS OF A RATIONAL SAMPLING PROCEDURE TO DETERMINE WHETHER THE CONSTRUCTION OF THAT WORK SHOWN ON THE OE DRAWINGS IS IN GENERAL CONFORMITY WITH THE PLANS, SKETCHES, DRAWING AND SPECIFICATIONS FORMING PART OF THE CONTRACT DOCUMENTS PREPARED BY OE.
- 2. THE CONTRACTOR IS SOLELY RESPONSIBLE FOR QUALITY CONTROL AND THE PERFORMANCE OF THE WORK IN ACCORDANCE WITH THE CONTRACT.
- 3. OE SHALL NOT BE RESPONSIBLE FOR THE ACTS OR OMISSIONS OF THE CONTRACTOR, SUBCONTRACTOR OR ANY OTHER PERSONS PERFORMING ANY OF THE WORK OR FOR THE FAILURE OF ANY OF THEM TO CARRY OUT THE WORK IN ACCORDANCE WITH THE CONTRACT DOCUMENTS.

G. SHOP DRAWINGS REVIEW

- 2.

CONSTRUCTION NOTES

A. CONCRETE AND REINFORCEMENT

- 3
- CONSTRUCTION JOINTS: 5. REVIEWED AND APPROVED BY THE CONSULTANT. CONSULTANT.
- 6. CONTROL JOINTS: MAXIMUM
- 7. OPENINGS, SLEEVES, EMBEDDED DUCTS: APPROVED BY THE CONSULTANT.
- 9
- ENGINEERING DRAWINGS.
- ENGINEER.

BEFORE ORDERING, CUTTING OR ASSEMBLING ANY MATERIAL, PREPARE SHOP DRAWINGS AS REQUESTED IN CONTRACT DOCUMENTS AND REQUEST REVIEW BY ENGINEER.

REVIEW OF SHOP DRAWINGS IS FOR THE SOLE PURPOSE OF ASCERTAINING GENERAL CONFORMANCE WITH THE DESIGN CONCEPT. SUCH REVIEW DOES NOT IN ANY WAY RELIEVE THE CONTRACTOR OF RESPONSIBILITY FOR ERRORS OR OMISSIONS IN SHOP DRAWINGS OR FOR COMPLIANCE WITH CONTRACT DOCUMENTS.

3. THE CONTRACTOR IS SOLELY RESPONSIBLE FOR INFORMATION PERTAINING TO THE FABRICATION PROCESS, TECHNIQUES OF CONSTRUCTION AND INSTALLATION, AND FOR COORDINATION OF THE WORK OF ALL SUB-TRADES.

ALL DOWELS SHALL HAVE A MINIMUM EMBEDMENT EQUIVALENT TO THE STRAIGHT TENSION EMBEDMENT LENGTH CORRESPONDING TO THE SIZE OF BAR. DOWELS FROM WALLS TO SLABS SHALL HAVE A MINIMUM EMBEDMENT OF 600 mm INTO WALLS AND SLABS UNLESS OTHERWISE NOTED OR SHOWN.

2. PROVIDE DOWELS TO WALLS AND COLUMNS SIMILAR IN NUMBER, SIZE AND SPACING TO THE VERTICAL STEEL IN THE WALL OR COLUMN ABOVE UNLESS OTHERWISE NOTED OR SHOWN.

PROVIDE CORNER BARS AS PER 1/S001 TO MATCH HORIZONTAL WALL REINFORCEMENT AT ALL WALL CORNERS.

PREPARE AND SUBMIT FOR REVIEW, REINFORCEMENT DRAWINGS IN ACCORDANCE WITH RSIC MANUAL OF STANDARD PRACTICE, PRIOR TO FABRICATING REINFORCEMENT.

A) HORIZONTAL CONSTRUCTION JOINTS SHALL NOT BE MADE IN BEAMS OR WALLS UNLESS SHOWN ON DRAWINGS OR

B) VERTICAL CONSTRUCTION JOINTS MAY BE MADE ONLY AT POINTS OF MINIMUM BENDING MOMENT IN BEAMS OR SLABS UNLESS OTHERWISE NOTED OR SHOWN AND THEIR LOCATION SHALL BE REVIEWED AND APPROVED BY THE

A) UNLESS NOTED OTHERWISE, ALL EXTERIOR WALLS BELOW GRADE SHALL HAVE CONTROL JOINTS AT 6000 mm

B) UNLESS NOTED OTHERWISE, ALL SLABS ON GRADE SHALL HAVE CONTROL JOINTS AT 6000 mm MAXIMUM. CUT CONTROL JOINTS AS SOON AS SLAB ON GRADE WILL SUPPORT THE SAW WITHOUT DAMAGE TO SLAB.

A) NO SLEEVES SHALL BE PLACED VERTICALLY OR HORIZONTALLY THROUGH BEAMS UNLESS REVIEWED AND

B) NO OPENINGS SHALL BE MADE IN FLAT PLATES OR FLAT SLAB COLUMN STRIPS EXCEPT AS SHOWN ON PLANS OR UNLESS REVIEWED AND APPROVED BY THE CONSULTANT.

FOR MINIMUM CONCRETE COVER TO REINFORCEMENT SEE TABLE 17 IN CSA-A23.1-04.

MINIMUM CONCRETE COVER TO REINFORCEMENT FOR ALL CONCRETE EXPOSED TO DE-ICING CHEMICALS: 60 mm.

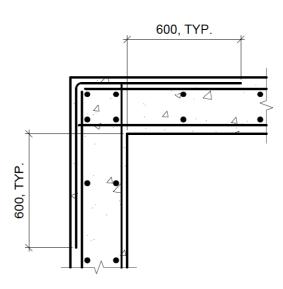
10. COORDINATE AND PROVIDE INSERTS, ANCHOR BOLTS AND ALL CONNECTIONS WITH OTHER TRADES AS REQUIRED.

11. FOR EXACT LOCATION OF SUMP PITS AND MECHANICAL AND ELECTRICAL INSERTS SEE MECHANICAL AND ELECTRICAL

12. REQUEST REVIEW OF PLACED REBAR BEFORE POURING ANY CONCRETE. PROVIDE MIN. 48 HOUR NOTICE TO

13. INSPECTION AND TESTING OF CONCRETE AND CONCRETE MATERIALS WILL BE CARRIED OUT BY TESTING LABORATORY DESIGNATED BY THE OWNER IN ACCORDANCE WITH CSA A23.1/A23.2.

14. INSPECTION OR TESTING BY CONSULTANT WILL NOT AUGMENT OR REPLACE CONTRACTOR QUALITY CONTROL NOR RELIEVE CONTRACTOR OF HIS CONTRACTUAL RESPONSIBILITY.



1	CONCRETE WALL CORNER DETAIL
S001	SCALE 1:20

ARCHITECTS: EVOQ

366 ADELAIDE ST. EAST, SUITE 225 TORONTO (ONTARIO) M5A 3X9 T. 647-723-2030

CLIENT

STRUCTURAL ENGINEER



G ojdrovic engineering

4195 Dundas St. W., Suite 233, Toronto ON MX8 1Y4 T 416.925.0333 F 416.925.3980 www.ojdrovic.com

Ø	ISSUED FOR TENDER	GS	NOV. 25-2020
			-

REVISION

THE GENERAL CONTRACTOR

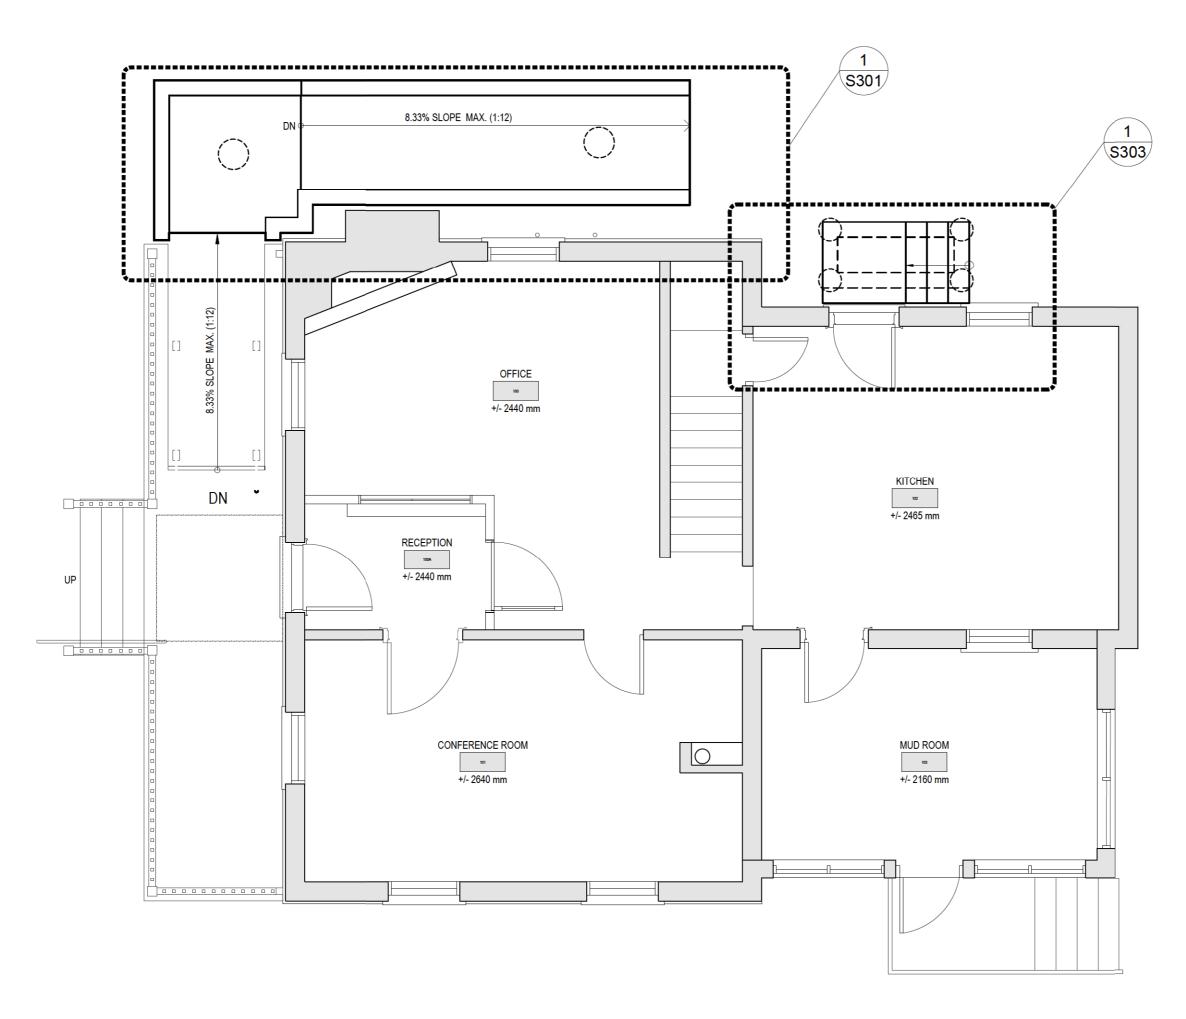
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PROJECT **REESOR NORTH OFFICE** ACCESSIBILITY IMPROVEMENTS 10725 REESOR ROAD, MARKHAM

DRAWING TITLE GENERAL NOTES AND TYPICAL DETAILS

PROJECT N .		9380	DRAWING N .		S001
PROJECT Nº:			DRAWING Nº:		
VERIFIED:	GS		SCALE:	N/A	
DRAWN:	AK		DATE:	2020-08-25	
DESIGN:	GS		APPROVED:	GS	



GROUND FLOOR PLAN ໌ 1 S101 SCALE 1:50



366 ADELAIDE ST. EAST, SUITE 225 TORONTO (ONTARIO) M5A 3X9 T. 647-723-2030

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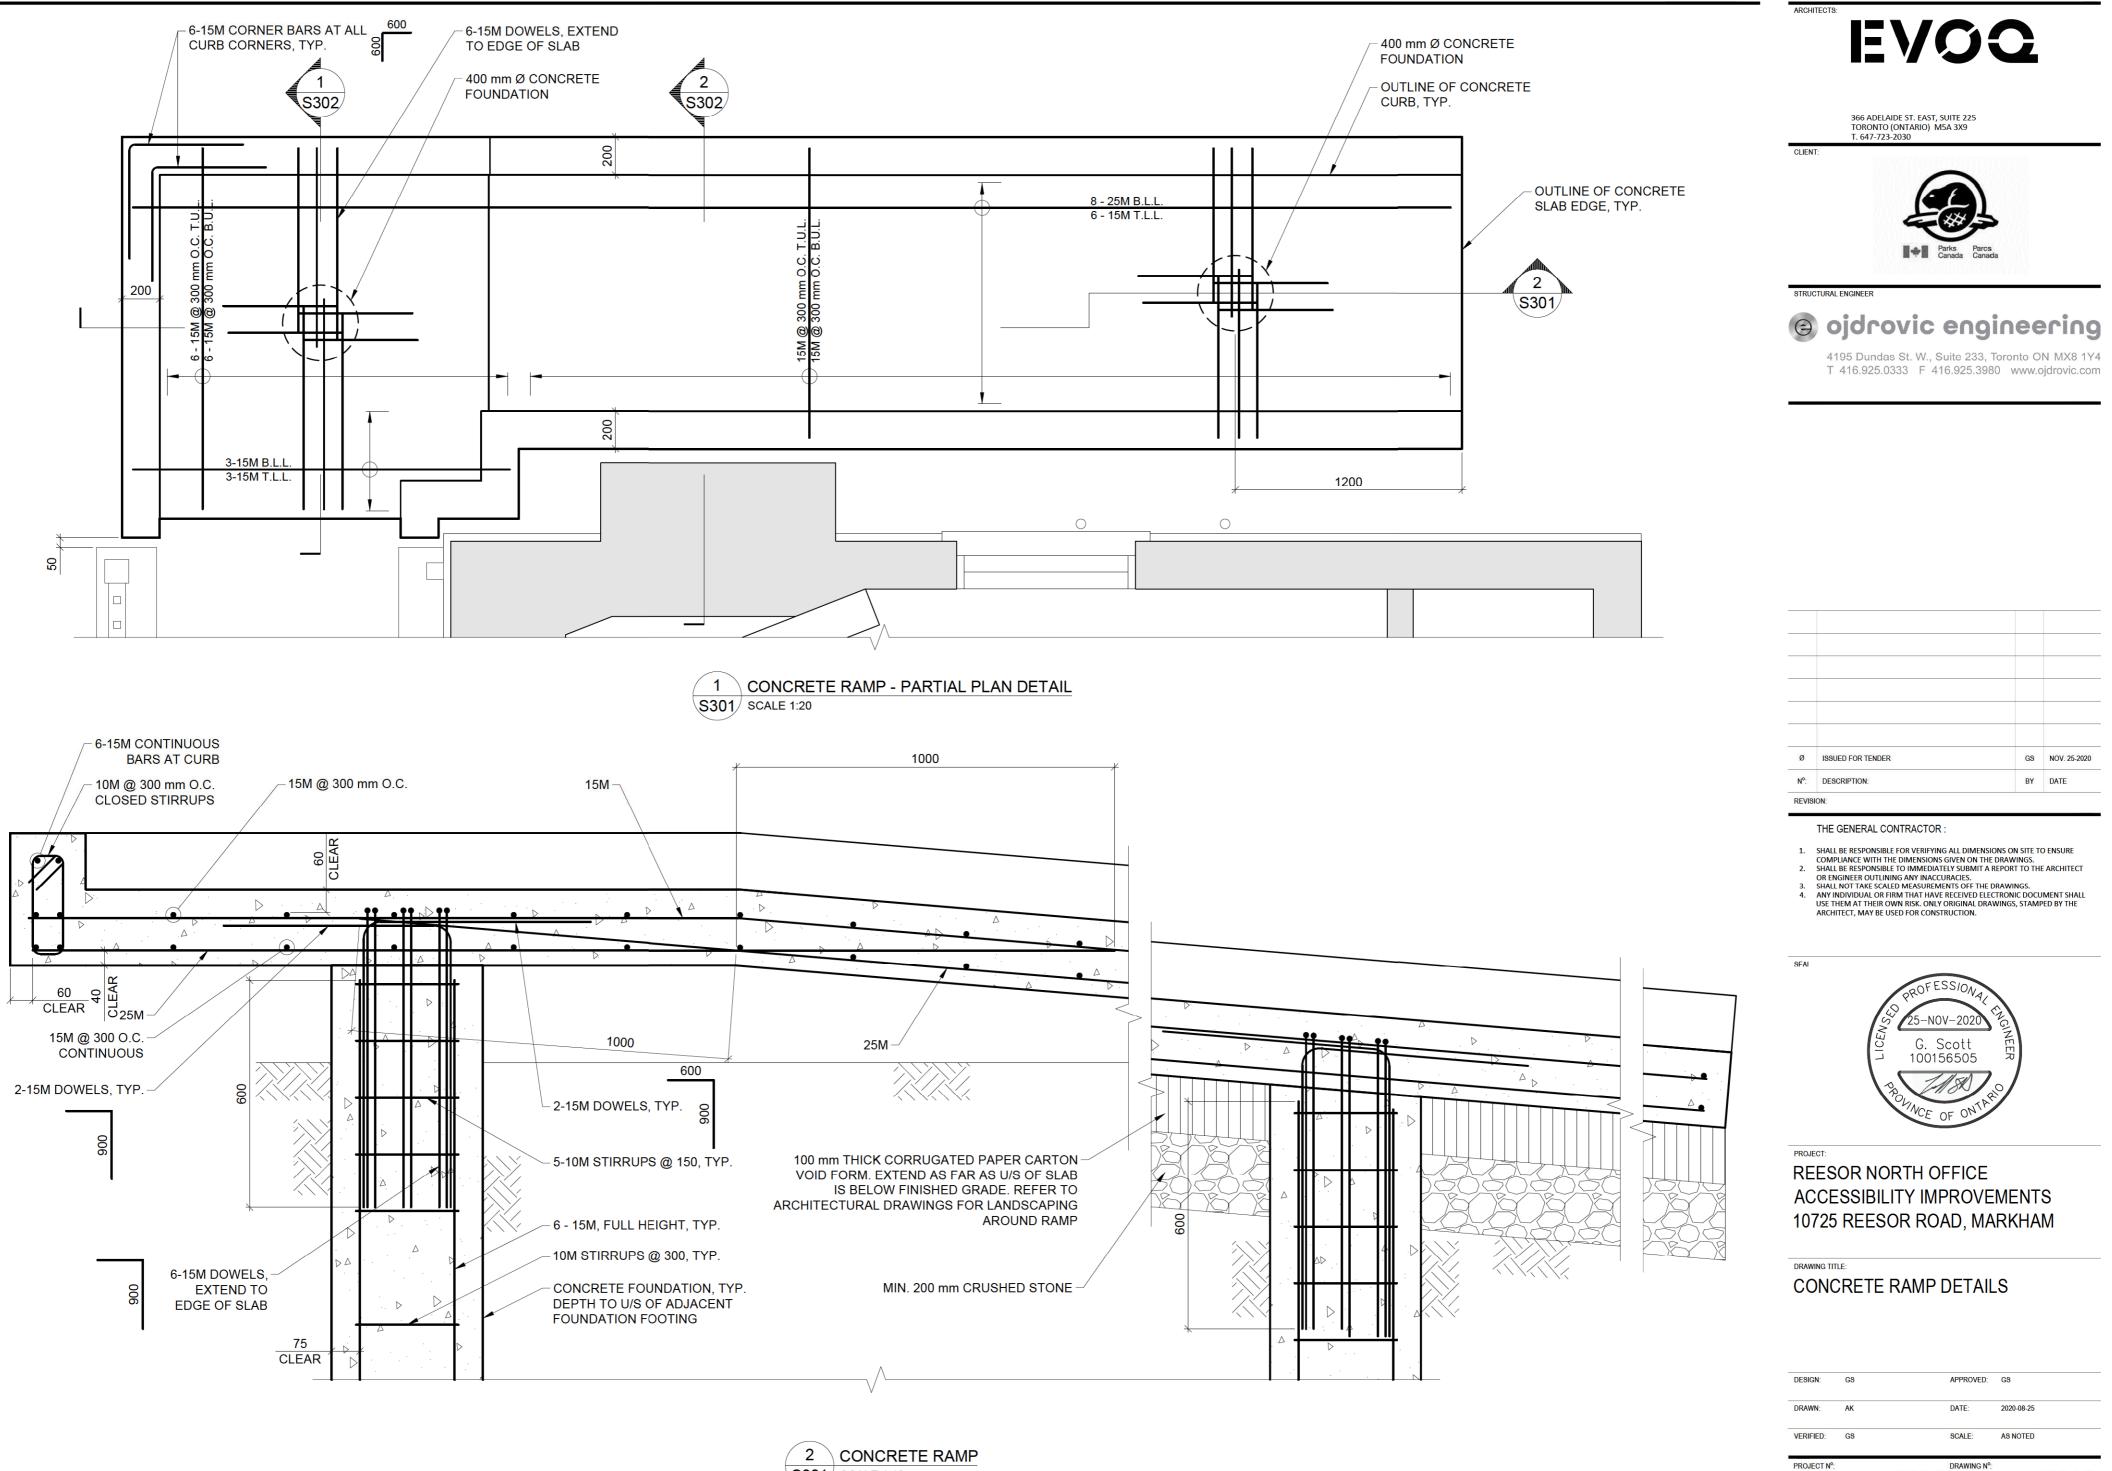


PROJECT:

REESOR NORTH OFFICE ACCESSIBILITY IMPROVEMENTS 10725 REESOR ROAD, MARKHAM

DRAWING TITLE: **GROUND FLOOR PLAN**

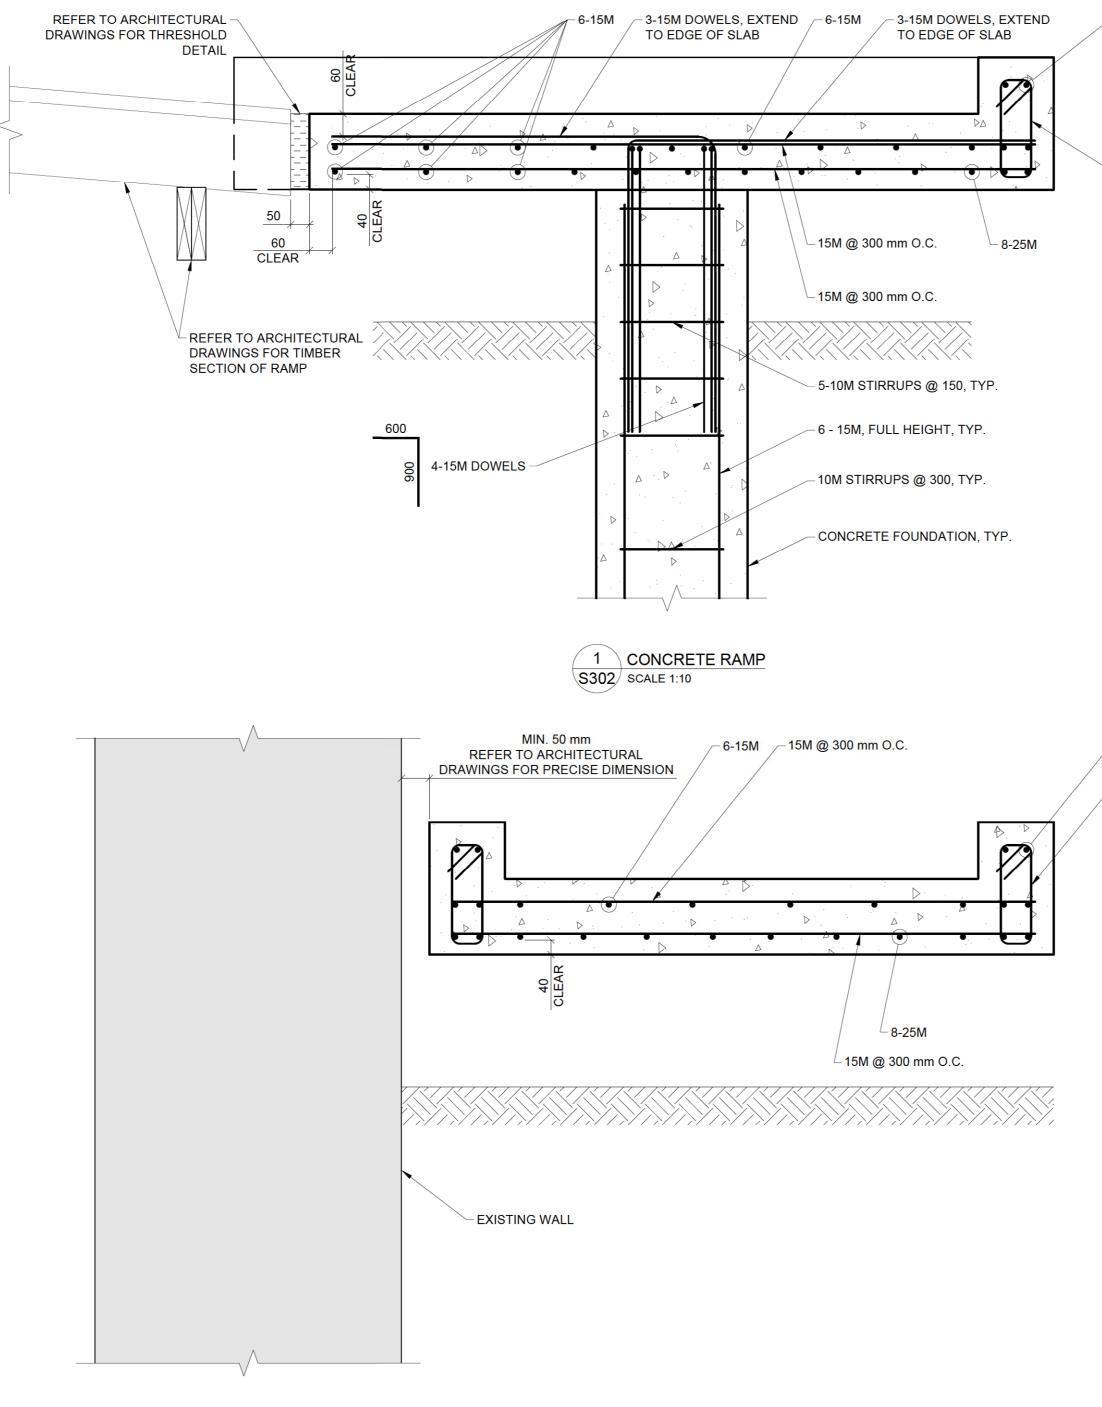
		9380			S101
PROJECT Nº:			DRAWING Nº:		
VERIFIED:	GS		SCALE:	AS NOTED	
DRAWN:	AK		DATE:	2020-08-25	
DESIGN:	GS		APPROVED:	GS	



S301 SCALE 1:10

DRAWING Nº: 9380

S301



- 6 - 15M CONTINUOUS

10M @ 300 mm O.C. CLOSED STIRRUPS

2 CONCRETE RAMP

S302 SCALE 1:10

6 - 15M CONTINUOUS, TYP.

10M @ 300 mm O.C. CLOSED STIRRUPS, TYP.



366 ADELAIDE ST. EAST, SUITE 225 TORONTO (ONTARIO) M5A 3X9 T. 647-723-2030

CLIENT:



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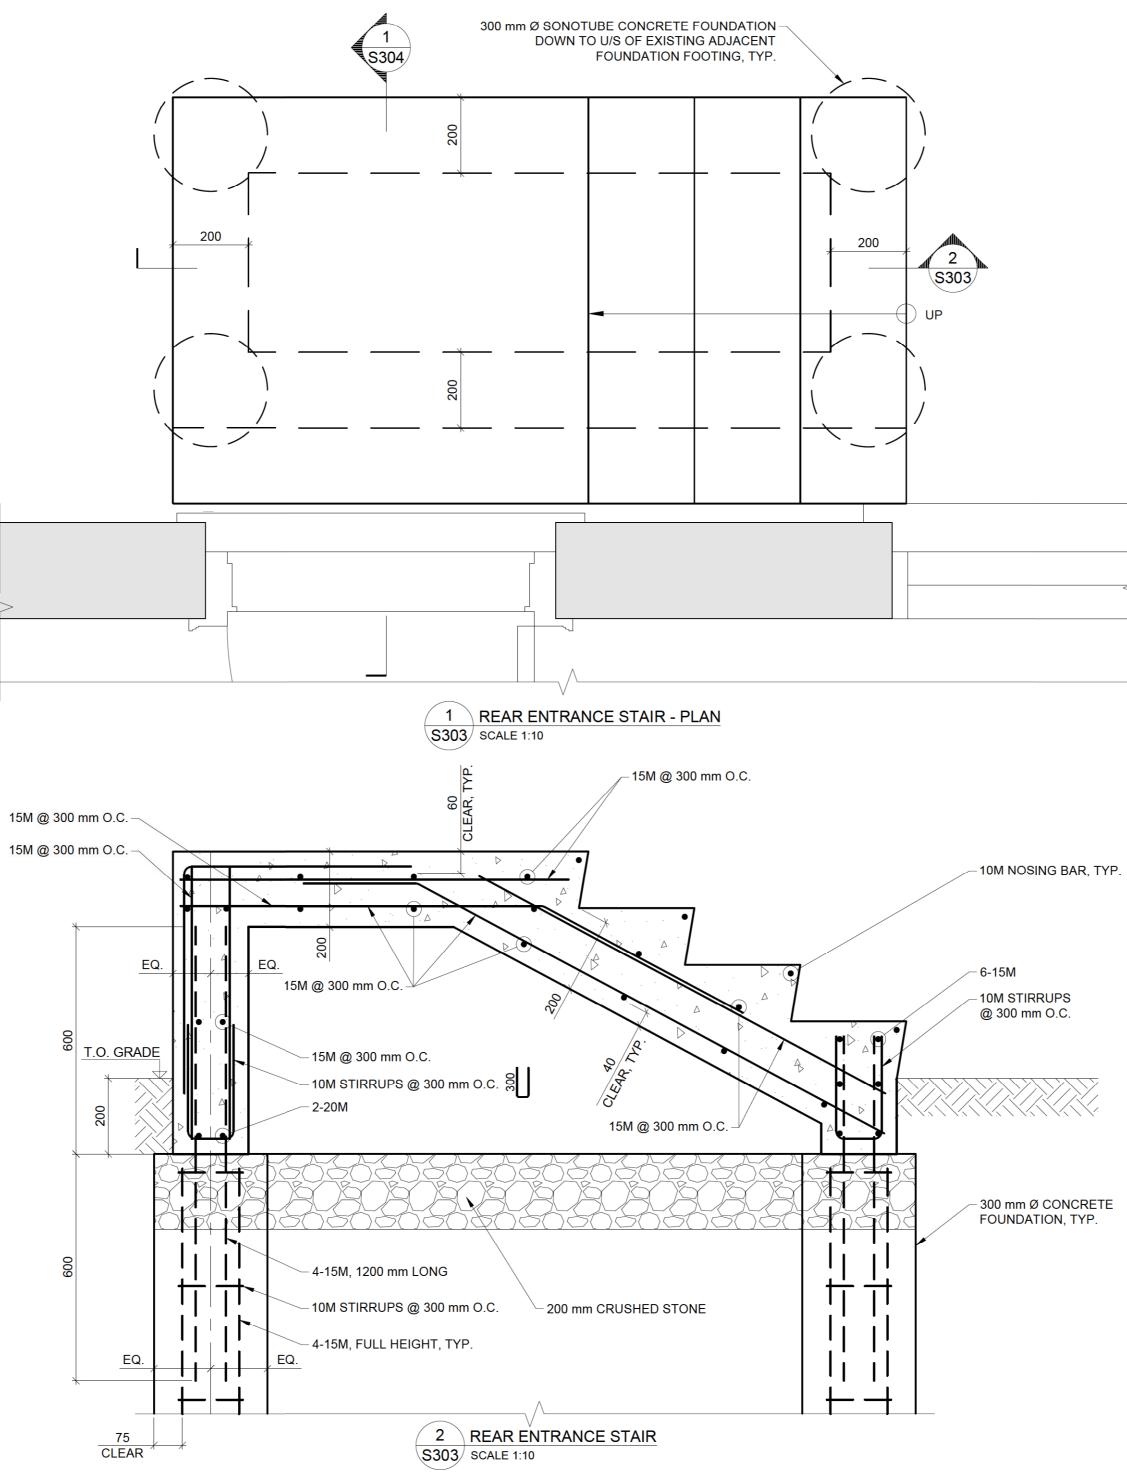
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PROJECT: REESOR NORTH OFFICE ACCESSIBILITY IMPROVEMENTS 10725 REESOR ROAD, MARKHAM

DRAWING TITLE: CONCRETE RAMP DETAILS

		0380			6303
PROJECT Nº:			DRAWING Nº:		
VERIFIED:	GS		SCALE:	AS NOTED	
DRAWN:	AK		DATE:	2020-08-25	
DESIGN:	GS		APPROVED:	GS	



ARCHITECTS: EVOQ

366 ADELAIDE ST. EAST, SUITE 225 TORONTO (ONTARIO) M5A 3X9 T. 647-723-2030

CLIENT:



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Ø	ISSUED FOR TENDER	GS	NOV. 25-2020
N ^o :	DESCRIPTION:	BY	DATE

REVISION:

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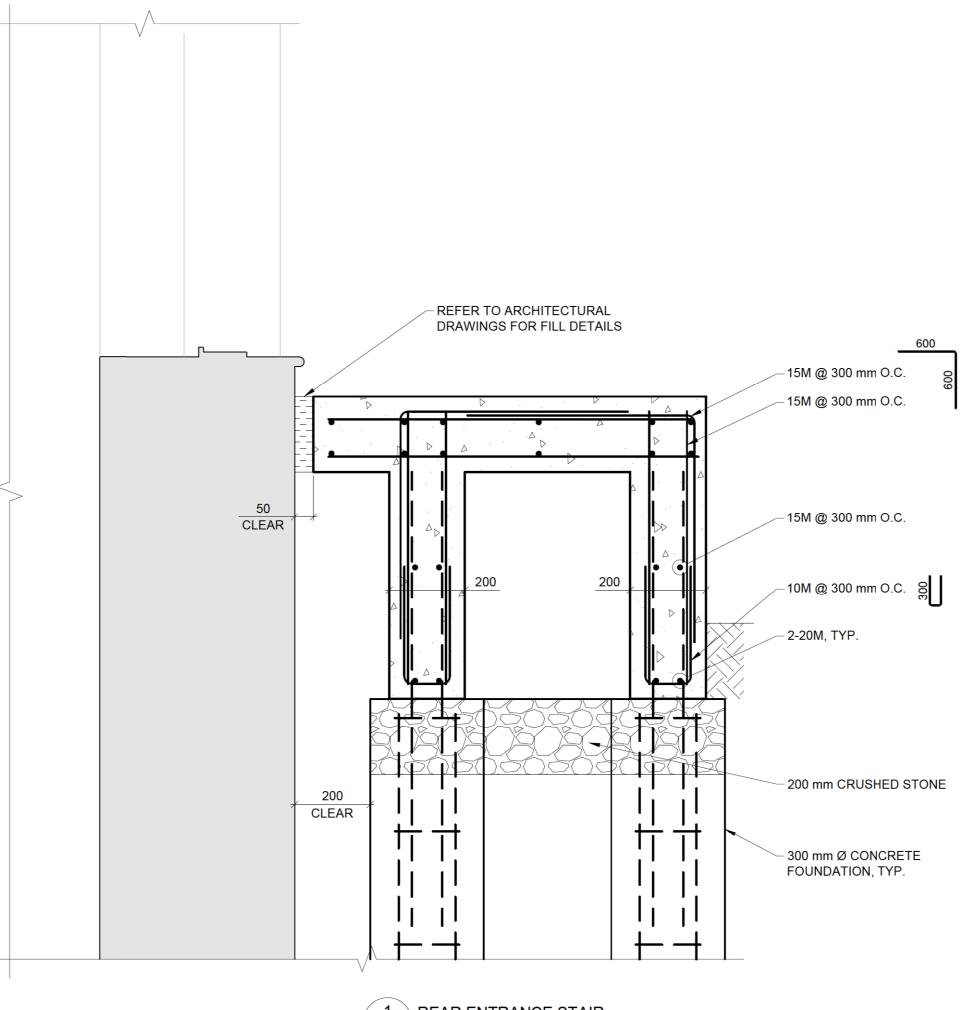
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PROJECT: REESOR NORTH OFFICE ACCESSIBILITY IMPROVEMENTS 10725 REESOR ROAD, MARKHAM

DRAWING TITLE: REAR ENTRANCE STAIR DETAILS

		9380			S303
PROJECT Nº:		DATE STORE SHOLE MENT	DRAWING Nº:		
VERIFIED:	GS		SCALE:	AS NOTED	
DRAWN:	AK		DATE:	2020-08-25	
DESIGN:	GS		APPROVED:	GS	



1 REAR ENTRANCE STAIR S304 SCALE 1:10



366 ADELAIDE ST. EAST, SUITE 225 TORONTO (ONTARIO) M5A 3X9 T. 647-723-2030

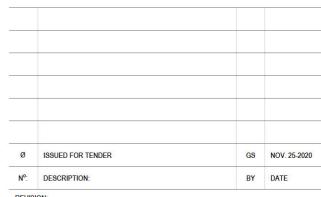
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DRAWING TITLE: REAR ENTRANCE STAIR DETAILS

DESIGN:	GS	APF	ROVED:	GS 2020-08-25	
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VERIFIED:	GS	SCA	ALE:	AS NOTED	
PROJECT Nº:		DRA	WING Nº:		0004
		9380			S304