


key plan

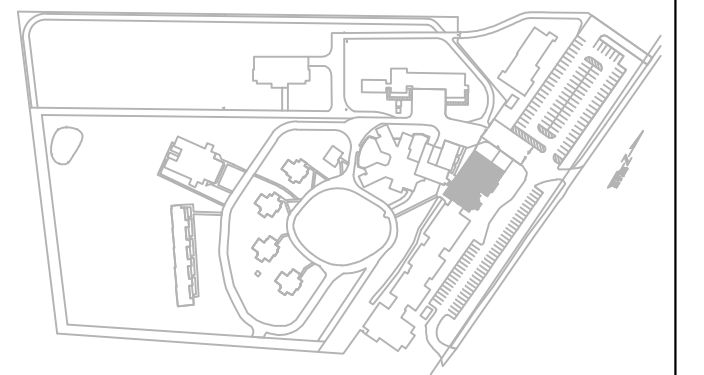

GENERAL NOTES:


EXISTING SIEMENS FIRE ALARM SYSTEM IS TO BE REPLACED WITH NEW GENERATION ADDRESSABLE FIRE ALARM SYSTEM.

EXISTING INITIATING AND SIGNAL CIRCUIT WIRING IS TO BE MAINTAINED, UNLESS INDICATED OTHERWISE.

EXISTING SPRINKLER COMPONENTS ARE NOT TO BE MODIFIED, ONLY ADDRESSABLE MODULES ARE TO BE REPLACED UNLESS INDICATED OTHERWISE.

FIRE ALARM NOTES:

- 1 EXISTING INITIATING CIRCUIT DEVICE TO BE REPLACED WITH NEW DEVICE.
- 2 EXISTING BELL/STROBE SIGNAL CIRCUIT DEVICE TO BE REPLACED WITH NEW HORN/STROBE DEVICE.
- 3 REMOVE FUSIBLE LINKS FROM EXISTING FIRE SHUTTERS. PROVIDE ELECTRIC SOLENOID KITS TO RELEASE SHUTTER ON ACTUATION OF SECOND STAGE FIRE ALARM.  
FEED FROM SPARE 15A-1P CIRCUIT BREAKER IN EXISTING PANEL "PBBB".
- 4 RELOCATE EXISTING MANUAL PULL STATION SUCH THAT IT IS 1100mm ABOVE THE FINISHED FLOOR. REPAIR WALL AND REPAIR WALL FINISH TO MATCH EXISTING FINISH.
- 5 EXTEND EXISTING FIRE ALARM INITIATING CIRCUITRY TO NEW DEVICE.
- 6 EXTEND EXISTING FIRE ALARM SIGNAL CIRCUITRY TO NEW DEVICE.
- 7 EXISTING ELEVATOR SHAFT SMOKE DETECTOR TO BE REMOVED AND REPLACED WITH NEW SAMPLING POINT.

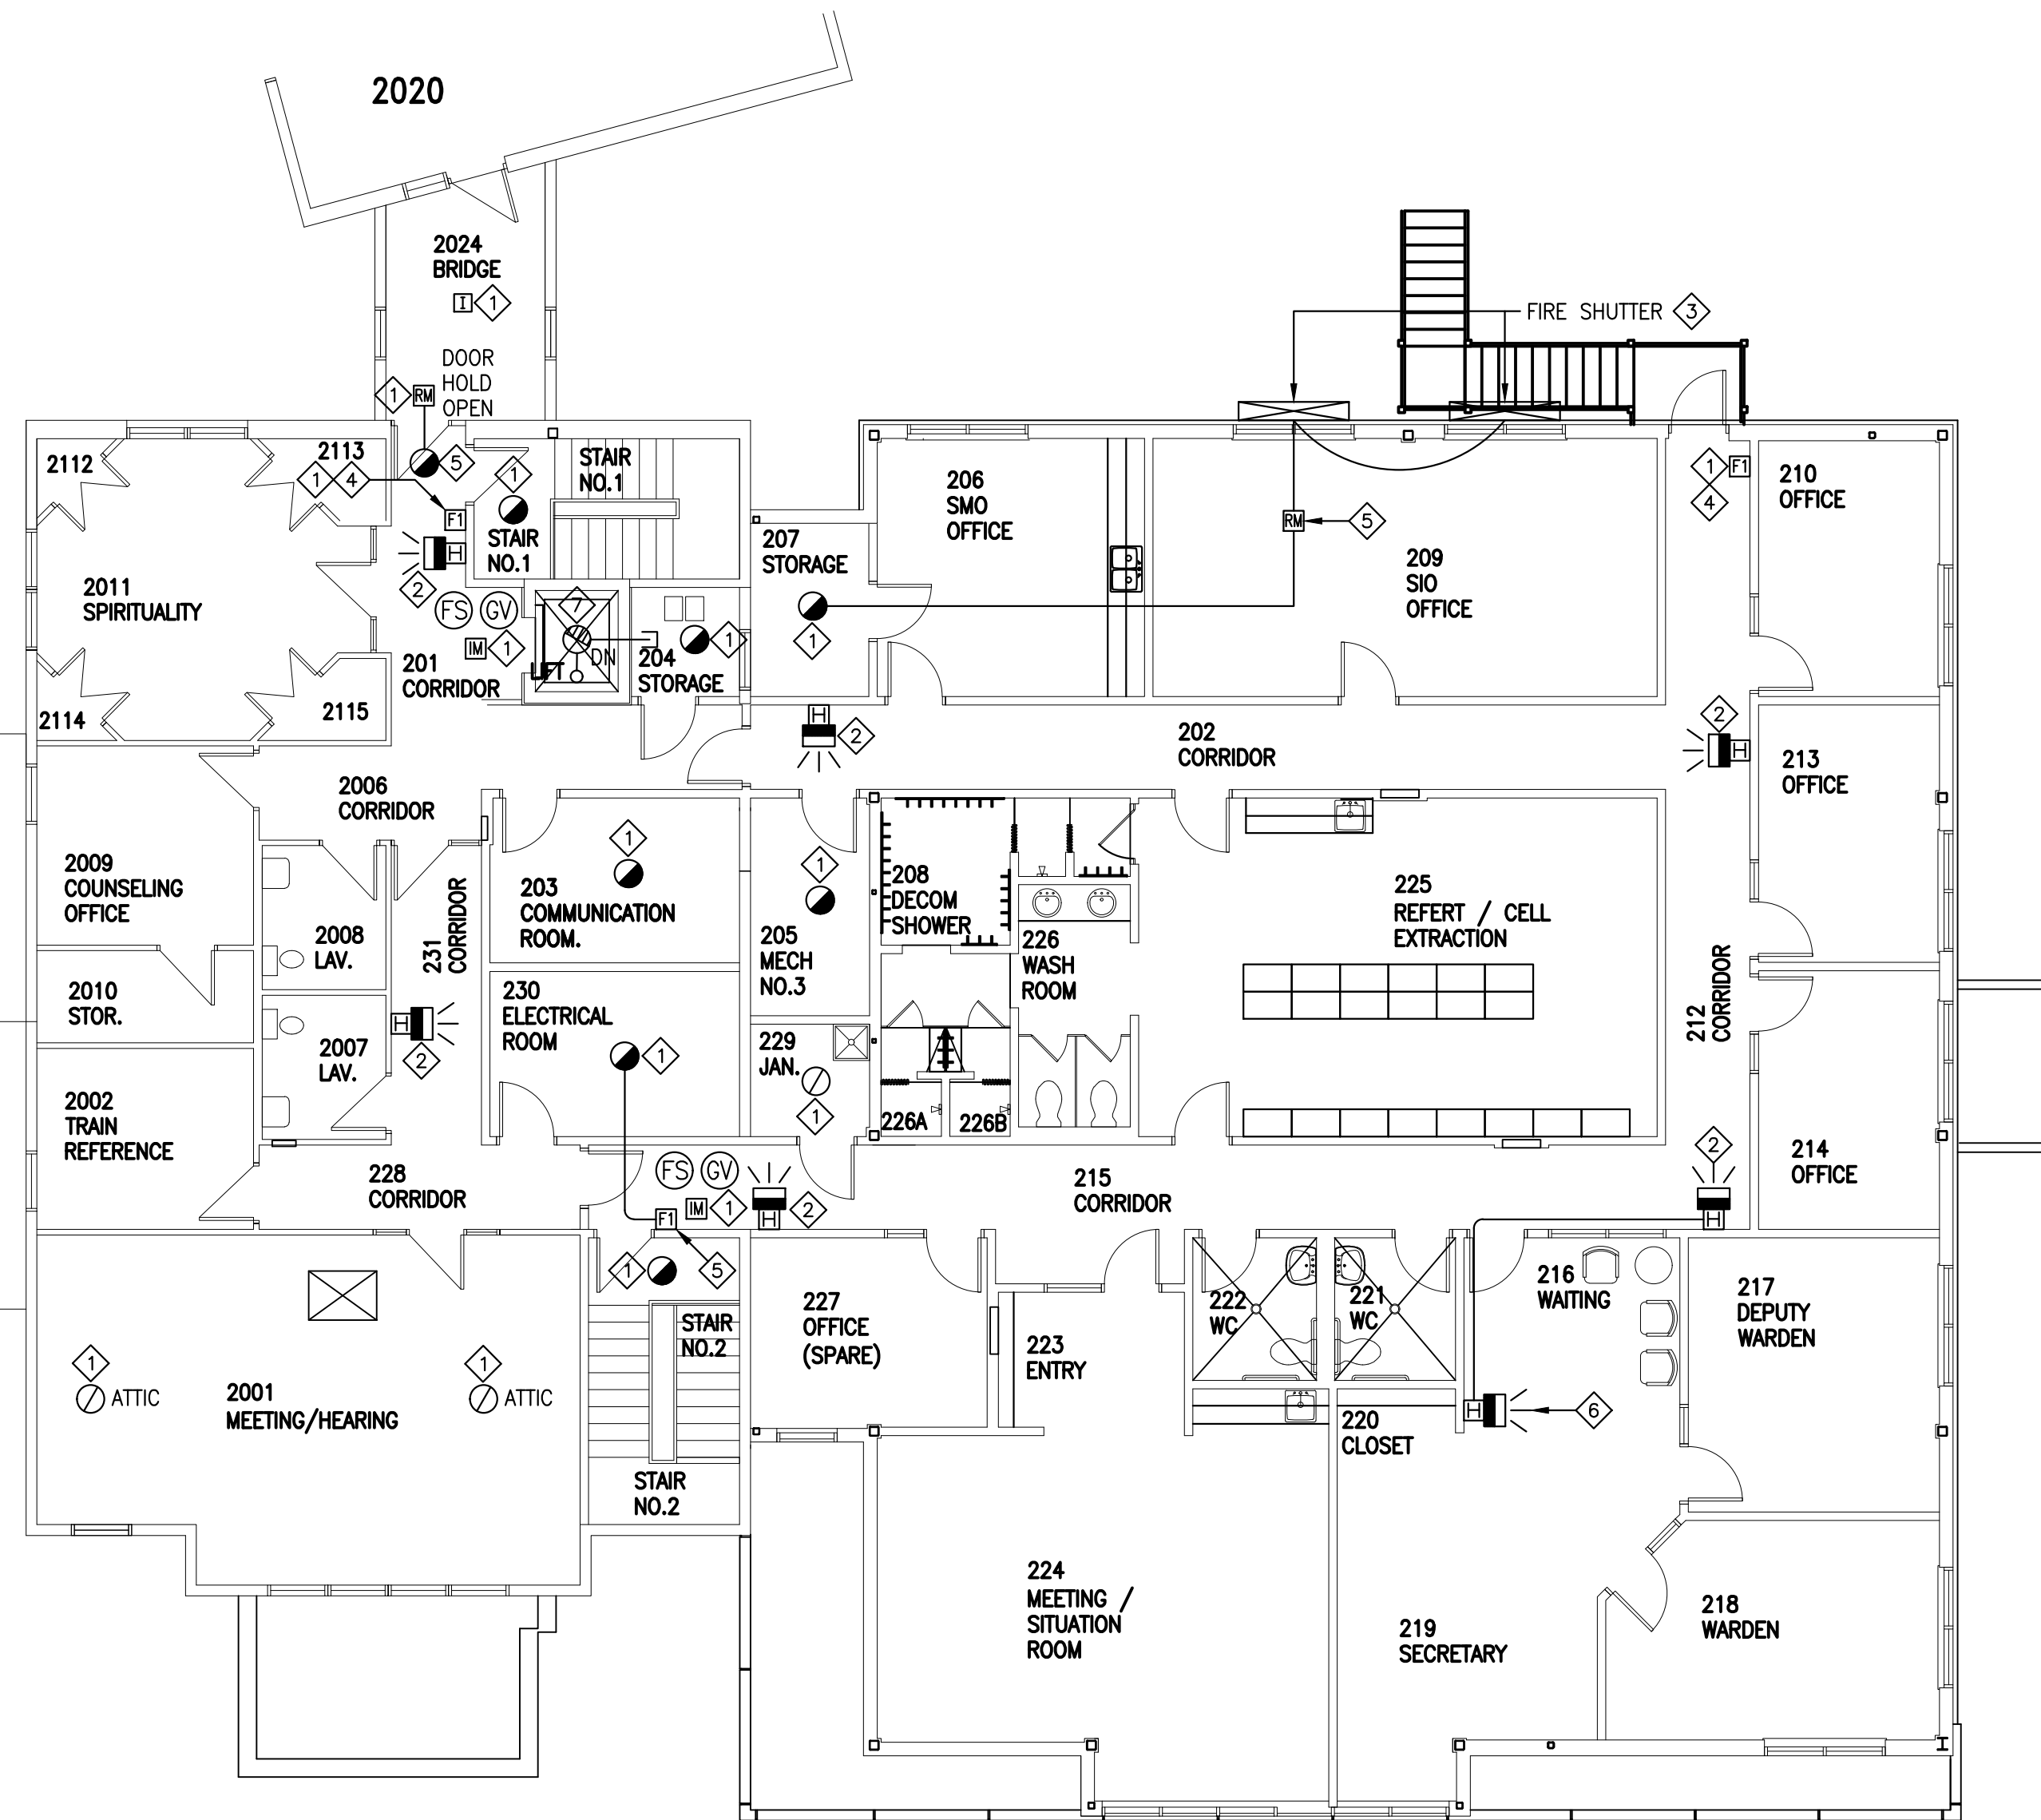


### LEGEND

2001 - MEETING / HEARING  
2002 - TRAIN REFERENCE  
2003 - WAITING  
2004 - JANITOR  
2006 - CORRIDOR  
2007 - WASHROOM  
2008 - WASHROOM  
2009 - COUNCELING OFFICE  
2010 - STORAGE  
2011 - SPIRITUALITY  
2012 - CLOSET  
2013 - CLOSET  
2014 - CLOSET  
2015 - CLOSET  
2024 - BRIDGE

201 - CORRIDOR  
202 - CORRIDOR  
203 - COMMUNICATION ROOM  
204 - STORAGE  
205 - MECHANICAL ROOM NO. 3  
206 - SMO OFFICE  
207 - STORAGE  
208 - DECOM SHOWER  
209 - SIO OFFICE  
210 - OFFICE  
212 - CORRIDOR  
213 - OFFICE  
214 - OFFICE  
215 - CORRIDOR  
216 - WAITING  
217 - DEPUTY WARDEN

218 - WARDEN  
219 - SECRETARY  
220 - CLOSET  
221 - WASHROOM  
222 - WASHROOM  
223 - ENTRY  
224 - MEETING / SITUATION ROOM  
225 - REFERT / CELL EXTRACTION  
226 - WASHROOM  
226A - SHOWER  
226B - SHOWER  
227 - SPARE OFFICE  
228 - CORRIDOR  
229 - JANITORIAL  
230 - ELECTRICAL ROOM  
231 - CORRIDOR

SCALE: 1:100

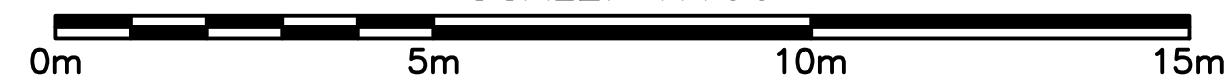

1	ISSUED FOR TENDER	10/27/2020
revisions		date
project	project	
FIRE ALARM UPGRADE NOVA INSTITUTION		
TRURO, NS		
drawing	dessin	
MAIN BUILDING SECOND FLOOR FIRE ALARM PLAN		
designed	PM	conçu
date	MARCH 2020	
drawn	BD	dessiné
date	MARCH 2020	
approved	RGR	approuvé
date	MARCH 2020	
Tender	Sourmission	
PWGSC Project Manager	Administrateur de projets TPSGC	
project number	no. du projet	
R.089585.001		
drawing no.	no. du dessin	