


**SITE LEGEND**

- A - MAIN BUILDING (REF. DRAWINGS E-2, E-3 & E-4)
- B - HEALTH SERVICES/IERT BUILDING (REF. DRAWINGS E-5 & E-6)
- F - FOOD/HEALTH SERVICES BUILDING (REF. DRAWINGS E-5 & E-6)
- G - SECURE UNIT (REF. DRAWINGS E-5 & E-6)
- M - MAINTENANCE BUILDING (REF. DRAWING E-7)
- PFV - PRIVATE FAMILY VISIT (REF. DRAWING E-11)
- Q - 14 BED MINIMUM SECURITY (REF. DRAWING E-8)
- R - FOOD SERVICES/PROGRAMS BUILDING (REF. DRAWING E-12)
- R1 - ROW HOUSE 1 (REF. DRAWING E-9)
- R2 - ROW HOUSE 2 (REF. DRAWING E-9)
- R3 - ROW HOUSE 3 (REF. DRAWING E-9)
- R4 - ROW HOUSE 4 (REF. DRAWING E-9)
- ROW - ROW HOUSE 5,6,7,8,9 (REF. DRAWING E-10)
- SLE - STRUCTURED LIVING ENVIRONMENT (REF. DRAWING E-11)

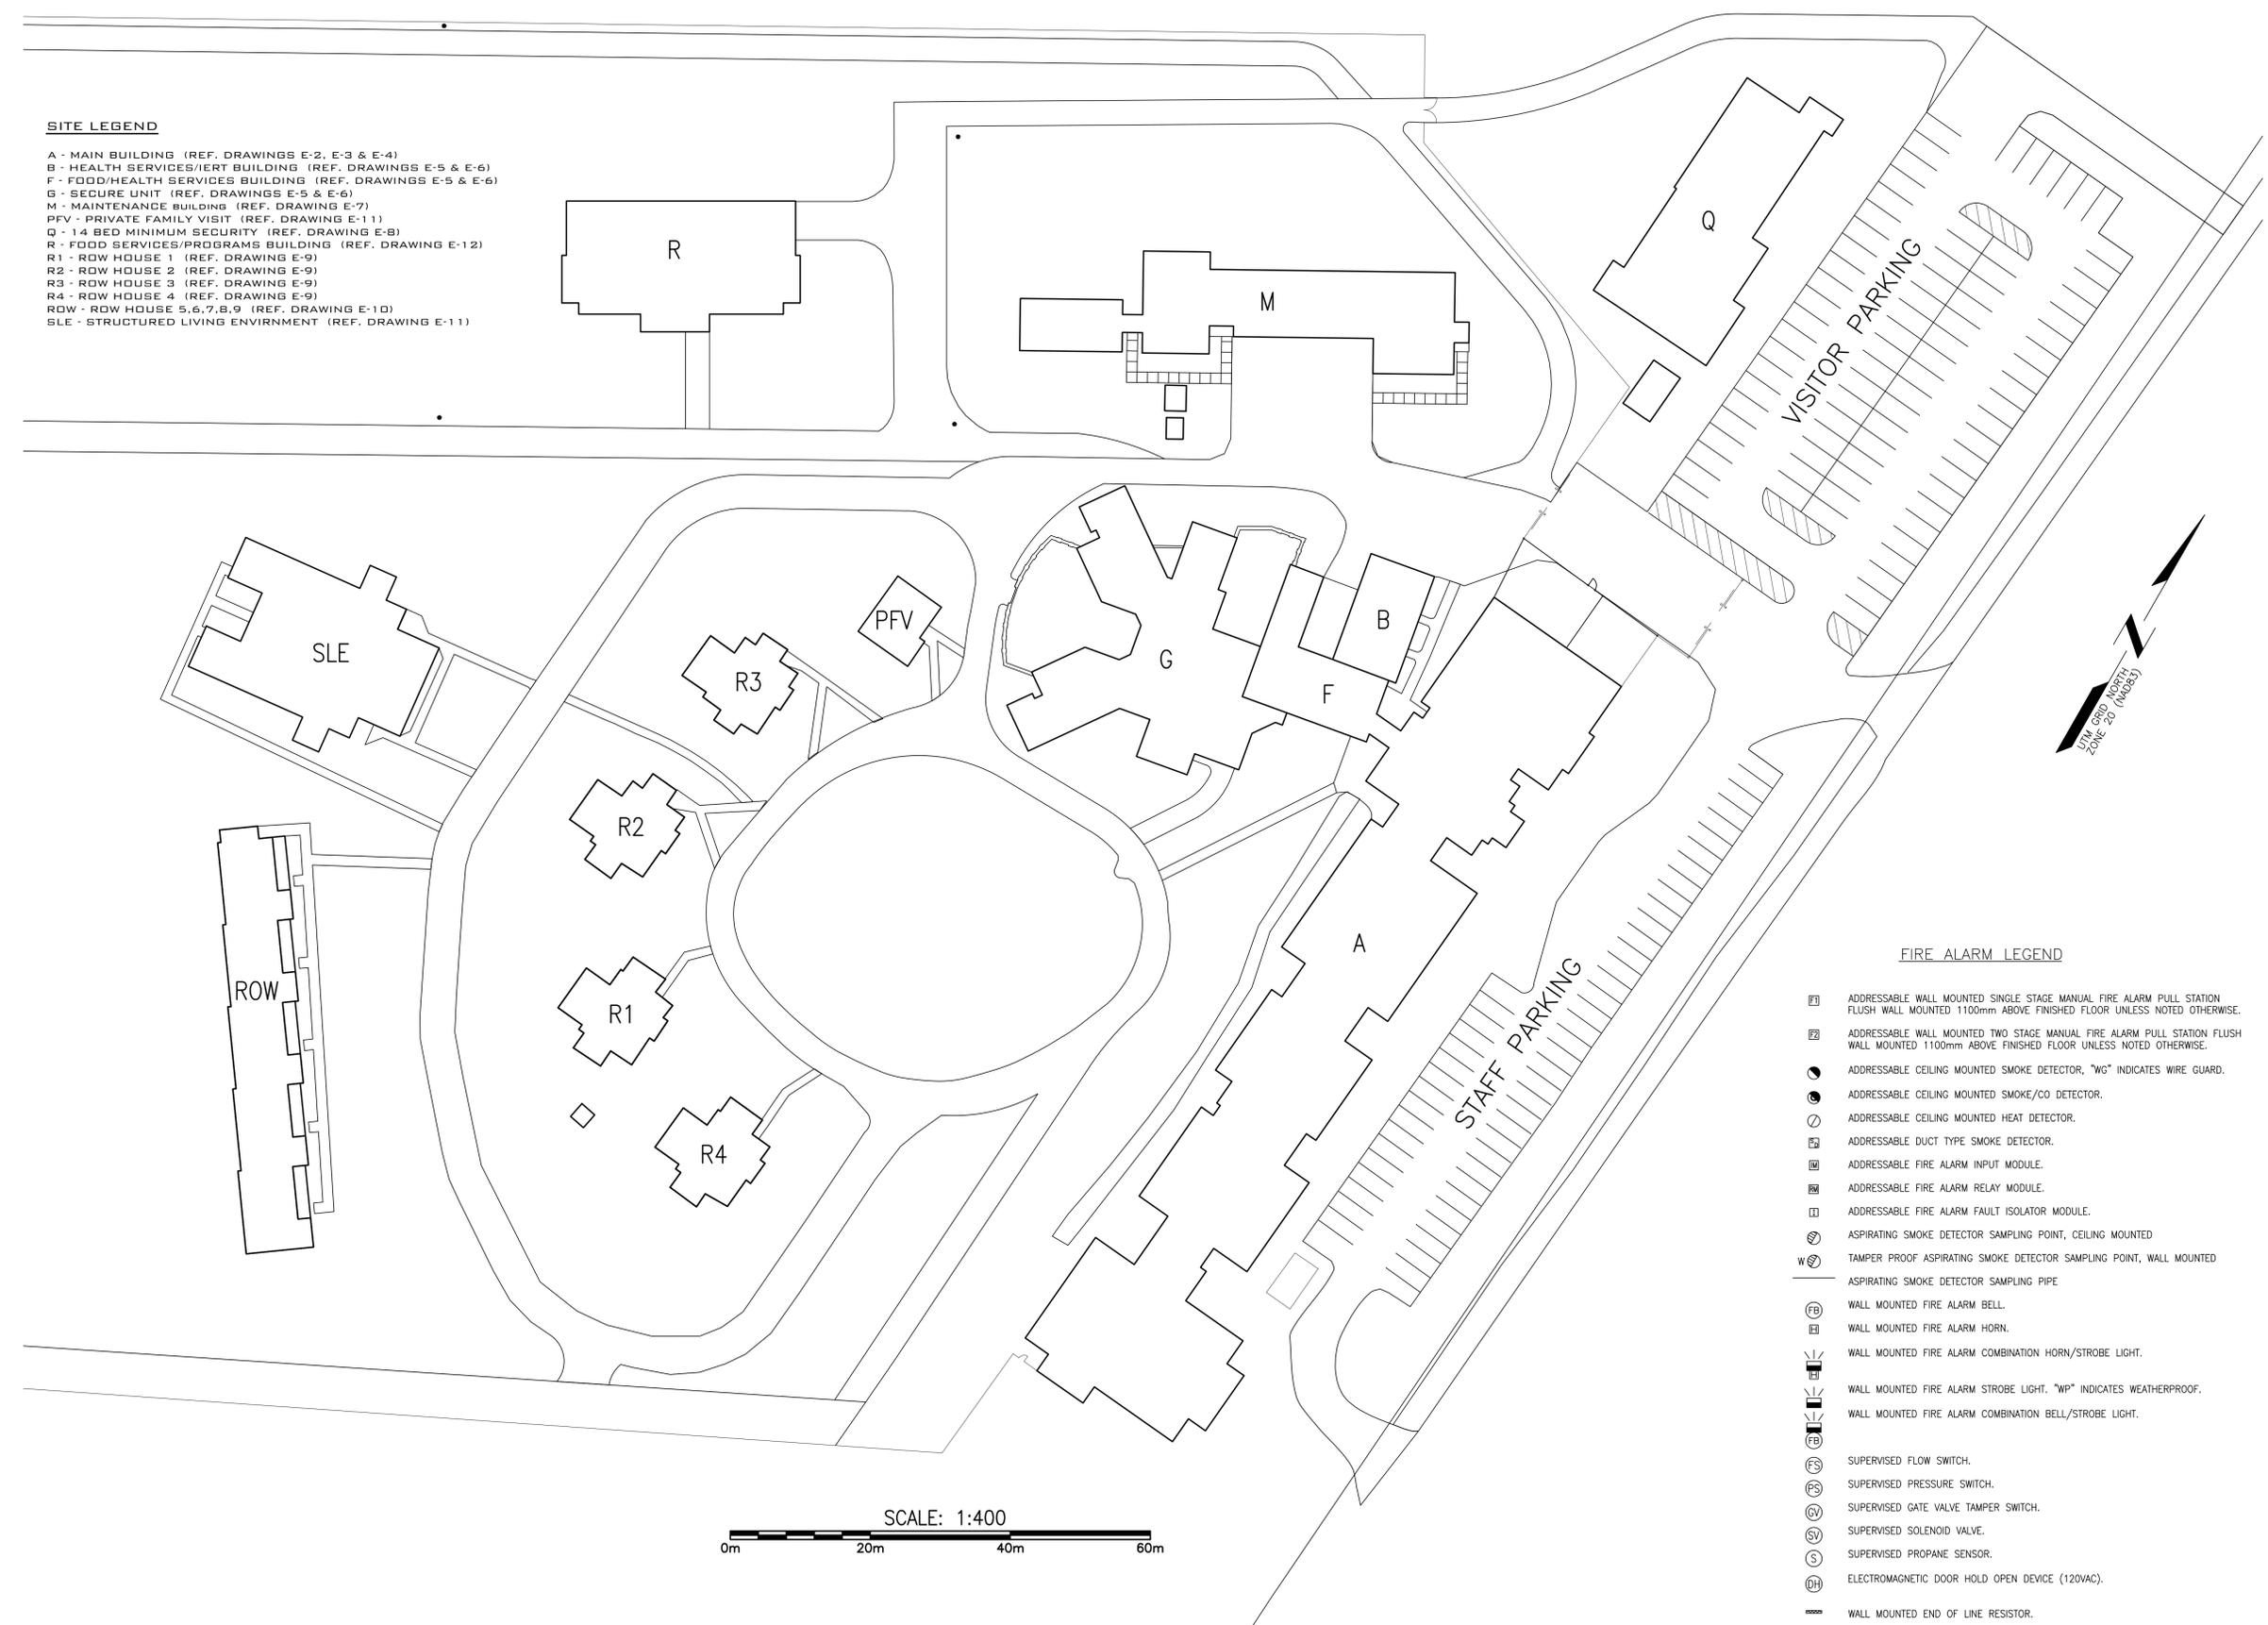

**FIRE ALARM LEGEND**

- ADDRESSABLE WALL MOUNTED SINGLE STAGE MANUAL FIRE ALARM PULL STATION FLUSH WALL MOUNTED 1100mm ABOVE FINISHED FLOOR UNLESS NOTED OTHERWISE.
- ADDRESSABLE WALL MOUNTED TWO STAGE MANUAL FIRE ALARM PULL STATION FLUSH WALL MOUNTED 1100mm ABOVE FINISHED FLOOR UNLESS NOTED OTHERWISE.
- ADDRESSABLE CEILING MOUNTED SMOKE DETECTOR, "WG" INDICATES WIRE GUARD.
- ADDRESSABLE CEILING MOUNTED SMOKE/CO DETECTOR.
- ADDRESSABLE CEILING MOUNTED HEAT DETECTOR.
- ADDRESSABLE DUCT TYPE SMOKE DETECTOR.
- ADDRESSABLE FIRE ALARM INPUT MODULE.
- ADDRESSABLE FIRE ALARM RELAY MODULE.
- ADDRESSABLE FIRE ALARM FAULT ISOLATOR MODULE.
- ASPIRATING SMOKE DETECTOR SAMPLING POINT, CEILING MOUNTED
- TAMPER PROOF ASPIRATING SMOKE DETECTOR SAMPLING POINT, WALL MOUNTED
- ASPIRATING SMOKE DETECTOR SAMPLING PIPE
- WALL MOUNTED FIRE ALARM BELL.
- WALL MOUNTED FIRE ALARM HORN.
- WALL MOUNTED FIRE ALARM COMBINATION HORN/STROBE LIGHT.
- WALL MOUNTED FIRE ALARM STROBE LIGHT. "WP" INDICATES WEATHERPROOF.
- WALL MOUNTED FIRE ALARM COMBINATION BELL/STROBE LIGHT.
- SUPERVISED FLOW SWITCH.
- SUPERVISED PRESSURE SWITCH.
- SUPERVISED GATE VALVE TAMPER SWITCH.
- SUPERVISED SOLENOID VALVE.
- SUPERVISED PROPANE SENSOR.
- ELECTROMAGNETIC DOOR HOLD OPEN DEVICE (120VAC).
- WALL MOUNTED END OF LINE RESISTOR.
- SURFACE MOUNTED FIRE ALARM PANEL.
- RECESSED OR SEMI-RECESSED FIRE ALARM PANEL.
- FIRE ALARM REMOTE ANNUNCIATOR PANEL.
- EXISTING FLUSH MOUNTED 120/208V BRANCH CIRCUIT PANEL.
- EXISTING SURFACE MOUNTED 120/208V BRANCH CIRCUIT PANEL.

**DOOR ANNUNCIATOR LEGEND**

- DOOR ANNUNCIATOR CONTROL PANEL.
- DOOR ANNUNCIATOR KEYPAD SURFACE WALL MOUNTED 1200mm A.F.F.
- DOOR ANNUNCIATOR MAGNETIC DOOR CONTACT.
- END OF LINE RESISTOR.

**DOOR ANNUNCIATOR LEGEND**

- DOOR ANNUNCIATOR CONTROL PANEL.
- DOOR ANNUNCIATOR KEYPAD SURFACE WALL MOUNTED 1200mm A.F.F.
- DOOR ANNUNCIATOR MAGNETIC DOOR CONTACT.
- END OF LINE RESISTOR.

SCALE: 1:400



1	ISSUED FOR TENDER	10/27/2020
revisions		date

project **FIRE ALARM UPGRADE NOVA INSTITUTION** project

**TRURO, NS**

drawing **ELECTRICAL SITE PLAN** design

designed	PM	conçu
date	MARCH 2020	
drawn	BD	dessiné
date	MARCH 2020	
approved	RGR	approuvé
date	MARCH 2020	

Tender	Soumission
PWSC Project Manager	Administrateur de projets TPSGC
project number	no. du projet
<b>R.089585.001</b>	
drawing no.	no. du dessin
<b>E-1</b>	