



NEW CONSTRUCTION FLOOR PLAN (1)
SCALE : 1:50


ITEM	DESCRIPTION
1	EXISTING WINDOW TO BE REPLACED WITH NEW WINDOW. REFER TO DETAIL #1, 2, & 3 ON SHEET A4 AND #1 & 2 ON SHEET A5 FOR ADDITIONAL INSTALLATION INFORMATION.
2	REPLACE THRESHOLD, WEATHERSTRIPPING AND DOOR SWEEP WITH NEW.
3	REPLACE EXISTING ATTIC HATCH DOOR AND FRAME WITH NEW. REFER TO DETAIL #4 ON SHEET A4 FOR ADDITIONAL INFORMATION.
4	PROVIDE NEW 150mm THICK BATT INSULATION ON TOP OF EXISTING BATT INSULATION. NEW BATT INSULATION IS TO RUN PARALLEL TO EXISTING BATT INSULATION. EXISTING BATT INSULATION TO BE ADJUSTED WITHIN ATTIC SPACE TO ALLOW NEW BATT INSULATION TO LAY ON A FLAT AND LEVEL PLANE. REFER TO DETAIL #6 ON SHEET A4 FOR FURTHER INFORMATION.
5	PROVIDE NEW 50mm CONCRETE FACED RIGID INSULATION AROUND PERIMETER OF FOUNDATION WALL. CONCRETE FACED RIGID INSULATION IS TO EXTEND 1220mm FROM UNDERSIDE OF EXISTING METAL WALL FLASHING. PROVIDE FOR EXCAVATION AND REINSTATEMENT AS REQUIRED AROUND PERIMETER TO FACILITATE INSTALLATION. REFER TO DETAIL #7 ON SHEET A4 FOR FURTHER INFORMATION.
6	PATCH EXISTING GWB CEILING AND WALLS IN VESTIBULE 108. PRIME AND PAINT ALL WALLS AND CEILING IN VESTIBULE 108 TO MATCH EXISTING.
7	PATCH AND PAINT AREA SURROUNDING ELECTRICAL PANEL TO MATCH ADJACENT EXTERIOR WALL.
8	INFILL AND PATCH AREA OF DEMOLISHED RETURN AIR GRILLE. PRIME AND PAINT WALLS TO MATCH EXISTING.
9	INFILL AND PATCH PENETRATION FOR NEW VACUUM LINES FROM EXTERIOR PELLET SILO. PRIME AND PAINT TO MATCH EXISTING.
10	INFILL AND PATCH AROUND NEW RETURN AIR GRILLE. PRIME AND PAINT WALLS TO MATCH EXISTING.
11	INSTALL NEW VINYL SOFFIT. SOFFIT TO BE INSTALLED AT A RATIO OF 1 VENTED SECTION FOR EVERY 4 NON-VENTED SECTIONS

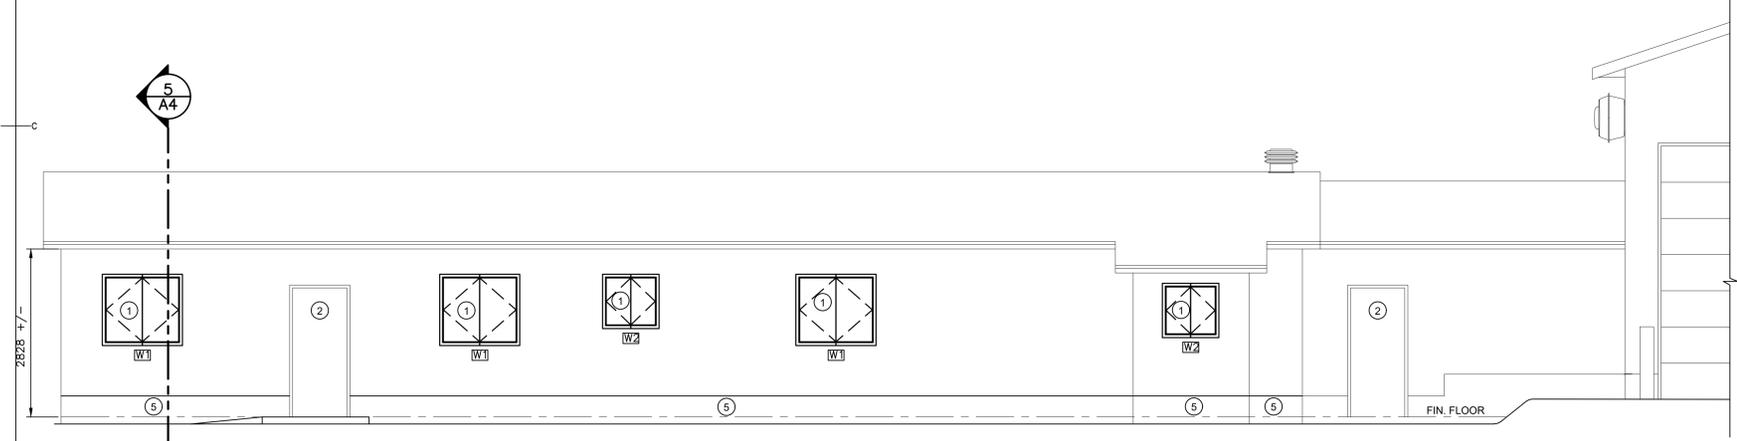


NEW CONSTRUCTION NORTH ELEVATION (2)
SCALE : 1:50

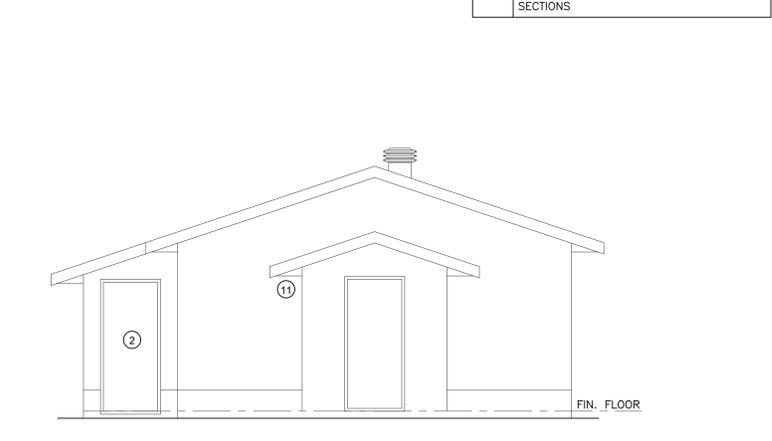

NEW CONSTRUCTION WEST ELEVATION (3)
SCALE : 1:50

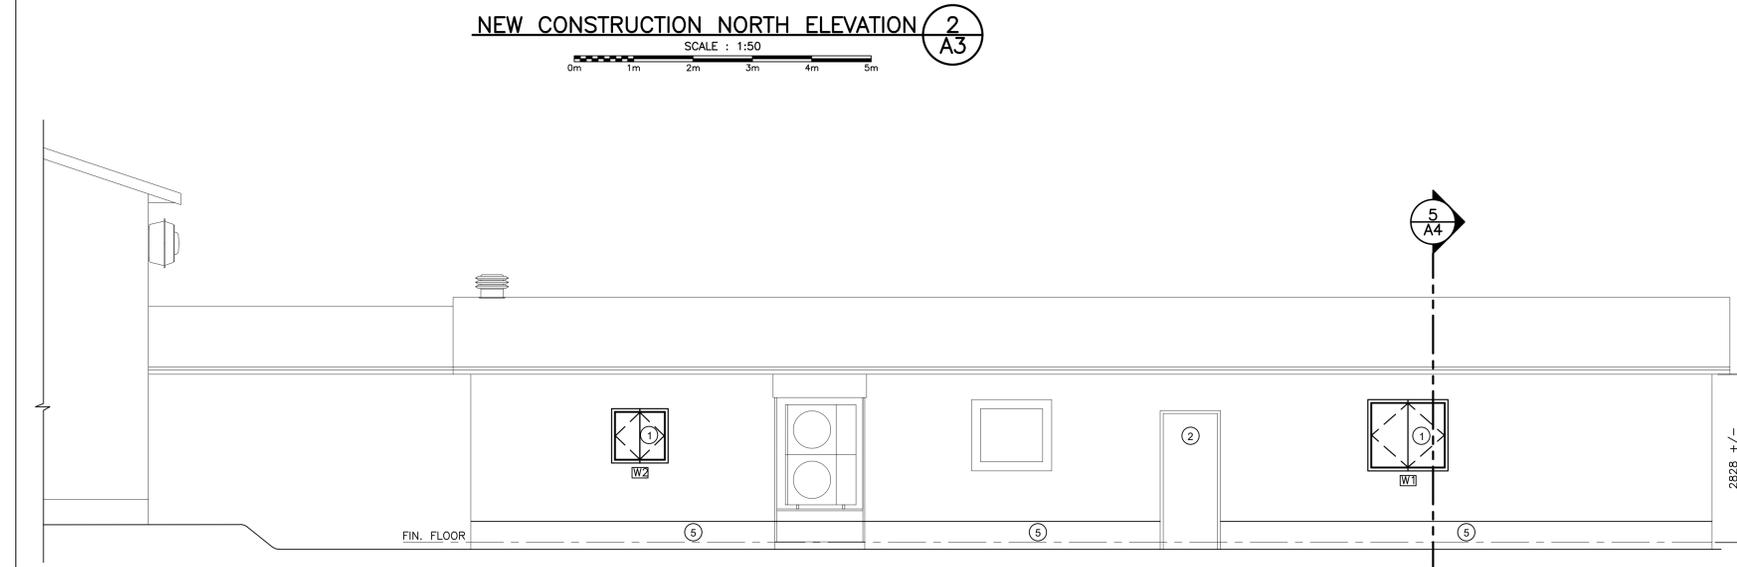

NEW CONSTRUCTION SOUTH ELEVATION (4)
SCALE : 1:50

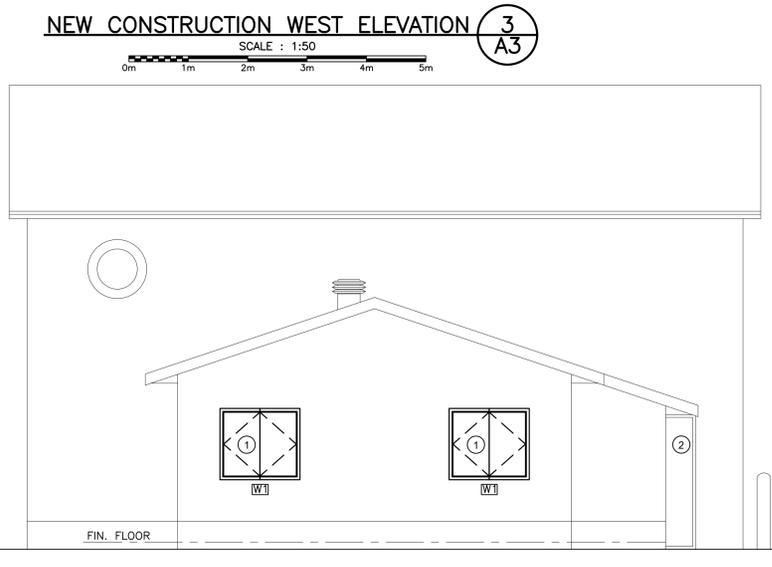

NEW CONSTRUCTION EAST ELEVATION (5)
SCALE : 1:50

Public Works and Government Services Canada / Travaux Publics et Services gouvernementaux Canada

Architecture • Engineering • Project Management

PROVINCE OF NEWFOUNDLAND AND LABRADOR
PERMITS PERMIT HOLDER
 This Permit Allows
COLES ASSOCIATES LTD.
 To practice Professional Engineering in Newfoundland and Labrador.
 Permit No. as issued by REGULATION 0503 which is valid for the year 2020.

0	Issued for Tender	06/18 2020
revisions		date
project	DFO ST. LEWIS BUILDING UPGRADES	
drawing	ARCHITECTURAL NEW CONSTRUCTION FLOOR PLAN, SECTION & ELEVATIONS	
designed	conçu	
date	A.E.M., E.I.T. dessiné	
drawn	JUNE 2020 date	
approved	N.R.W., GSC, C.Tech, RSE approuvé	
date	JUNE 2020 date	
Tender	Soumission	
PWSC Project Manager	Administrateur de projets TPSGC	
project number	no. du projet	
	R.108233.001	
drawing no.	no. du dessin	
	A3 OF 6	

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