

1 COAST GUARD RD, PRINCE RUPERT, BC V8J 3R1

CODE LOAD CALCULATION:

BASIC GARAGE AREA (442 sq. m. @ 10W/sq. m.) OFFICE AREA (116 sq. m. @50W/sq. m.)

MECHANICAL LOADS

MOTOR (9kW AT 75% DEMAND LOAD)
GROUDD POWER UNIT HEAT (6 x 500W @ 75% DEMAND) HOT WATER TANK (3000W @ 75% DEMAND)

MIN. MAIN BREAKER @ $\frac{600}{347}$ V, $3\emptyset = \frac{50,270W}{600V\sqrt{3}}$ x 1.25 = 60A FULL GENERATOR STANDBY ALLOWING 0% HEADROOM.

CIVIC ADDRESS

Public Works and Government Services Services gouvernementaux Canada REAL PROPERTY SERVICES Pacific Region SERVICES IMMOBILIERS

Région de Pacifique

= 4,420 W = 5,800 W

= 6,750 W = 20,500W = 8,300 W

= 2,250W = 2,250W

= 50,270W

ANNOTATIONS				
SYMBOL	DESCRIPTION			
4	REFERENCE NOTE (1 DENOTES SEE NOTE 1)			
	NEW EQUIPMENT			
	EXISTING EQUIPMENT TO REMAIN			
	EXISTING EQUIPMENT TO BE REMOVED			

SINGLE LINE DIAGRAM SYMBOLS

SYMBOL	DESCRIPTION			
	AUTOMATIC TRANSFER SWITCH WITH DOUBLE BYPASS			
6	GENERATOR			
•~•	MOLDED CASE CIRCUIT BREAKER. "L" WHERE SHOWN, DENOTES DEVICE c/w CURRENT LIMITERS			
۰۰۰	BREAKER DISCONNECT SWITCH			
- 	CONTACT - NORMALLY CLOSED			
—@R—	CONTROL RELAY			
C	CONTACTOR - AUTOMATIC RESET TYPE			
M	METER			
	BUSBAR			
•	CONNECTION POINT			
SPD	SURGE PROTECTION DEVICE			
	PANELBOARD			

DRAWING LIST				
DRAWING NUMBER DRAWING TITLE				
E-001	ELECTRICAL LEGEND, SITE KEYPLAN AND GENERAL NOTES			
E-002	ELECTRICAL PLAN AND SINGLE LINE DIAGRAM			
E-003	ELECTRICAL DETAILS AND SCHEDULE			
S-001 STRUCTURAL GENERAL NOTES, SITE PLAN AND TYPICAL GENERAL SITE SITE SITE SITE SITE SITE SITE SITE				

	POWER SYMBOLS				
	SYMBOL	DESCRIPTION			
SINGLE SURFACE MOUNTED / FLUSH MOUNTED PANELBOARD, "PP" DENOTE POWER PANEL, "LP" DENOTES LIGHTING AND POWER PANEL,					
	ن	DISCONNECT SWITCH UNLESS NOTED OTHERWISE			

SITE	SYMBOL
CRIPTION	

¿ - - ∪/G - - - UNDERGROUND SERVICE CONDUCTORS

SYMBOL

FIRE ALARM SYMBOLS
DESCRIPTION
FIRE ALARM PULL STATION MOUNTED 4'-0" (1200) ABOVE FINISHED FLOOR LEVEL UNLESS OTHERWISE NOTED.

RECESSED OR SURFACE MOUNTED FIRE ALARM CONTROL PANEL.

	SECURITY
SYMBOL	DESCRIPTION
MD	SECURITY SYSTEM MOTION DETECTOR



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Drawing title / Titre du dessi
ELECTRICAL LEGEND, SITE

PWGSC, Project Manager / Administrateur de Projets GRC

ISSUED FOR TENDER

Project title / Titre du projet

Consultant Approval Box Only

Designed by / Concept par

Drawn by / Dessine par

DT/MRO

Description


ROYAL CANADIAN MOUNTED **POLICE**

PRINCE RUPERT HANGAR GENERATOR UPGRADE

2020/10/07 Y/M/D

Sheet / Feuille E-001 R.105637.001

KEYPLAN AND GENERAL NOTES

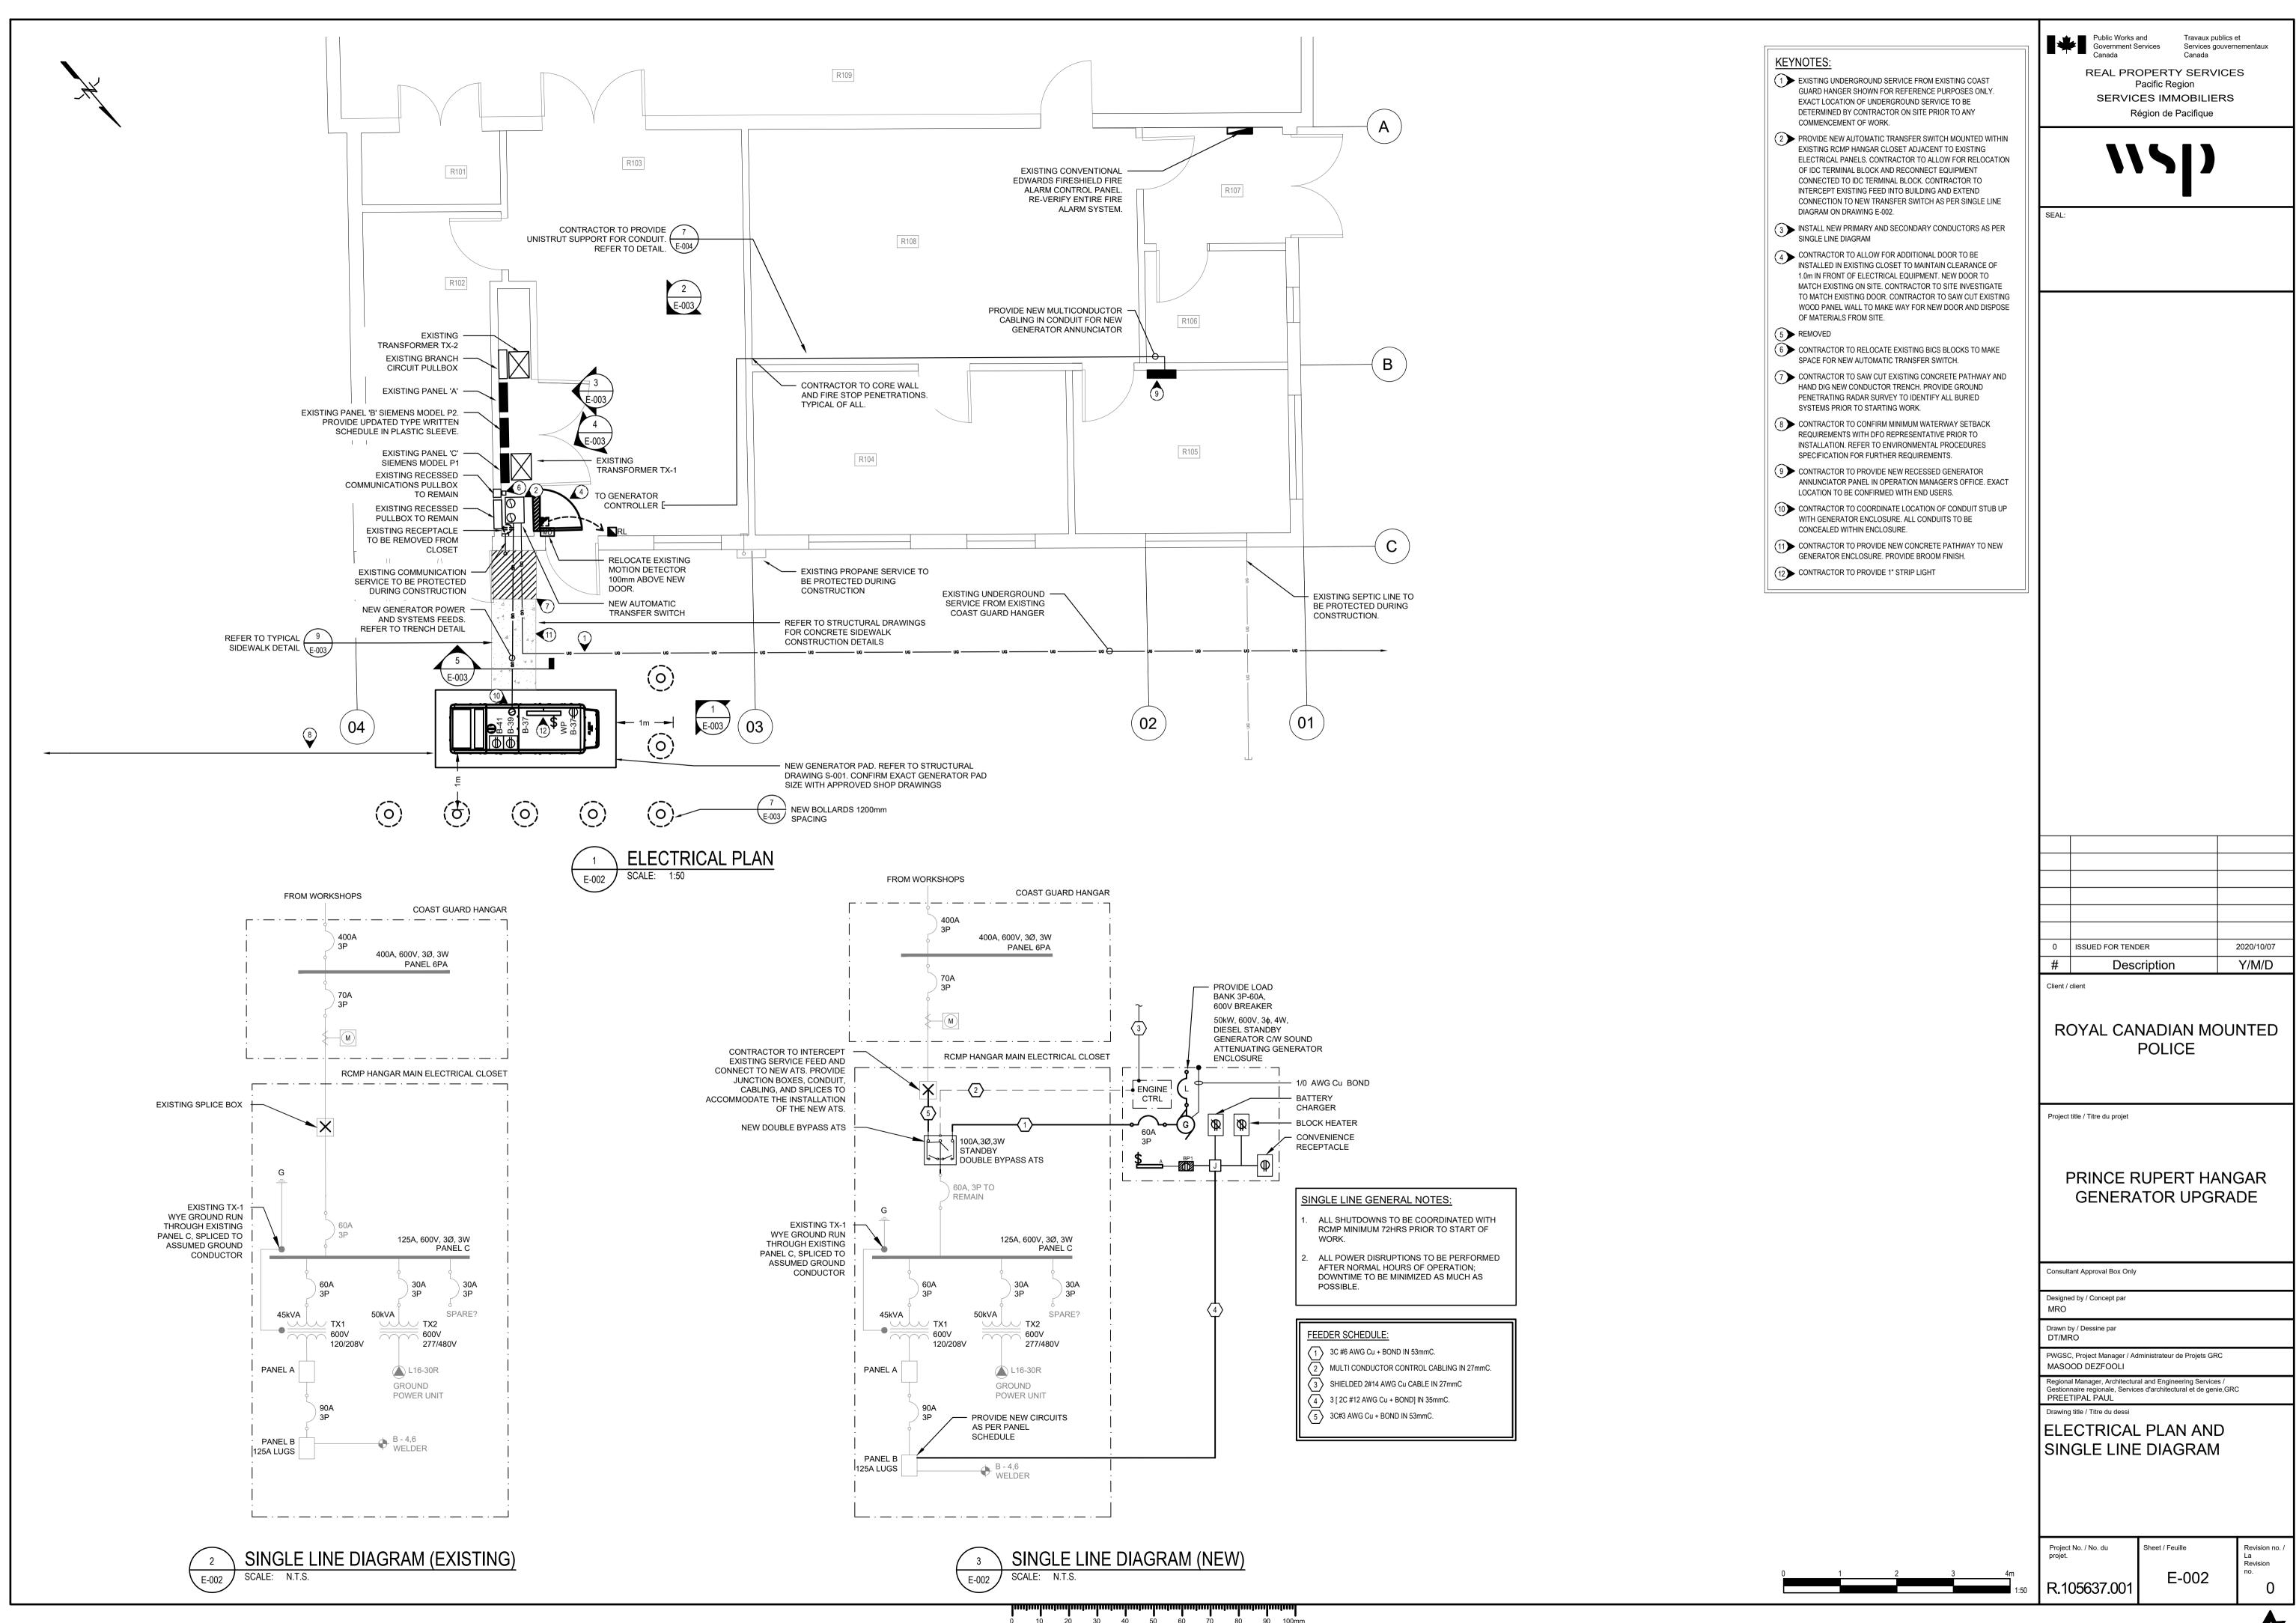

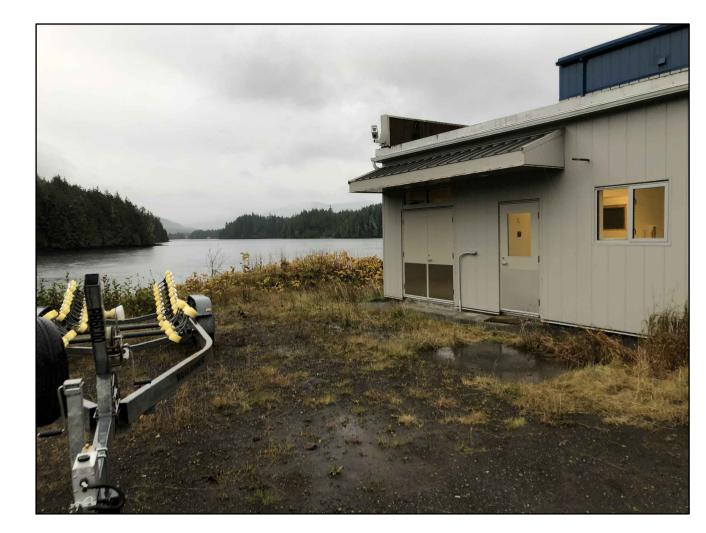


IMAGE 1 - SITE CONDITIONS



IMAGE 2- ELECTRICAL CLOSET



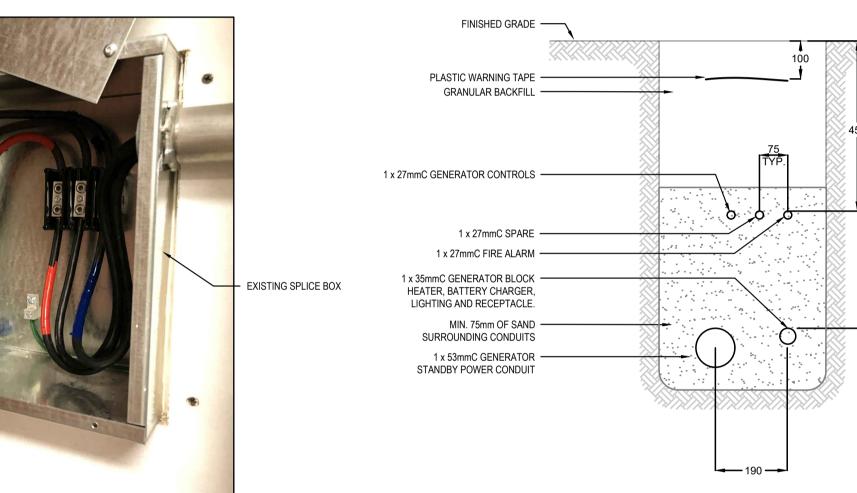



IMAGE 4 - ELECTRICAL CLOSET SERVICE DEMARK



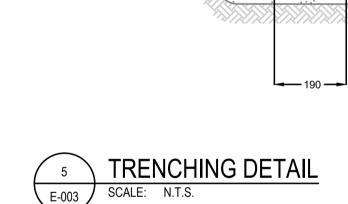

BOLLARD DETAIL

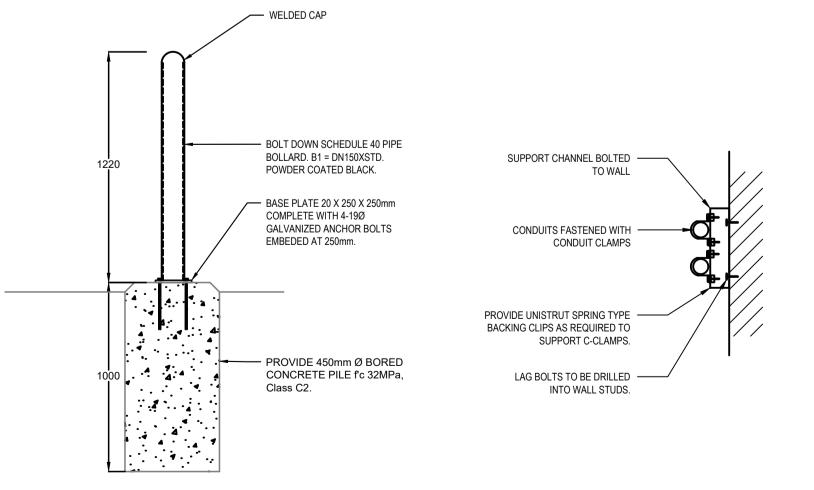


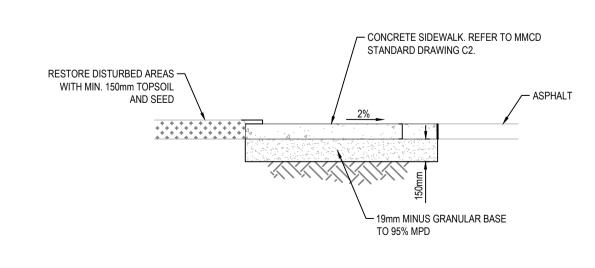

SIDEWALK DETAIL SCALE: N.T.S.



IMAGE 3 - ELECTRICAL CLOSET DISTRIBUTION

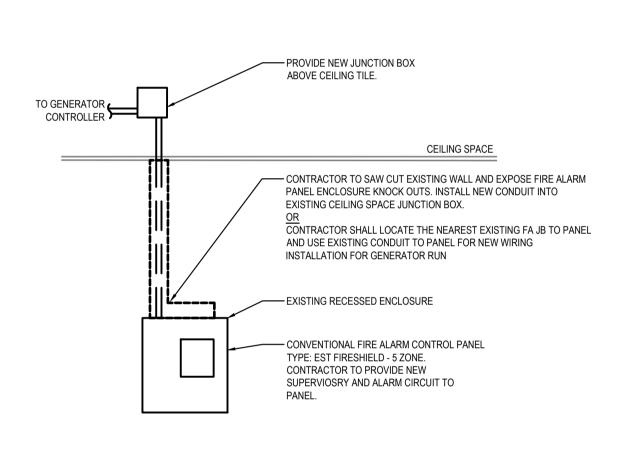

FIRE ALARM ZONE ANNUNCIATION MAIN FLOOR OFFICE AREA PULL STATIONS — ALARM
 MAIN FLOOR OFFICE AREA SMOKE DETECTORS — ALARM
 MAIN FLOOR OFFICE AREA HEAT DETECTORS — ALARM
 GENERATOR RUNNING AND GENERATOR TROUBLE — SUPERVISORY

FINISHED FLOOR FIRE ALARM PANEL ELEVATION

EXISTING PANEL B										
Voltage: - 120/208V, 3P, 4W Location: - ELECTRICAL CLOSET Mounting: - SURFACE Bus Size: - 200A Fault Current Rating: - 10kA NOTES: - SIEMENS P2										
ССТ	DESCRIPTION	Bkr	Ph	Α	В	С	Ph	Bkr	DESCRIPTION	СС
1	RECEPTACLE - EXTERIOR	15	1	Х			1	15	FIRE A LA RM	2
3 5	HEAT - OFFICE	20	1		X	Х	1	50	MILLER WELDING MA CHINE	4
7 9	HEA T- OFFICE	20	1	Х	Х		1	20	HOT WATER TANK	8
11	RECEPTA CLE - COUNTERTOP	15	1			Х	1	15	UNKNOWN	12
13	RECEPTA CLE - COUNTERTOP	15	1	X						14
15	HEAT - RADIANT	15	1		X		1	30	HANGER ROLL UP DOOR	16
17	SECURITY SYSTEM	15	1			Х				18
19	UNKNOWN	15	1	X			1	30	BATTERY CHARGER	20
21	UNKNOWN	15	1		X			30	BATTERT GIARGER	22
23	UNKNOWN	15	1			X	1	15	UNKNOWN	24
25	UNKNOWN	15	1	X			1	15	UNKNOWN	20
27	UNKNOWN	15	1		Х		1	15	UNKNOWN	28
29	UNKNOWN	15	1			Х	1	15	UNKNOWN	30
31	UNKNOWN	15	1	X			1	15	UNKNOWN	32
33	UNKNOWN	15	1		Х		1	15	UNKNOWN	34
35	BLANK					Х			BLANK	36
37	GEN. ENCLOSURE LIGHT + REC	15	1	X					BLANK	38
39	GENERATOR BLOCK HEATER	15	1		Х				BLANK	40
41	GENERATOR BATTERY CHARGER	15	1			Х			BLANK	42

PANEL NOTE: 1. NEW LOADS TO BE FED FROM NEW BREAKERS. ALLOW FOR NEW BREAKERS SIZED AS SHOWN. NEW BREAKERS TO MATCH EXISTING FAULT CURRENT RATINGS. EXISTING PANEL MODEL SIEMENS P2 SERIES.

Public Works and Government Services Services gouvernmentaux REAL PROPERTY SERVICES Pacific Region SERVICES IMMOBILIERS Région de Pacifique

0	ISSUED FOR TENDER	2020/10/07			
#	Description	Y/M/D			
Client / client					

ROYAL CANADIAN MOUNTED POLICE

Project title / Titre du projet

PRINCE RUPERT HANGAR GENERATOR UPGRADE

	Consultant Approval Box Only
	Designed by / Concept par MRO
	Drawn by / Dessine par DT/MRO
	PWGSC, Project Manager / Administrateur de Projets GRC MASOOD DEZFOOLI
	Regional Manager, Architectural and Engineering Services / Gestionnaire regionale, Services d'architectural et de genie,GRC PREETIPAL PAUL
	Drawing title / Titre du dessi

ELECTRICAL DETAILS AND SCHEDULE

Project No. / No. du projet.	Sheet / Feuille	Revision no. / La Revision
R.105637.001	E-003	no.


GENERAL NOTES

1. CONTRACTOR TO VERIFY ALL DIMENSIONS FOR PROJECT PRIOR TO COMMENCEMENT OF WORK AND NOTIFY DEPARTMENTAL REPRESENTATIVE OF ANY DISCREPANCIES.


- 2. STRUCTURAL DRAWINGS SHOW THE COMPLETED PROJECT. THEY DO NOT SHOW COMPONENTS WHICH MAY BE NECESSARY FOR CONSTRUCTION SAFETY. CONTRACTOR IS RESPONSIBLE FOR SAFETY ON AND ABOUT THE JOB SITE DURING CONSTRUCTION
- 3. CONTRACTOR TO ENSURE THAT ALL WORK IS CARRIED OUT BY THE RULES AND CUSTOMS OF THE BEST TRADE PRACTICES AND THEIR SPECIFICATIONS BY SKILLED TRADES PEOPLE KNOWLEDGEABLE OF THE TYPE OF CONSTRUCTION. THEY ARE TO BE PROPERLY EQUIPPED AND SUPERVISED.
- 4. NOTIFY DEPARTMENTAL REPRESENTATIVE 24 HOURS IN ADVANCE FOR CONSTRUCTION REVIEW OF THE STRUCTURAL PORTION OF THE PROJECT AS SHOWN ON THE STRUCTURAL DRAWINGS.
- 5. SEE ELECTRICAL DRAWINGS FOR SLEEVES, INSERTS, ETC. TO BE ENCASED IN CONCRETE.
- 6 STRUCTURAL DESIGN DATA
 - a. ENGINEER OF RECORD: CHELSEA PATON, P.ENG.
- b. DESIGN CODE NATIONAL BUILDING CODE OF CANADA 2015 & BRITISH COLUMBIA BUILDING CODE 2018 PART 4.

FOUNDATION NOTES

- 1. GEOTECHNICAL ENGINEER TO BE RETAINED BY THE CONTRACTOR TO PROVIDE DESIGN AND FIELD REVIEW SERVICES.
- 2. GEOTECHNICAL ENGINEER TO PROVIDE LETTERS OF ASSURANCE SCHEDULES B AND C-B.
- 3. FOOTINGS HAVE BEEN DESIGNED FOR THE FOLLOWING UNFACTORED BEARING PRESSURES OF 75 kN/m2. FOOTINGS TO BEAR ON SUBGRADE APPROVED BY A GEOTECHNICAL ENGINEER.
- 4. BEARING SURFACES MUST BE APPROVED BY THE GEOTECHNICAL ENGINEER PRIOR TO CONCRETE BEING PLACED. DEPARTMENTAL REPRESENTATIVE IS NOT RESPONSIBLE FOR CONFIRMING BEARING CAPACITIES OF SOILS.
- 5. REFER TO GEOTECHNICAL ENGINEER FOR OTHER SPECIFIC DESIGN REQUIREMENTS FOR FOOTINGS, SOIL SLOPES, FROST PROTECTION, MINIMUM COVER, ETC.
- 6. PROTECT BEARING SURFACES FROM FREEZING BEFORE AND AFTER FOUNDATION PAD IS POURED.
- 7. SUB-BASE DESIGN OF SOIL UNDER THE FOUNDATION PAD TO BE DESIGNED BY A GEOTECHNICAL ENGINEER.

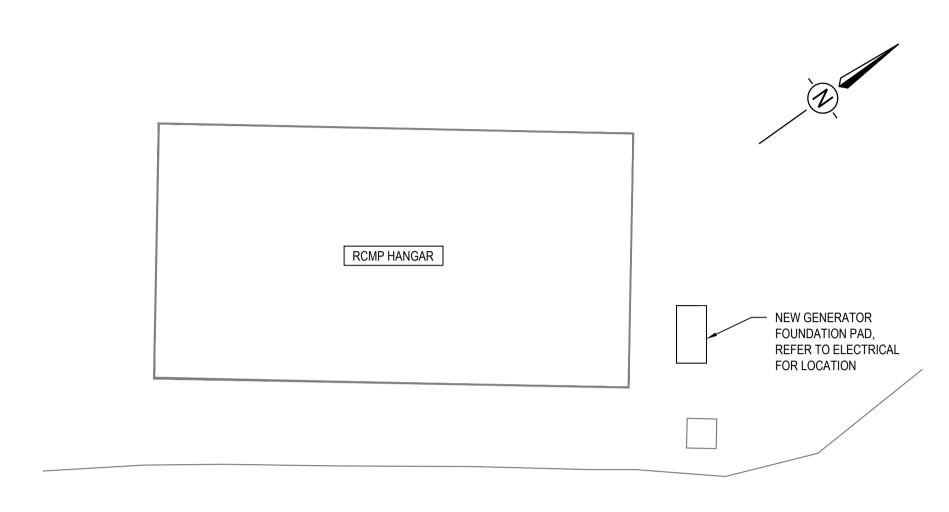

SITE PLAN

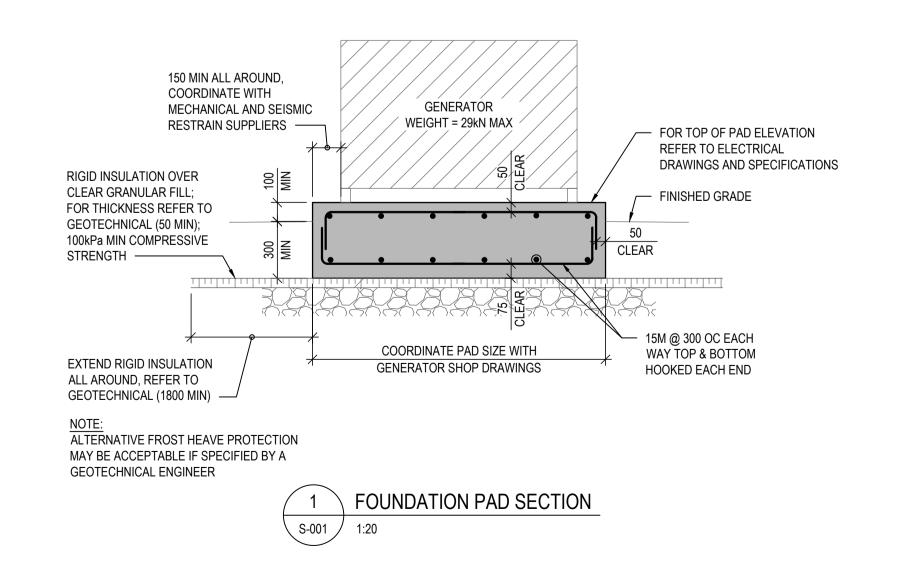



REAL PROPERTY SERVICES
Pacific Region
SERVICES IMMOBILIERS
Région de Pacifique

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WSP PROJECT NO. 191-00960-01

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GM

PWGSC, Project Manager / Administrateur de Projets GRC
MASOOD DEZFOOLI

Regional Manager, Architectural and Engineering Services /
Gestionnaire regionale, Services d'architectural et de genie,GRC
PREETIPAL PAUL

STRUCTURAL GENERAL NOTES, SITE PLAN AND TYPICAL GENERATOR PAD DETAIL

Project No. / No. du projet.

Sheet / Feuille

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