

	ANNOT	ATIC	NS
DENOTE	DESCRIPTION	DENOTE	DESCRIPTION
BND	BOND WIRE (AS PER SPECIFICATIONS)	F/A	FIRE ALARM
GND	GROUND WIRE (#6)	GFI	GROUND FAULT INTERRUPTER
cw	COMPLETE WITH	SPD	SURGE PROTECTION DEVICE
DISC	DISCONNECT	TR	TAMPER RESISTANT
RR	REMOVE	WP	WEATHERPROOF
EX	EXISTING TO REMAIN	WT	WATER TIGHT
ER	EXISTING TO BE RELOCATED	AFF	ABOVE FINISHED FLOOR
RE	REPLACE EXISTING WITH NEW DEVICE IN SAME LOCATION	AFG	ABOVE FINISHED GRADE
RL	EXISTING DEVICE IN RELOCATED LOCATION		
SYMBOL	DESCRIPTION		
XXXX	MECHANICAL EQUIPMENT TAG		
~ 0	REFERENCE NOTE (1 DENOTES SEE NOTE 1)	
1	ELECTRICAL CONDUCTOR AND CONDUIT TAG		
A REVISION IDENTIFICATION TAG			
A	PANEL IDENTIFICATION TAG		
	NEW EQUIPMENT		
	EXISTING EQUIPMENT TO REMAIN		
	■ EXISTING EQUIPMENT TO BE REMOVED		

SINGLE LINE DIAGRAM SYMBOLS		
SYMBOL	DESCRIPTION	
	AUTOMATIC TRANSFER SWITCH WITHOUT MANUAL BYPASS	
6	GENERATOR	
- ← ←	MOLDED CASE CIRCUIT BREAKER. "L" WHERE SHOWN, DENOTES DEVICE c/w CURRENT LIMITERS	
₊ ∕~	BREAKER DISCONNECT SWITCH	
W	METER	
	BUSBAR	
\rightarrow	H.V. POT HEAD	
•	CONNECTION POINT	
SPD	SURGE PROTECTION DEVICE	
	PANELBOARD	
2	PANELBOARD AND BREAKER	

	POWER SYMBOLS
SYMBOL	DESCRIPTION
WP GFI HK TL SW O/G UIC	DUPLEX U-GROUND 15A, 125 VOLT, 2 POLE, 3 WIRE GROUNDING RECEPTACLE ""WHERE SHOWN, DENOTES CONNECTION TO EMERGENCY POWER. "WP" WHERE SHOWN, DENOTES DEVICE MOUNTED IN WEATHERPROOF F.S. BOX WITH WEATHERPROOF COVER "GFI" WHERE SHOWN, DENOTES DEVICE DEDICATED TO "HOUSEKEEPING" SERVICE, PROVIDE ENGRAVED NAMEPLATE, "IL" WHERE SHOWN, DENOTES SWITCHED RECEPTACLE "SW" WHERE SHOWN, DENOTES SWITCHED RECEPTACLE "IL" WHERE SHOWN, DENOTES SWISTLOCK "IL" WHERE SHOWN, DENOTES TWISTLOCK "IL" WHERE SHOWN, DENOTES TWISTLOCK
Φ	DUPLEX U-GROUND 15A, 125V, 2P 3 WIRE GROUNDING RECEPTACLE PROTECTED BY G.F.C.I. BREAKER AT PANELBOARD, MOUNTED APPROXIMATELY 3'6" (1050 mm) ABOVE FINISHED FLOOR.
•	SPECIAL PURPOSE RECEPTACLE AS DENOTED
	HARDWIRED EQUIPMENT CONNECTION
PP IP	SINGLE SURFACE MOUNTED / FLUSH MOUNTED PANELBOARD, "PP" DENOTES POWER PANEL, "LP" DENOTES LIGHTING AND POWER PANEL,
 	SINGLE SURFACE MOUNTED / FLUSH MOUNTED LOW VOLTAGE "LV" DENOTES LOW VOLTAGE PANEL
ı	JUNCTION BOX
ㅁ	DISCONNECT SWITCH UNLESS NOTED OTHERWISE
	ELECTRIC BASEBOARD HEATER
⊕	GROUND ROD

	LIGHTING SYMBOLS
SYMBOL	DESCRIPTION
A	STRIP SURFACE LUMINAIRE, LETTER "A" INDICATES LUMINAIRE TYPE AS PER LUMINAIRE SCHEDULE.
\$ # # 5	ONE, TWO, THREE LINE VOLTAGE TOGGLE SWITCH AND LOW VOLTAGE SWITCH MOUNTED 4'-0" (1.2m) ABOVE FINISHED FLOOR LEVEL UNLESS OTHERWISE NOTED.
E2. ⊕	EMERGENCY BATTERY PACK OW RECEPTACLE
\$	REMOTE DUAL HEAD EMERGENCY LIGHTS CONNECTED TO EMERGENCY BATTERY PACK WALL MOUNTED. REFER TO SPECIFICATIONS FOR DETAILS. "E2" DENOTES REMOTE BATTERY HEADS FED FROM BATTERY UNIT "E2".

SITE SYMBOL	
SYMBOL	DESCRIPTION
●BCH	POWER POLE
⊱—сом-он—-{	OVERHEAD COMMUNICATIONS CABLE
⊱—cow-u/g—-{	UNDERGROUND COMMUNICATIONS CABLE
}— PWR-OH —-}	OVERHEAD SERVICE CONDUCTORS
} PWR-U/G}	OVERHEAD SERVICE CONDUCTORS
[Fe]	PULL BOX (FIBRE GLASS, PVC, ETC.)
₹	OVERHEAD UTILITY SERVICE MAST

LEGAL DESCRIPTION

LOT 1, DISTRICT LOT 7, RANGE 5, COAST DISTRICT, PLAN 8965

CODE LOAD CALCULATION:

MAIN FLOOR OFFICE (176 sq. m. @ 50W/sq. m.) = 8,800 W MAIN FLR CELLS/STORAGE/GARAGE (163 sq. m. @25W/sq. m.) = 1,630 W MECHANICAL LOADS

TOTAL = 29,630 W MIN. MAIN BREAKER @ 120/240V, $1\emptyset = \frac{29,630}{240} = 124A$

FULL GENERATOR STANDBY ALLOWING 30% HEADROOM 1.3 x 29,630W = 38,519W => 40kW STANDBY GENERATOR

DRAWING LIST		
DRAWING NUMBER	DRAWING TITLE	
E-001	ELECTRICAL LEGEND, SITE KEYPLAN AND GENERAL NOTES	
E-002	ELECTRICAL SITE PLAN AND SINGLE LINE DIAGRAM	
E-003	ELECTRICAL PARTIAL PLAN AND DETAILS	
E-004	ELECTRICAL DETAILS	
S-001	STRUCTURAL GENERAL NOTES, SITE PLAN, AND TYPICAL GENERATOR PAD DETAIL	

Public Works and Travaux publics et
Government Services Services gouvernementaux
Canada Canada

REAL PROPERTY SERVICES Pacific Region SERVICES IMMOBILIERS Région de Pacifique



0	ISSUED FOR TENDER	2020/10/07
#	Description	Y/M/D
	·	

ROYAL CANADIAN MOUNTED POLICE

Project title / Titre du projet

PORT SIMPSON DETACHMENT GENERATOR UPGRADE

Consultant Approval Box Only Designed by / Concept par

Drawn by / Dessine par MRO

PWGSC, Project Manager / Administrateur de Projets GRC MASOOD DEZFOOLI


Regional Manager, Architectural and Engineering Services / Gestionnaire regionale, Services d'architectural et de genie,GRC PREETIPAL PAUL


ELECTRICAL LEGEND, SITE KEYPLAN AND GENERAL NOTES


Project No. / No. du projet. R.105627.001

Sheet / Feuille E-001

0 10 20 30 40 50 60 70 80 90 100mm

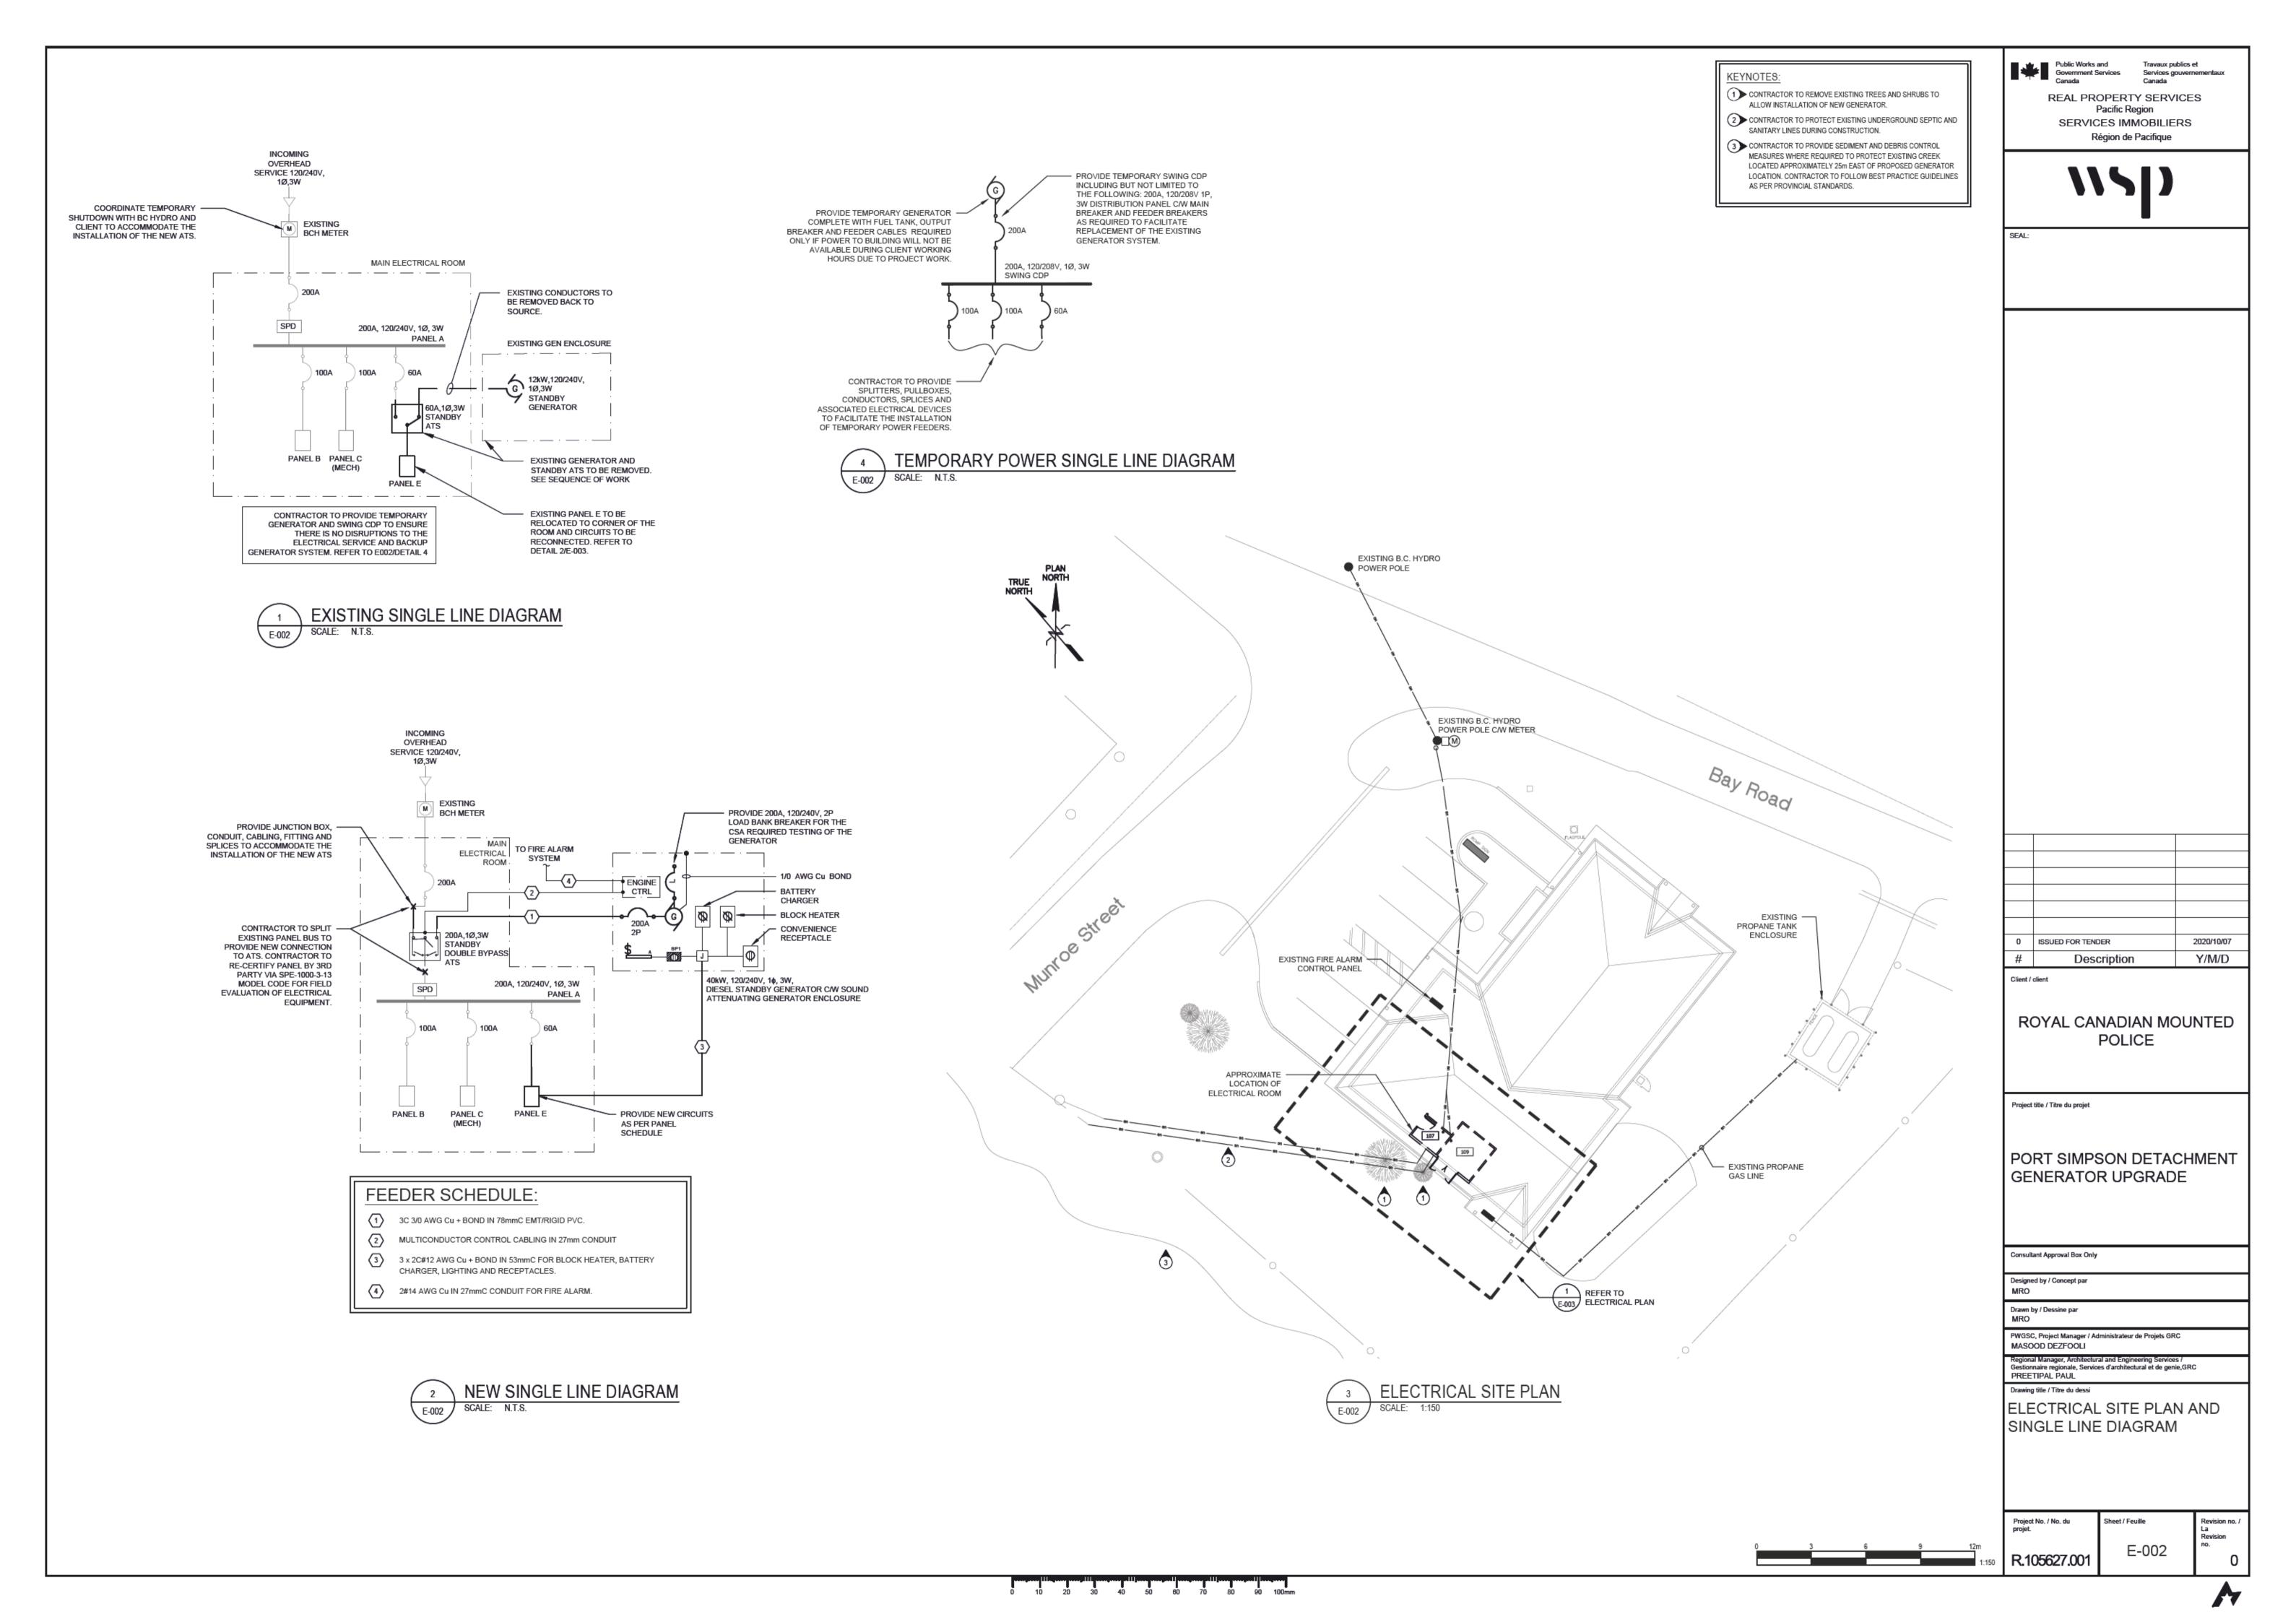


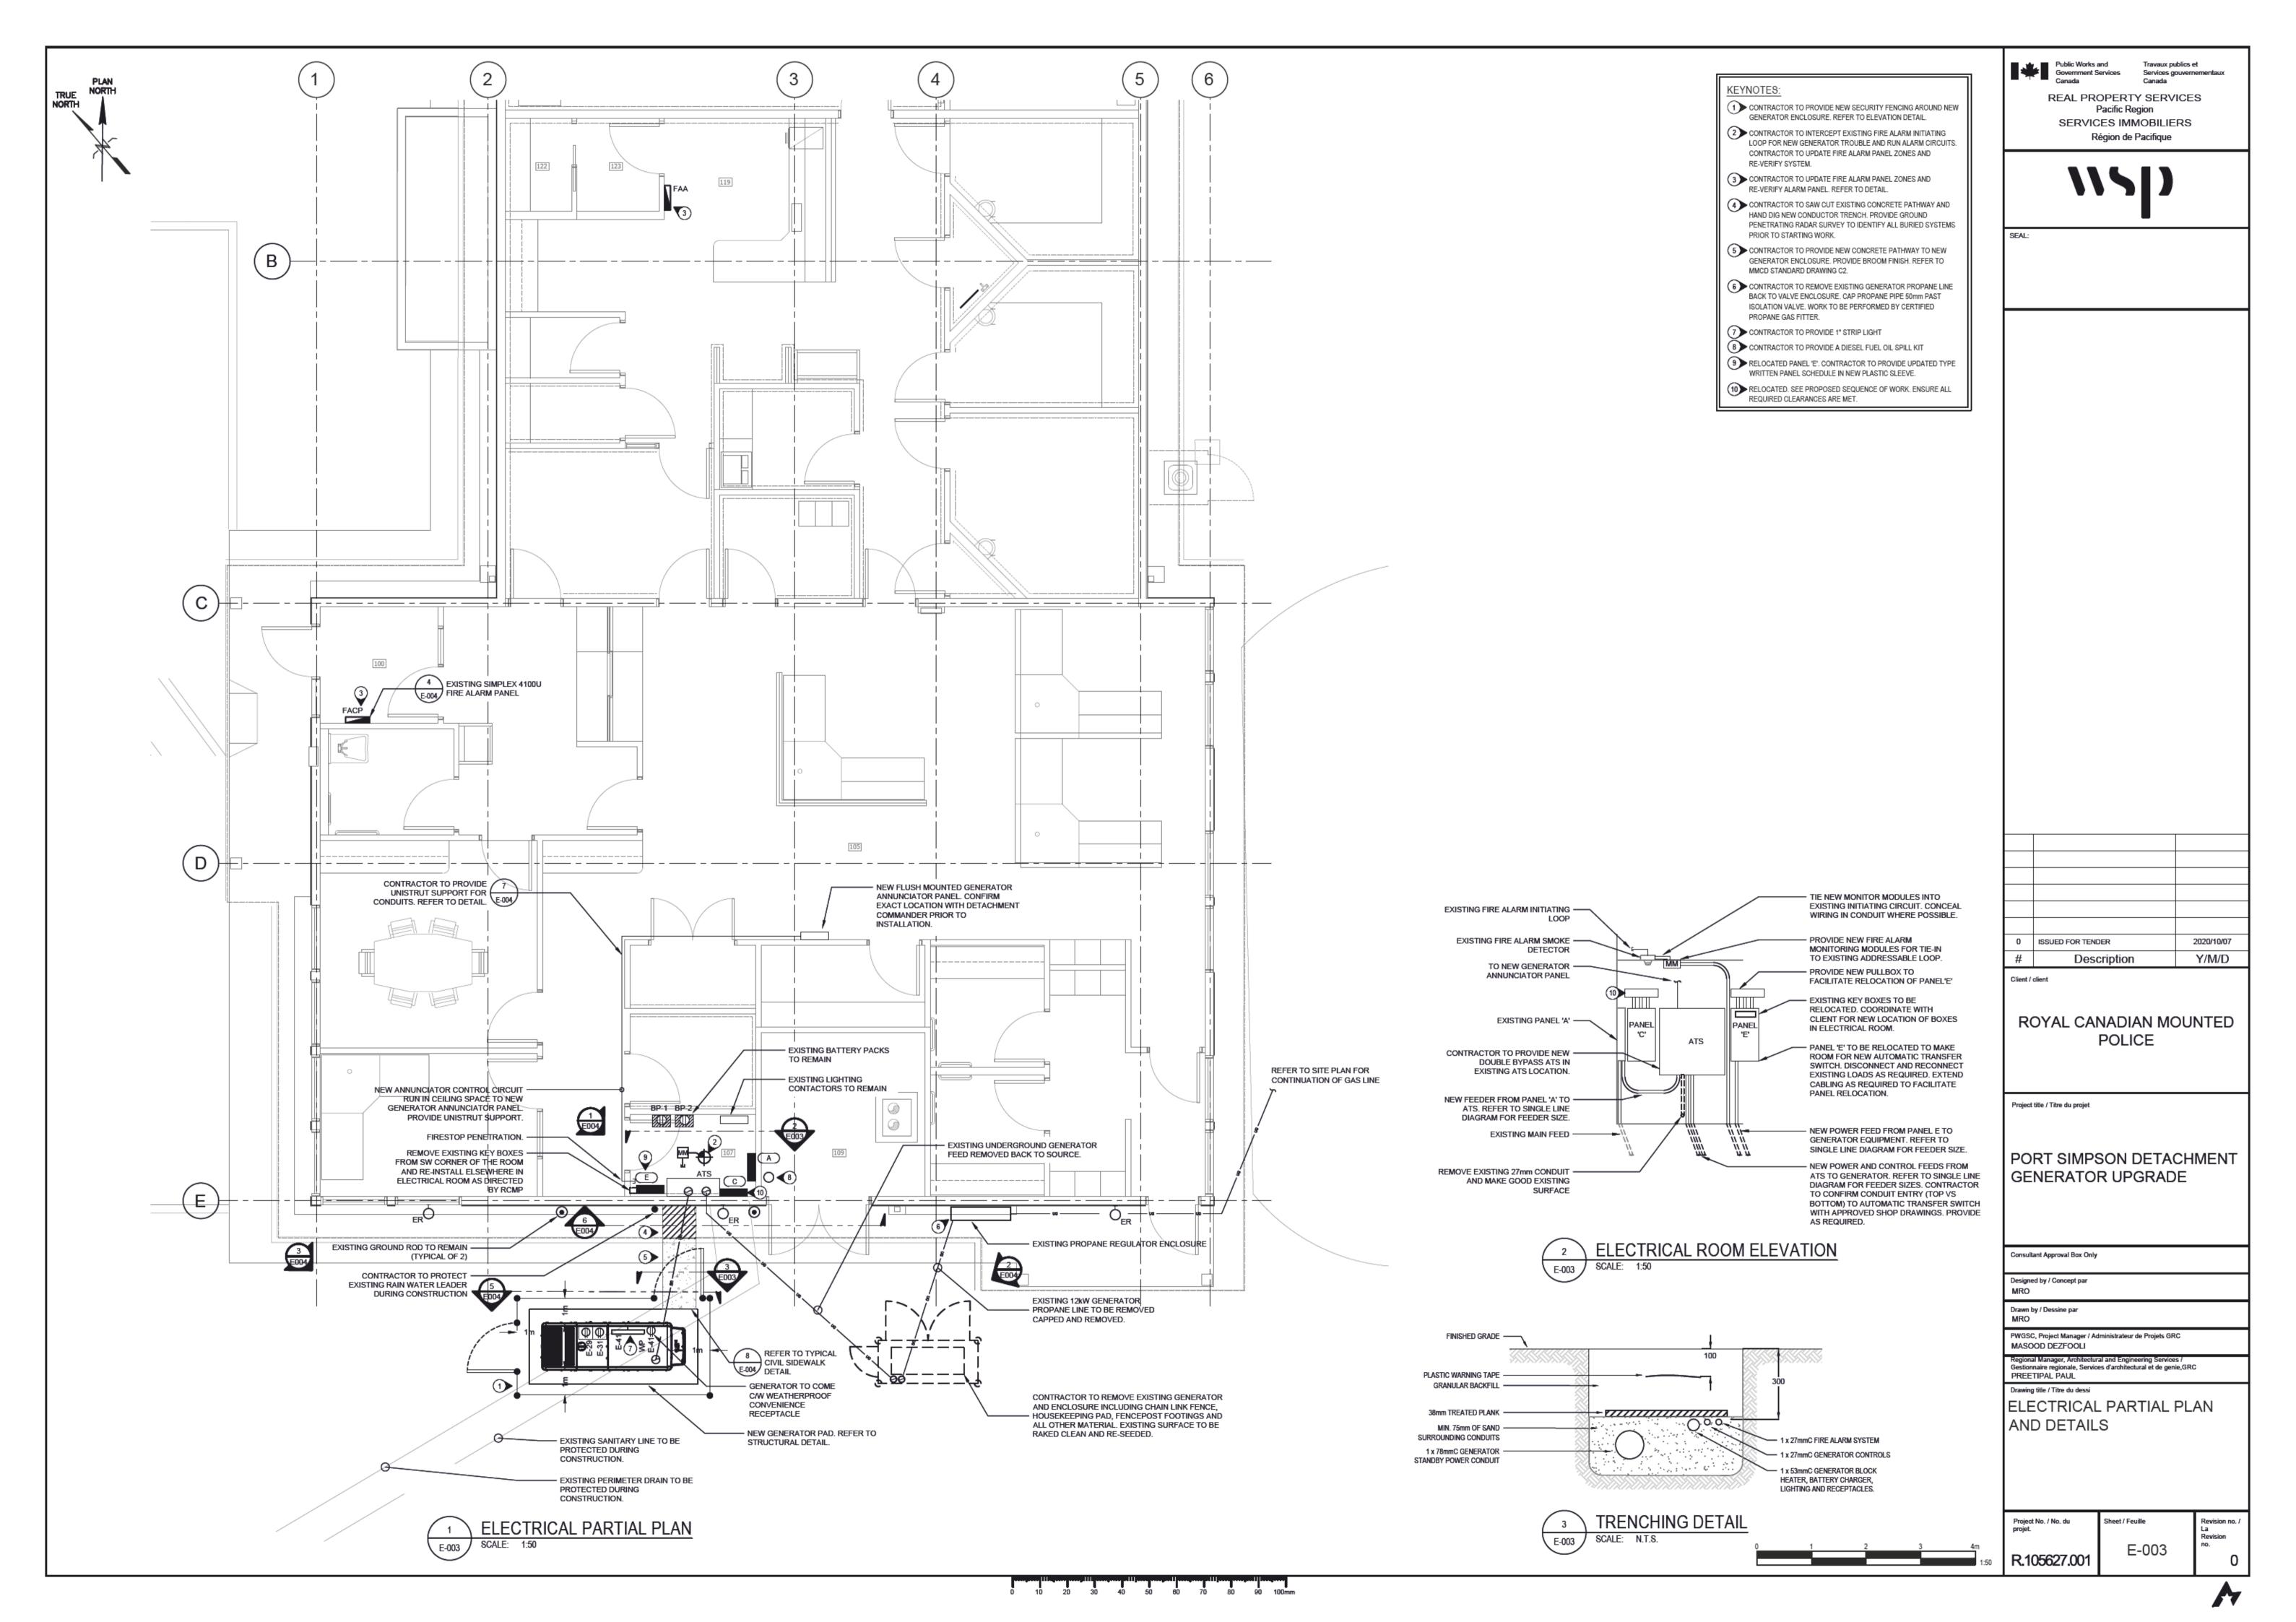

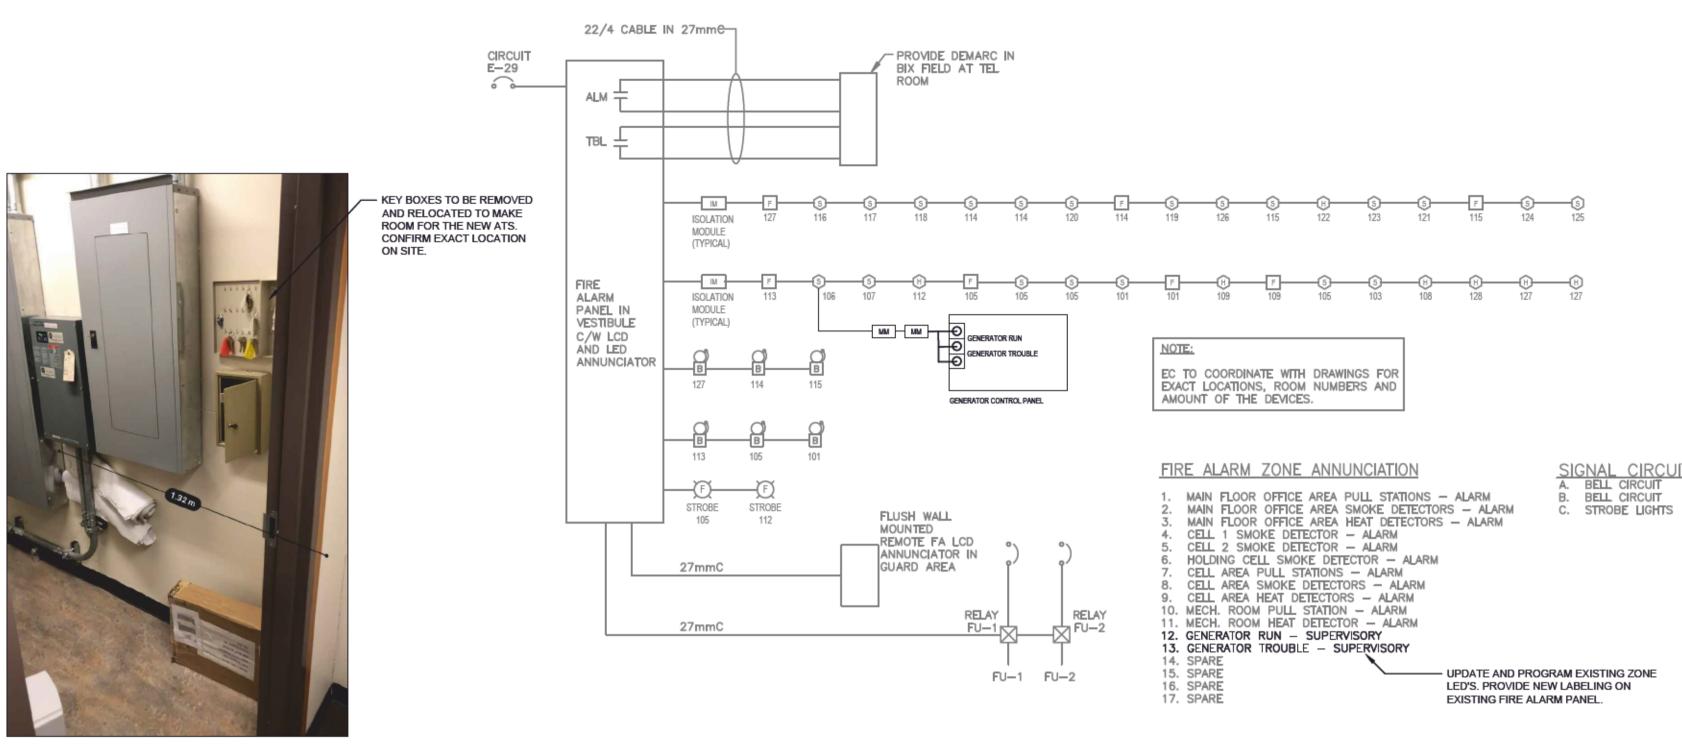

FIRE ALARM RISER DIAGRAM

SCALE: N.T.S.

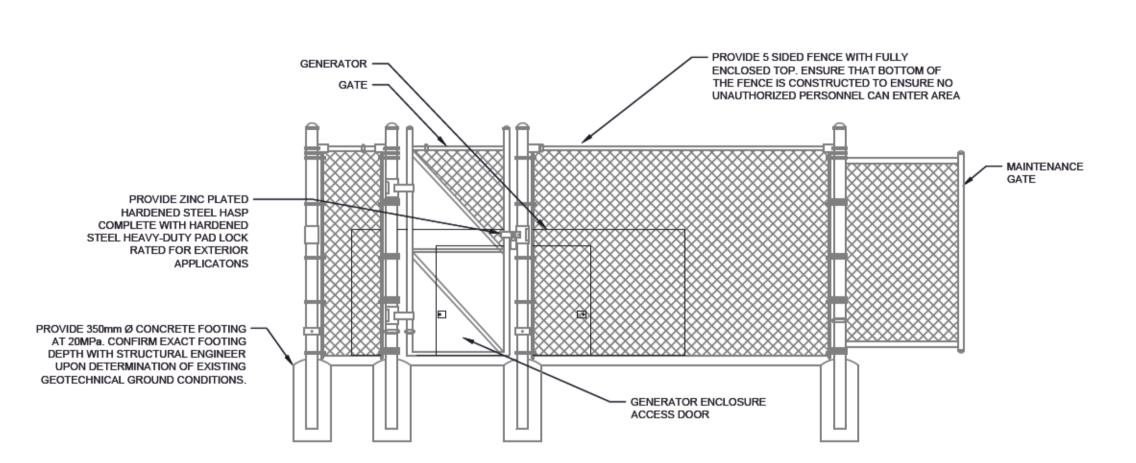

SECURITY FENCING ELEVATION DETAIL

SCALE: N.T.S.



EXTERIOR - EXISTING GENERATOR


ELECTRICAL ROOM - EXISTING CONDITIONS

SCALE: N.T.S.

E-004

EXTERIOR SITE CONDITIONS

SCALE: N.T.S.

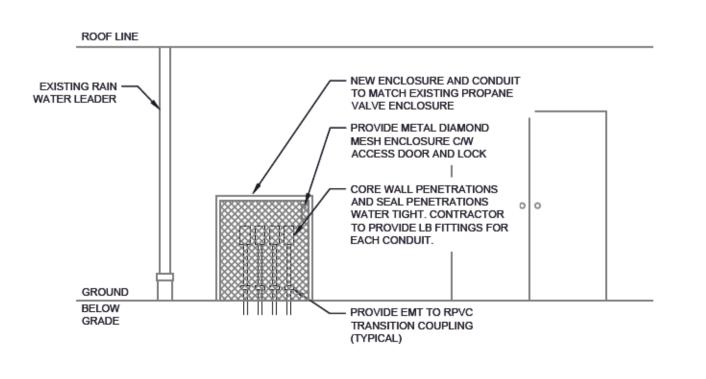

EXTERIOR ELEVATION


SCALE: N.T.S.

Voltage: - 120/240V, 3P, 3W Location: - MAIN ELECTRICAL ROOM Mounting: - SURFACE Bus Size: - 225A Fault Current Rating: - 10 KA Other: - COMBINATION PANEL 200A BREAKER Description Description 1 UPS REC - TEL 3 REC - TEL ROOM 20A X X BLANK 15A X 20A LIGHTING MAIN FLOOR 5 REC - TEL ROOM 15A X 20A LIGHTING MAIN FLOOR 20A X 20A LIGHTING MAIN FLOOR 7 UPS REC - LAN ROOM | 20A | X | 20A | REC - GUARD | 15A | X | 20A | REC - GUARD | 15A | X | BLANK 9 REC - LAN ROOM 11 REC - LAN ROOM 13 INTRUSION ALARM 15 DDC PANEL REC - STORAGE 19 DDC PANEL 21 REC - STORAGE REC - MECH ROOM PANIC ALARM DOOR SIGNAL GENSET CAR HEATER GENERATOR BATTERY CHARGER UPS REC - LAN ROOM REC - LAN ROOM X BLANK REC- LAN ROOM X X BLANK GENERATOR RECEPTACLE / LIGHT X 15A EMERGENCY LIGHTING EXIT SIGNS 41 BLANK


EXISTING PANEL E

PANEL NOTE:

NEW LOADS TO BE FED FROM NEW BREAKERS. ALLOW FOR NEW BREAKERS SIZED AS SHOWN. NEW BREAKERS
TO MATCH EXISTING FAULT CURRENT RATINGS. EXISTING PANEL IS EATON PRL-1a.

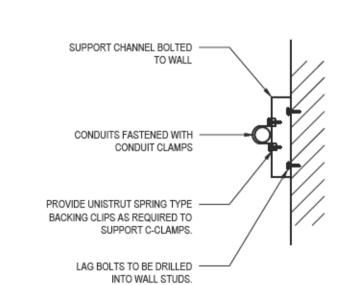



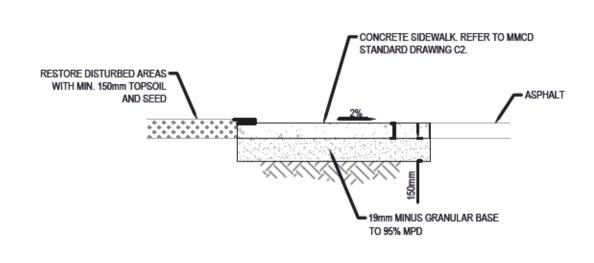



REAL PROPERTY SERVICES Pacific Region SERVICES IMMOBILIERS Région de Pacifique

Travaux publics et Services gouvernementaux

115)

AL:

Public Works and Government Services

0	ISSUED FOR TENDER	2020/10/07	
#	Description	Y/M/D	

Client / client

ROYAL CANADIAN MOUNTED POLICE

Project title / Titre du projet

PORT SIMPSON DETACHMENT GENERATOR UPGRADE

Consultant Approval Box Only

Designed by / Concept par
MRO

Drawn by / Dessine par
MRO

PWGSC, Project Manager / Administrateur de Projets GRC
MASOOD DEZFOOLI

Regional Manager, Architectural and Engineering Services /
Gestionnaire regionale, Services d'architectural et de genie, GRC
PREETIPAL PAUL

Drawing title / Titre du dessi

ELECTRICAL DETAILS

Project No. / No. du projet.

Sheet / Feuille Revision La Revision no.

GENERAL NOTES


- CONTRACTOR TO VERIFY ALL DIMENSIONS FOR PROJECT PRIOR TO COMMENCEMENT OF WORK AND NOTIFY DEPARTMENTAL REPRESENTATIVE OF ANY DISCREPANCIES.
- STRUCTURAL DRAWINGS SHOW THE COMPLETED PROJECT. THEY DO NOT SHOW COMPONENTS WHICH MAY BE NECESSARY FOR CONSTRUCTION SAFETY. CONTRACTOR IS RESPONSIBLE FOR SAFETY ON AND ABOUT THE JOB SITE DURING CONSTRUCTION
- CONTRACTOR TO ENSURE THAT ALL WORK IS CARRIED OUT BY THE RULES AND CUSTOMS OF THE BEST TRADE
 PRACTICES AND THEIR SPECIFICATIONS BY SKILLED TRADES PEOPLE KNOWLEDGEABLE OF THE TYPE OF CONSTRUCTION.
 THEY ARE TO BE PROPERLY EQUIPPED AND SUPERVISED.
- NOTIFY DEPARTMENTAL REPRESENTATIVE 24 HOURS IN ADVANCE FOR CONSTRUCTION REVIEW OF THE STRUCTURAL PORTION OF THE PROJECT AS SHOWN ON THE STRUCTURAL DRAWINGS.
- 5. SEE ELECTRICAL DRAWINGS FOR SLEEVES, INSERTS, ETC. TO BE ENCASED IN CONCRETE.
- STRUCTURAL DESIGN DATA.
- a. ENGINEER OF RECORD: CHELSEA PATON, P.ENG.
 b. DESIGN CODE NATIONAL BUILDING CODE OF CANADA 2015 & BRITISH COLUMBIA BUILDING CODE 2018 PART 4.


FOUNDATION NOTES

- 1. GEOTECHNICAL ENGINEER TO BE RETAINED BY THE CONTRACTOR TO PROVIDE DESIGN AND FIELD REVIEW SERVICES.
- 2. GEOTECHNICAL ENGINEER TO PROVIDE LETTERS OF ASSURANCE SCHEDULES B AND C-B.
- FOOTINGS HAVE BEEN DESIGNED FOR THE FOLLOWING UNFACTORED BEARING PRESSURES OF 75 kN/m2. FOOTINGS TO BEAR ON SUBGRADE APPROVED BY A GEOTECHNICAL ENGINEER.
- 4. BEARING SURFACES MUST BE APPROVED BY THE GEOTECHNICAL ENGINEER PRIOR TO CONCRETE BEING PLACED.

DEPARTMENTAL REPRESENTATIVE IS NOT RESPONSIBLE FOR CONFIRMING BEARING CAPACITIES OF SOILS.

- REFER TO GEOTECHNICAL ENGINEER FOR OTHER SPECIFIC DESIGN REQUIREMENTS FOR FOOTINGS, SOIL SLOPES, FROST PROTECTION, MINIMUM COVER, ETC.
- 6. PROTECT BEARING SURFACES FROM FREEZING BEFORE AND AFTER FOUNDATION PAD IS POURED.
- SUB-BASE DESIGN OF SOIL UNDER THE FOUNDATION PAD TO BE DESIGNED BY A GEOTECHNICAL ENGINEER.

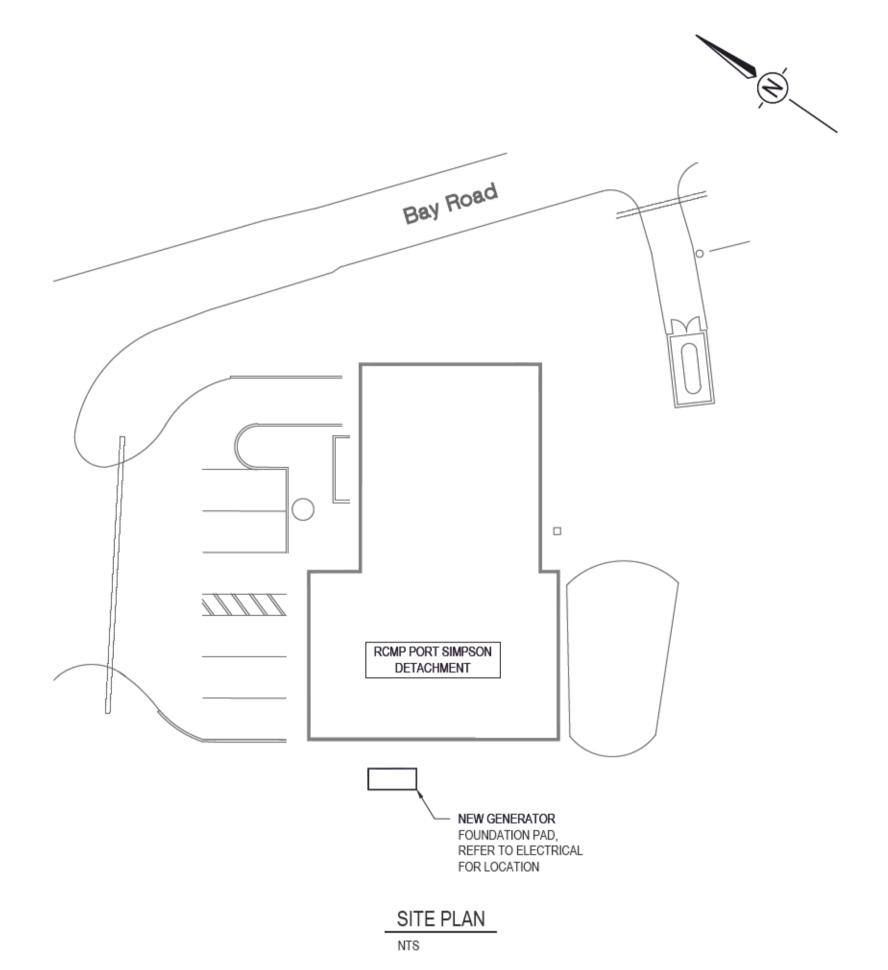

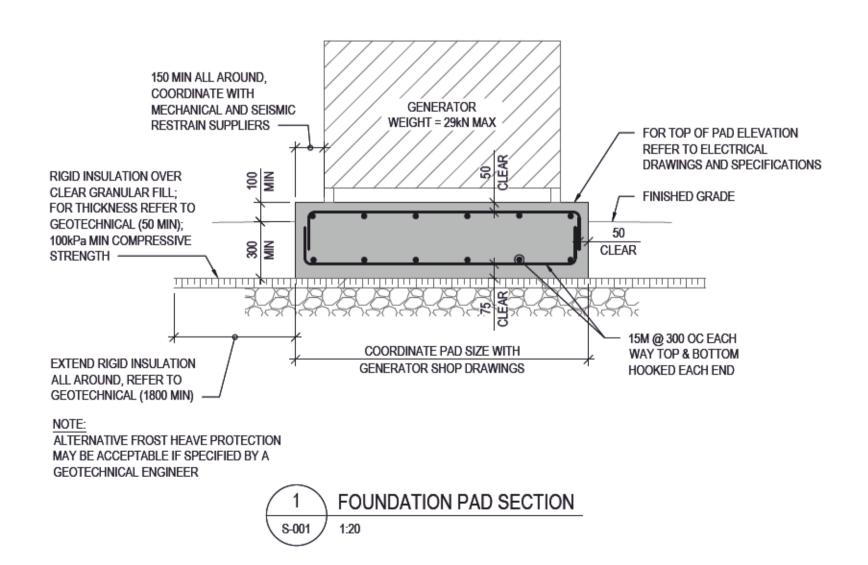

Public Works and Government Services Canada

Travaux publics et ces Services gouvernementaux Canada

REAL PROPERTY SERVICES
Pacific Region
SERVICES IMMOBILIERS
Région de Pacifique



WSP PROJECT NO. 191-00960-02

D ISSUED FOR TENDER 2020/10/07

Description Y/M/D

ROYAL CANADIAN MOUNTED POLICE

Project title / Titre du projet

Client / client

PORT SIMPSON DETACHMENT GENERATOR UPGRADE

Consultant Approval Box Only

Designed by / Concept par CP Drawn by / Dessine par GM

PWGSC, Project Manager / Administrateur de Projets GRC

MASOOD DEZFOOLI

Regional Manager, Architectural and Englineering Services / Gestionnaire regionale, Services d'architectural et de genie,GRC PREETIPAL PAUL

Drawing title / Titre du dessi

STRUCTURAL GENERAL NOTES, SITE PLAN AND TYPICAL GENERATOR PAD DETAIL

Project No. / No. du projet.

Sheet / Feuille Rev La Rev no.

0 10 20 30 40 50 80 70 80 90 100mm