

Public Works Government Services Canada

Architectural and Engineering Services

Ontario Region

Travaux publics Services gouvernementaux Canada

Services d'architecture et de génie

Région de l'Ontario

Kingston Ontario

Public Works and Government Services Canada 294 King St. East Kingston ON K7L 3B2

Dry Cell Relocation – Structured Intervention Unit Millhaven Institution

R.106776.001

Canada

LIST OF DRAWINGS

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ARCHITECTURE 49



C-B1 DATE PLOTTED: PLOT SCALE:

* REFER TO MECHANICAL AND ELECTRICAL FOR ADDITIONAL

INFORMATION ON THESE ITEMS

NEW SUPPLY AND RETURN DUCTS*

CAD FILE:

1 SITE PLAN

drawing no. dessine no.

daté du projet

project no. no. du projet


NOTE: PROJECT IS LIMITED TO THE RECONFIGURATION OF EXISTING OFFICES TO SUIT NEW RECONFIGURATION OF THE RELOCATED DRY CELL AND SHOWERS. THIS INCLUDES THE RECONFIGURATION OF SERVICES AS REQUIRED TO SUIT THE NEW CONFIGURATION. NO OTHER


CHANGES TO THE BUILDING ARE INCLUDED IN THIS SCOPE OF WORK.


A-100

2021-02-19

R.106776.001

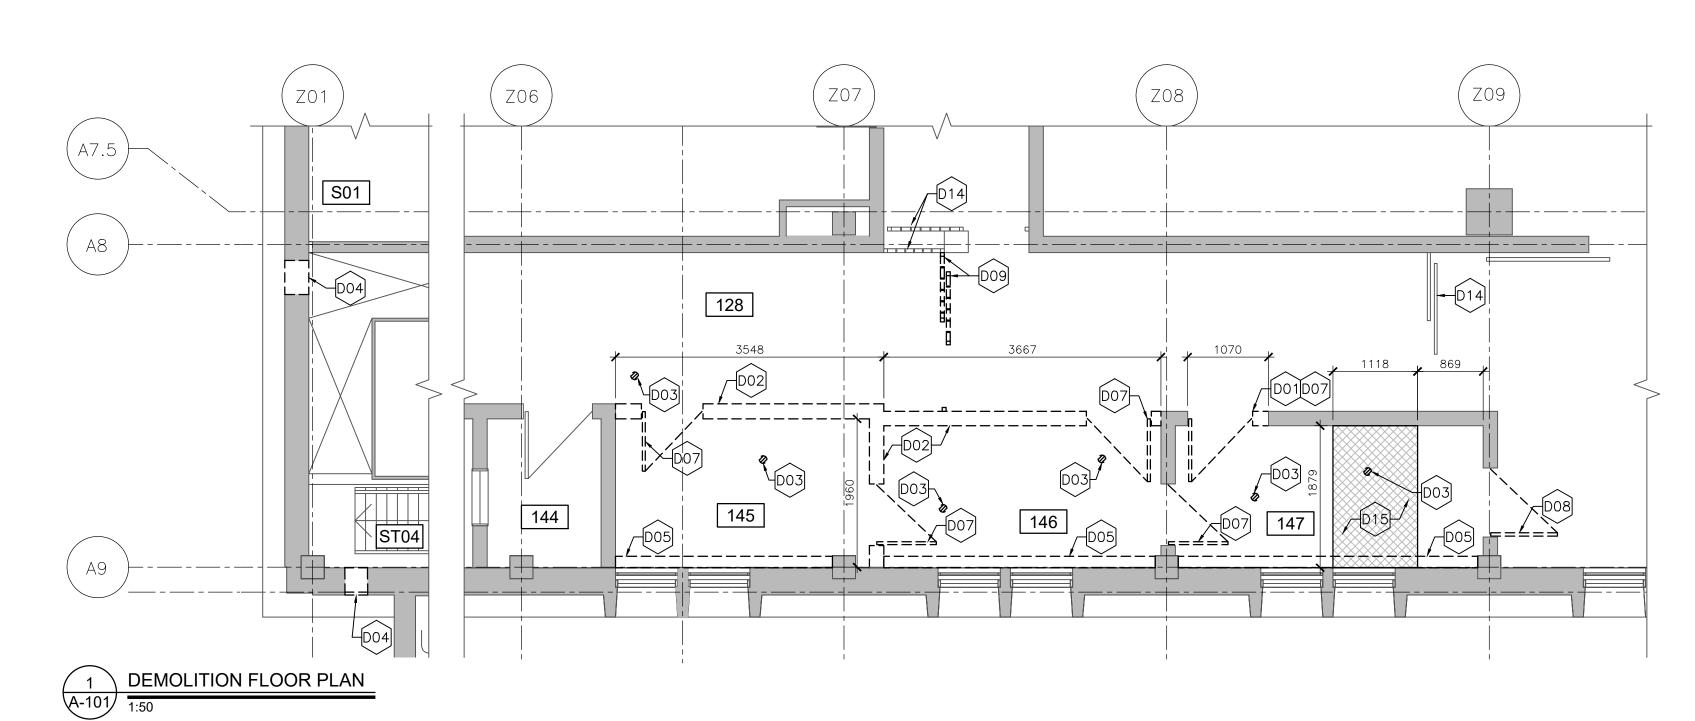

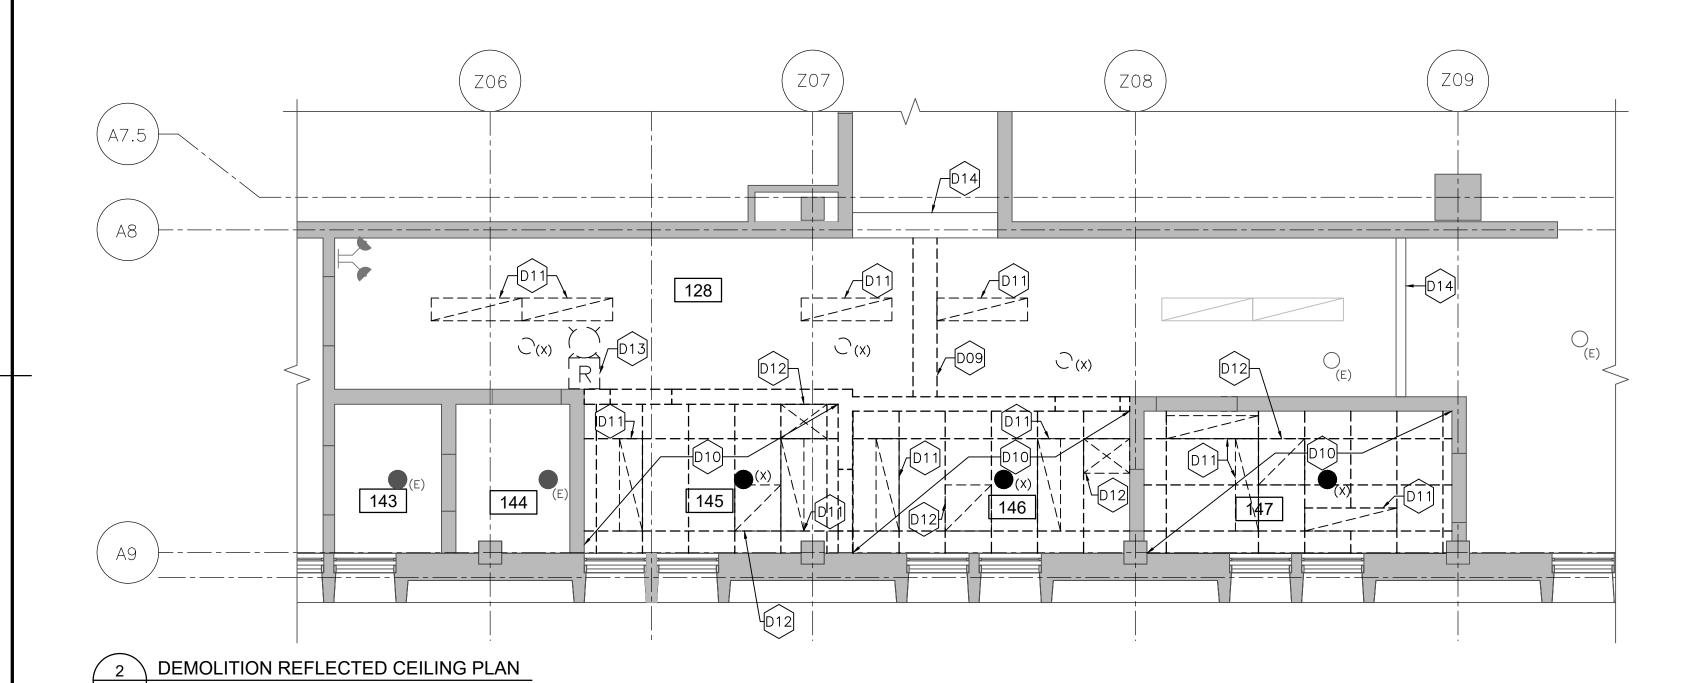

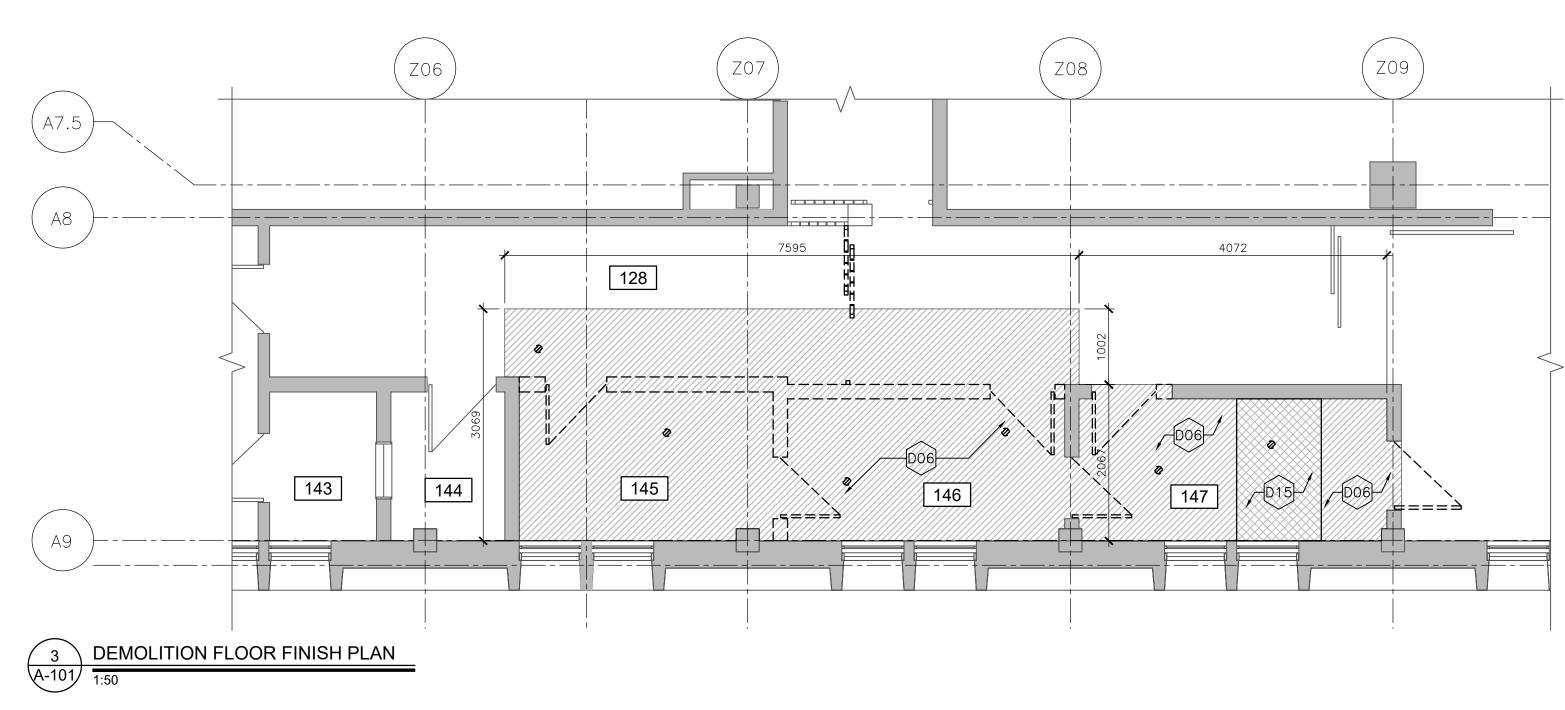

GENERAL DEMOLITION NOTES:

- REMOVE ALL ELECTRICAL AND DATA OUTLETS. REFER TO ELECTRICAL FOR
- ADDITIONAL INFORMATION.

 REMOVE ALL EXISTING VENTILATION GRILLS TO BE REPLACED WITH NEW SECURITY GRILLS. REFER TO MECHANICAL FOR ADDITIONAL INFORMATION.
- REMOVE ALL EXISTING DOORS AND GATES MARKED FOR DEMOLITION AND RETURN TO DEPARTMENTAL REPRESENTATIVE.
- DO NOT TO SCALE DRAWINGS.
 MECHANICAL AND ELECTRICAL WORK MAY BE REQUIRED IN AREAS LOCATED OUTSIDE OF THE SCOPE OF WORK. SCHEDULE ADDITIONAL WORK WITH DEPARTMENTAL REPRESENTATIVE AND COORDINATE INSTALLATION OF
- CONSTRUCTION HOARDING AT EACH LOCATION WHERE WORK IS PROCEEDING.

 THOROUGHLY INSPECT ALL AREAS TO REMAIN. PATCH AND REPAIR ANY
- VISIBLE DAMAGE. NEW FINISH TO MATCH EXISTING ADJACENT SURFACE.

 PROTECT ALL EXISTING MECHANICAL AND ELECTRICAL EQUIPMENT TO REMAIN.
- SITE CONFIRM ALL EXISTING CONDITIONS AND VERIFY ALL DIMENSIONS BEFORE START OF WORK. CONTRACTOR IS TO CONTACT DEPARTMENTAL REPRESENTATIVE IMMEDIATELY IN THE EVENT OF ANY CONFLICT.
- REFER TO STRUCTURAL, MECHANICAL, ELECTRICAL & CIVIL DRAWINGS FOR EXTENT OF REMOVALS AND UPGRADES.
 ALL SLABS TO BE SCANNED PRIOR TO SAW CUTTING AND CORING.
- PATCH AND REPAIR ALL EXISTING WALLS, CONCRETE SLABS AND CURBS AFTER DEMOLITION. NEW FINISH COLOURS AND MATERIALS TO MATCH EXISTING ADJACENT SURFACES. REFER TO SPECIFICATIONS AND STRUCTURAL DRAWINGS FOR ADDITIONAL INFORMATION.
- REFER TO STRUCTURAL, MECHANICAL, ELECTRICAL AND CIVIL DRAWINGS FOR ADDITIONAL WORK NOT INDICATED ON THIS DRAWING. CONTRACTOR TO COORDINATE SPECIFICATIONS AND DRAWINGS FOR COMPLETE SCOPE OF
- ADDITIONAL WORK NOT INDICATED ON THIS DRAWING MAY BE REQUIRED.
 COORDINATE ALL DEMOLITION AND NEW WORK WITH STRUCTURAL,
 MECHANICAL, ELECTRICAL AND CIVIL DRAWINGS. REFER TO MECHANICAL AND
 ELECTRICAL DRAWINGS FOR FULL SCOPE OF WORK. (REMOVALS AND
 REINSTATEMENT)

DEMOLITION NOTES:

- REMOVE EXISTING CONCRETE BLOCK TO PROVIDE NEW OPENING. SIZE OF OPENING TO SUIT NEW DOOR/GATE. REFER TO STRUCTURAL FOR LINTEL.
- REMOVE EXISTING CONCRETE BLOCK WALL INCLUDING ALL REINFORCEMENT. GRIND REBAR TO BE FLUSH WITH FINISHED FLOOR SLAB.
- CORE SLAB TO ALLOW INSTALLATION OF NEW MECHANICAL SERVICES.

 REFER TO MECHANICAL FOR ADDITIONAL INFORMATION. SEE STRUCTURAL FOR DETAILS ON SLAB PENETRATION WORK.
- REMOVE EXISTING EXTERIOR WALL ASSEMBLY INCLUDING CONCRETE BLOCK, INSULATION AND PRECAST CONCRETE PANEL, AS REQUIRED FOR NEW MECHANICAL AND STRUCTURAL WORK. REFER TO MECHANICAL AND

STRUCTURAL FOR REQUIRED SIZE OF NEW OPENING.

- REMOVE EXISTING HEATER/RADIATOR, REFER TO MECHANICAL FOR DETAILS OF SERVICE REMOVAL.
- REMOVE EXISTING TILE AND SHEET FLOORING. PATCH AND MAKE GOOD SLAB TO RECEIVE NEW FLOOR FINISH. REFER TO DRAWINGS 1/A02 AND 3/A102 FOR EXTENT OF REMOVAL
- 3/A102 FOR EXTENT OF REMOVAL.


 DO7 REMOVE EXISTING DOORS AND FRAMES.
- DOS REMOVE EXISTING DOOR, FRAME TO REMAIN.
- DO9 REMOVE EXISTING EXPANDED METAL GATE FOR NEW WORK TO BE COMPLETED. REFER TO ELECTRICAL FOR EXTENT OF CONTROL REMOVAL.
- D10 REMOVE EXISTING CEILING TILES AND T-BAR CEILING.,
- D11 REMOVE AND SALVAGE EXISTING LIGHTS, REFER TO ELECTRICAL.
- D12 REMOVE AND SALVAGE EXISTING SUPPLY AND RETURN DIFFUSERS, REFER TO MECHANICAL.
- D13 REMOVE AND SALVAGE WALL MOUNTED EMERGENCY LIGHTING.
- D14 EXISTING GATE TO REMAIN.
- P15 REMOVE CONCRETE TOPPING FOR INSTALLATION OF NEW ACCESSIBLE SHOWER.




Ontario Region


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Région de l'Ontario

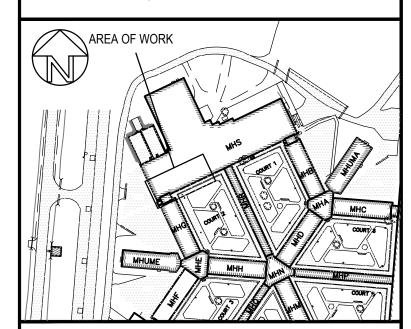

ARCHITECTURE 49



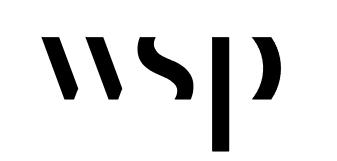

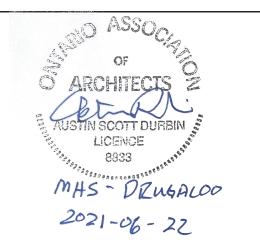1 ISSUED FOR TENDER 2021—06—22 revision description date

Verify all dimensions and conditions on site and immediately notify the Departmental Representative of all discrepancies.



Do not scale drawings.

A Detail No.
No. du détail
B drawing no. — where detail required dessin no. — où détail exigé
C drawing no. — where detailed dessin no. — où détaillé

project title
titre du projet

MILLHAVEN INSTITUTION
CSC
5775 BATH RD.
BATH, ON KOH 1G0

DRY CELL RELOCATION —

STRUCTURED INTERVENTION UNIT

drawing title titre du dessin

DEMOLITION FLOOR PLAN AND DEMOLITION REFLECTED CEILING PLAN

drawn by dessine par **AK**

designed by conc par AD

approved by approuve par


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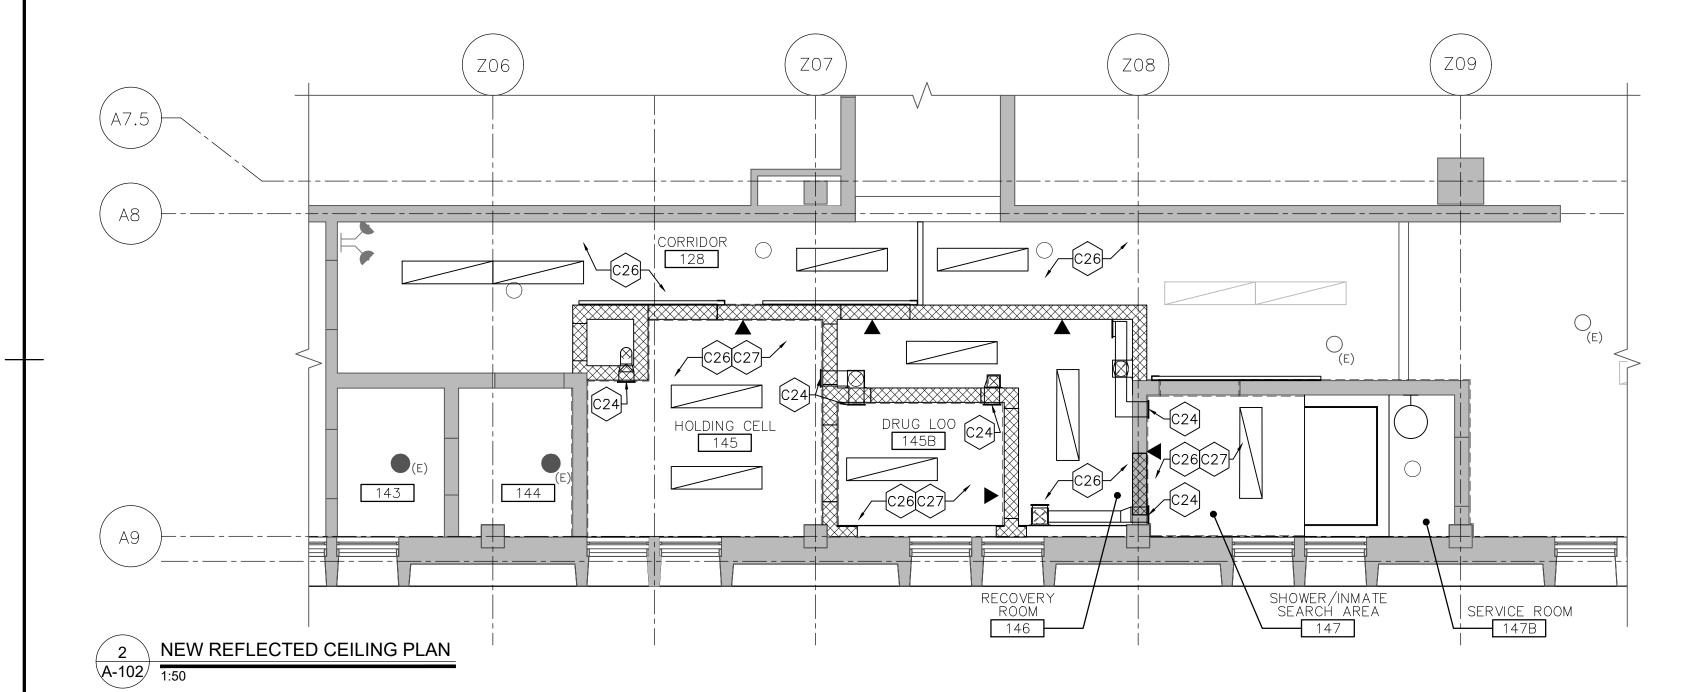
project date date date du projet 2021-02-19


R.106776.001

drawing no. dessine no.

A-101



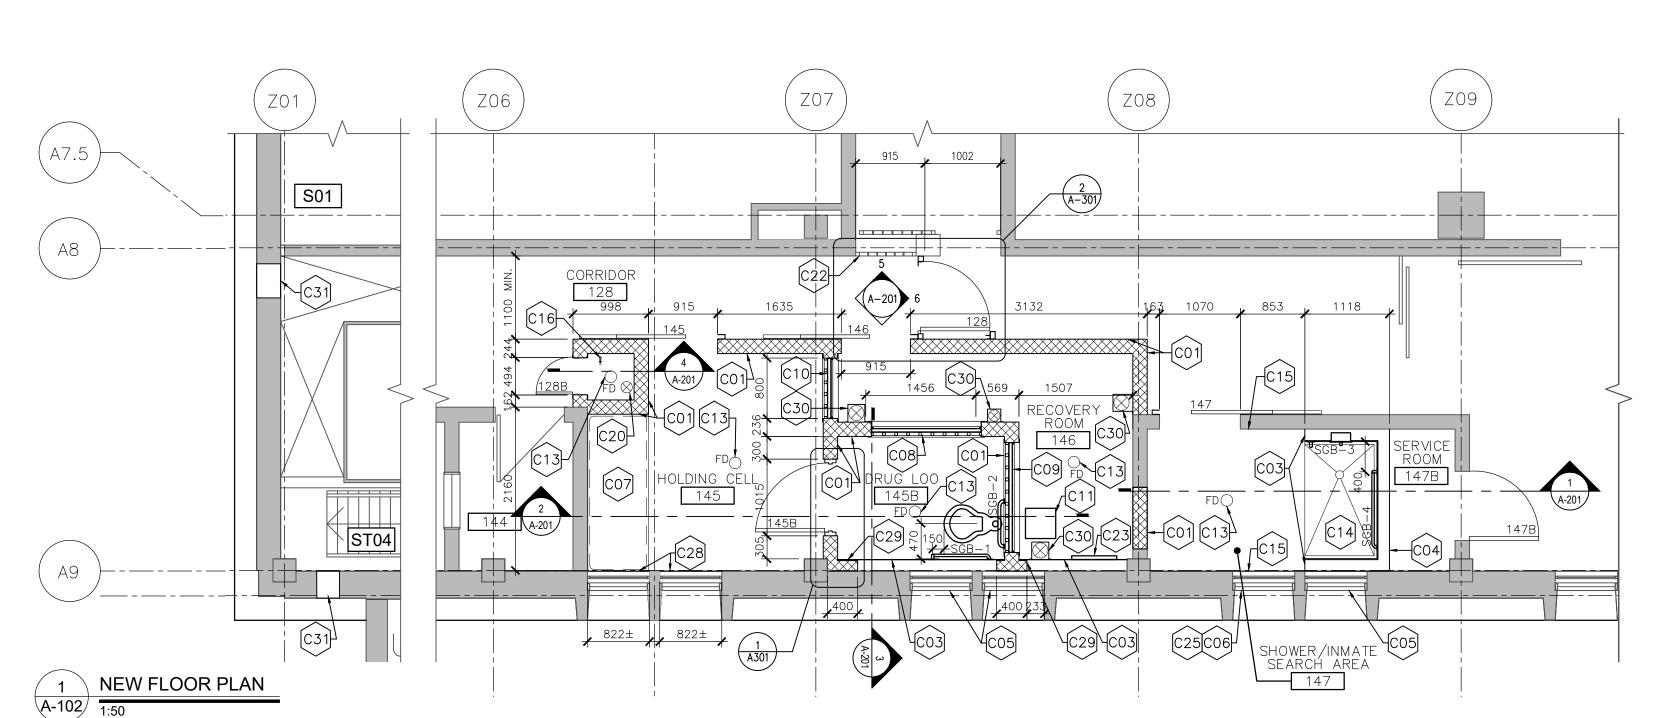


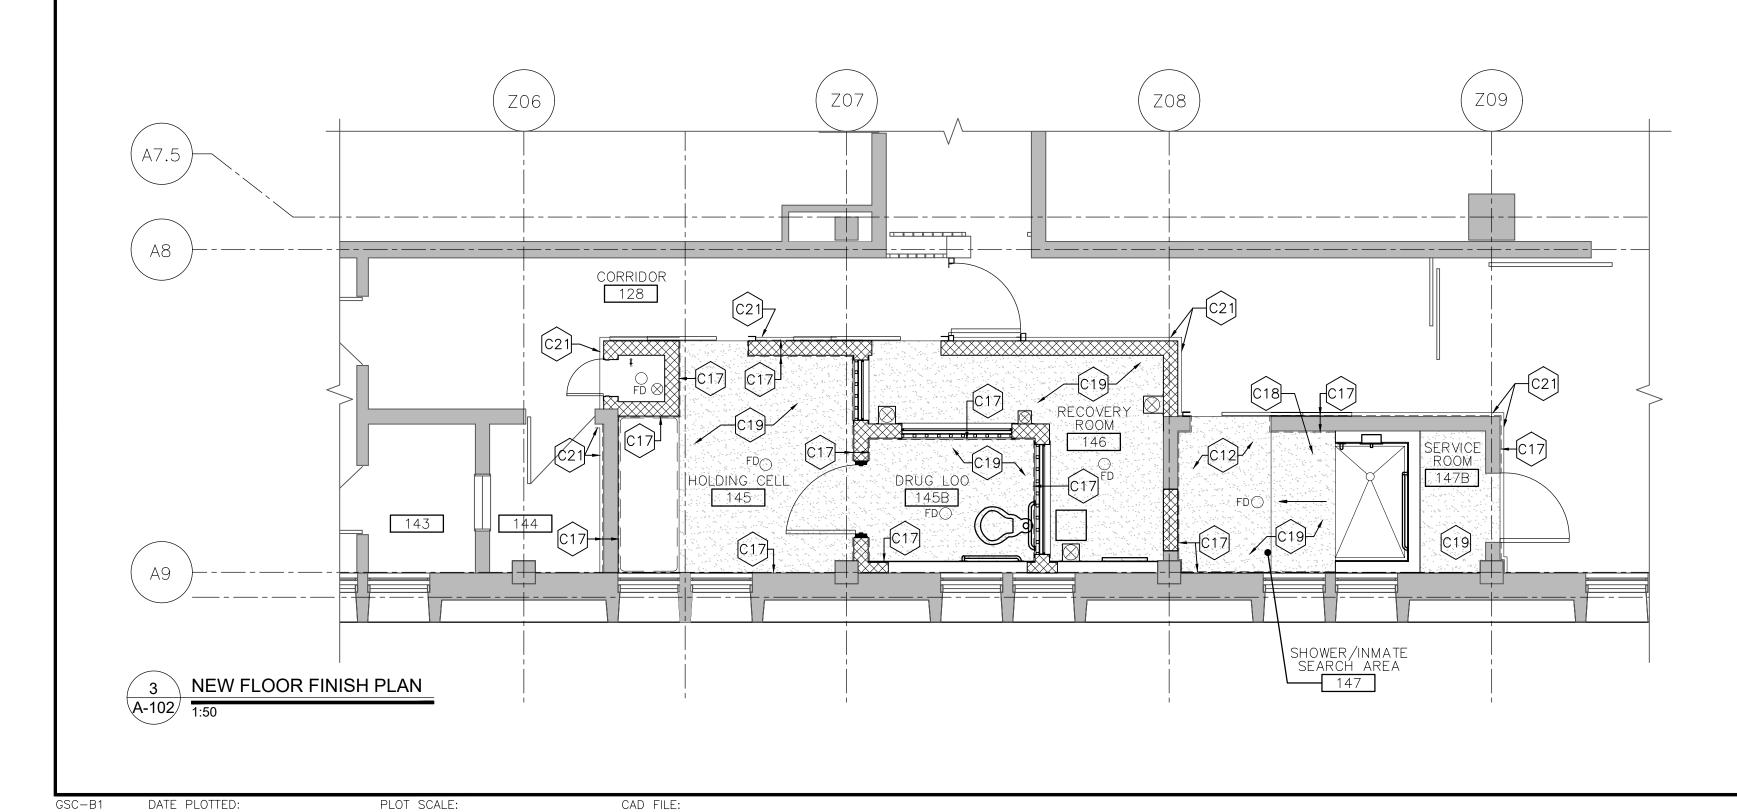

NEW CONSTRUCTION NOTES:

- NEW 190mm CONCRETE BLOCK WALL. FILL ALL CORES WITH GROUT AND REINFORCE VERTICALLY AT 400mm O.C. (P1). REFER TO STRUCTURAL FOR REINFORCEMENT DETAILS.
- (CO2) NOT USED.
- NEW STEEL INFILL PARTITION (P2a). NEW PARTITION TO EXTEND FROM TOP OF FINISHED FLOOR TO UNDERSIDE OF STRUCTURE ABOVE, ±2751mm. STAINLESS STEEL PANELS TO BE USED IN SHOWER. SECURE EDGE OF STAINLESS STEEL SHEET TO NEW SHOWERS.
- CO4 PROVIDE P2 PARTITION AROUND SHOWER UNIT TO PROVIDE REQUIRED REINFORCEMENT FOR SHOWER UNIT, TYP.
- MODIFY WINDOW TO ENSURE OPERABLE PORTION OF THE WINDOW IS FIXED WITH A 32x32x3mm HOLLOW ALUMINUM BAR SPANNING WIDTH OF OPERABLE TRACK AND SECURED WITH SAFETY SCREWS AT 125mm O.C. TO BOTTOM OF FRAME. PAINT WINDOW GLASS TO OBSCURE VISIBILITY TO WALL CAVITY INFILL BETWEEN SECURITY GRILL AND GLASS WITH MINERAL WOOL INSULATION.
- MODIFY WINDOW TO ENSURE OPERABLE PORTION OF THE WINDOW IS FIXED WITH A 32x32x3mm HOLLOW ALUMINUM BAR SPANNING WIDTH OF OPERABLE TRACK AND SECURED WITH SAFETY SCREWS AT 125mm O.C. TO BOTTOM OF FRAME.
- CO7 NEW CONCRETE BED, REFER TO DETAIL 8/A-201.
- NEW VIEWING WINDOW WITH GRILLE BARRIER WO1 ON INMATE SIDE, REFER TO SPECIFICATIONS AND WINDOW SCHEDULE FOR ADDITIONAL DETAILS.
- NEW VIEWING WINDOW WITH GRILLE BARRIER WO2 ON INMATE SIDE, REFER TO SPECIFICATIONS AND WINDOW SCHEDULE FOR ADDITIONAL DETAILS.
- NEW VIEWING WINDOW WITH GRILLE BARRIER WO3 ON INMATE SIDE, REFER TO SPECIFICATIONS AND WINDOW SCHEDULE FOR ADDITIONAL DETAILS.
- C11 RECOVERY UNIT, REFER TO MECHANICAL FOR DUCT/VENT DETAILS.
- NEW CONCRETE TOPPING INSTALLED OVER EXISTING CONCRETE SLAB.
 PROVIDE TIE TO EXISTING TOPPING AS DETAIL BY STRUCTURAL. TOPPING TO HAVE A MAX. SLOPE OF 2% TO THE FLOOR DRAIN. PROVIDE NEW EPOXY FLOORING OVER NEW TOPPING.
- C13 FLOOR DRAIN, REFER TO DETAIL 7/A-301 (TYPICAL).
- NEW STAINLESS STEEL ACCESSIBLE SHOWER, REFER TO MECHANICAL FOR DETAILS.
- NEW HOOKS FOR PRIVACY CURTAIN. HOOKS TO BE MOUNTED 1030mm ABOVE THE FINISHED FLOOR.
- PROVIDE CONNECTIONS FOR NEW HOSE BIB, REFER TO MECHANICAL FOR DETAILS. REFER TO DETAIL 4/A-201 FOR ARCHITECTURAL.
- INSTALL NEW SHEET STEEL FINISH OVER NEW/EXISTING CONCRETE BLOCK WALL REFER TO DETAIL 9/A-301. SHEET STEEL IN SHOWER/INMATE SEARCH AREA ROOM 147 TO BE STAINLESS STEEL.

- PROVIDE NEW SLOPE FLOOR WITH CONCRETE TOPPING TO ENSURE THAT A MINIMUM OF 1% SLOPE IS PROVIDED TO FLOOR DRAIN TO EDGE OF SHOWER STALL.
- NEW EPOXY FLOORING C/W COVE BASE. PROVIDE TRANSITION TO EXISTING RESILIENT SHEET FLOORING. REFER TO SPEC FOR ADDITIONAL INFORMATION
- LOCATION OF SUPPLY AND RETURN AIR DUCTS FROM BASEMENT. REFER TO MECHANICAL AND STRUCTURAL DRAWINGS FOR ADDITIONAL DETAILS.
- C21 PROVIDE 152mm RUBBER FLOOR BASE TO NEAREST INTERSECTION.
- PROVIDE WELDED STEEL PLATE TO EXISTING GATE. REVIEW LOCATION OF GATE IN PLAN ON SITE. CLEARLY INDICATE ALL FINAL LOCATIONS AND SITE MEASUREMENTS ON SHOP DRAWINGS.
- 597x335mm MONITOR AND BRACKET TO BE MOUNTED SO THAT THE CENTRE LINE OF THE MONITOR IS 1600mm ABOVE FINISH FLOOR, SEE ELECTRICAL FOR DETAILS. PROVIDE WOOD BLOCKING TO SUIT THE ENTIRE SIZE OF NEW MONITOR. BLOCKING TO BE CONSTRUCTED WITH 15.9mm THICK PLYWOOD SUPPORTED BY 38x39mm WOOD STUD FRAMING WITH STUDS SPACED NO MORE THAN 200mm O.C. SECURED TO METAL STUDS.
- LOCATION OF SECURE SUPPLY AND RETURN AIR DIFFUSERS THROUGH BLOCK WALL. REFER TO MECHANICAL DRAWINGS FOR ADDITIONAL DETAILS.
- PROVIDE EXTERIOR GRADE WINDOW FILM TO ALL VISUAL PANES OF EXISTING GLAZING. ENSURE SURFACE IS CLEANED AND PREPPED FOR NEW FILM.
- C26 PAINT EXISTING CEILING.
- ALL CONDUIT/PIPES EXTENDING FROM DEVICES IN ROOM IS TO BE COVERED WITH SECURITY COVER. PROVIDE 4mm THICK METAL OUTLET COVER OVER CONDUITS FROM DEVICE TO FACE OF INTERIOR WALL. WELD AND ANCHOR TO CEILING. ALL JOINTS TO BE FULLY SEALED. PROFILE TO BE TRAPEZOIDAL, 215mm WIDE x 75mm HIGH. REFER TO ELECTRICAL FOR LOCATIONS OF CONDUIT.
- MODIFY WINDOW TO ENSURE OPERABLE PORTION OF THE WINDOW IS FIXED FROM THE INTERIOR SIDE WITH A 32x32x3mm HOLLOW ALUMINUM BAR SPANNING WIDTH OF OPERABLE TRACK AND SECURED WITH SAFETY SCREWS AT 125mm O.C. TO BOTTOM OF FRAME. PAINT WINDOW GLASS TO OBSCURE VISIBILITY TO WALL CAVITY. INFILL BETWEEN SECURITY GRILL AND GLASS WITH CALCIUM SILICATE INSULATION. PROVIDE 6mm STEEL PLATE CONTINUOUSLY WELDED TO EXISTING 1905±mm HIGH WINDOW FRAME. ALL EDGES OF STEEL PLATE TO BE ROUNDED AND FILED TO ENSURE SMOOTH EDGES. CONFIRM DIMENSIONS ON SITE, CONTRACTOR TO CLEARLY INDICATE SITE MEASUREMENTS ON SHOP DRAWINGS.
- NEW 140mm CONCRETE BLOCK WALL. FILL ALL CORES WITH GROUT AND REINFORCE VERTICALLY AT 400mm O.C. (P4). REFER TO STRUCTURAL FOR REINFORCEMENT DETAILS. PROVIDE 12mm SHIM TO SUPPORT METAL PANEL.
- LOCATION OF SUPPLY AND RETURN AIR DUCTS FROM BASEMENT. REFER TO MECHANICAL AND STRUCTURAL DRAWINGS FOR ADDITIONAL DETAILS. PROVIDE STAINLESS STEEL ENCLOSURE AROUND METAL DUCT, EXACT SIZE TO BE COORDINATED ON SITE. ROUGHLY 250mm x 250mm BY 2100mm HIGH. PROVIDE 25mm LEG TO ALLOW FOR FASTENING INTO CONCRETE BLOCK WALL WITH SECURE FASTENERS AT 600mm O.C.
- REFER TO STRUCTURAL FOR REPAIR AROUND PRECAST WALL PANEL AND INFILL AROUND NEW OPENING WITH CONCRETE BLOCK WALL AS NEEDED TO WORK AROUND MECHANICAL DUCT. SIZE OF CONCRETE BLOCK TO SUIT EXISTING WALL THICKNESS OF APPROXIMATELY 140mm. INSTALL NEW MECHANICAL LOUVRE, REFER TO MECHANICAL FOR DETAILS. NEW LOUVRE TO BE SET WITHIN FULL BED

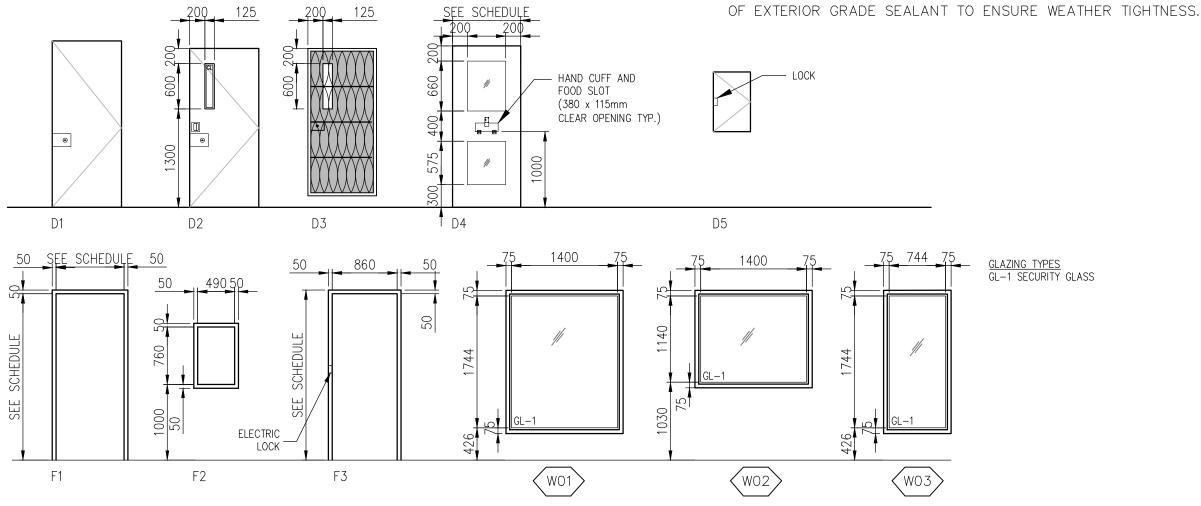

PWGSC ONTARIO REGION PROJECT NUMBER R.106776.001		GION PROJECT DOOR AND FRAME SCHEDULE									
DOOR NO.	SIZE	DOOR TYPE	DOOR MAT'L	DOOR FIN	FRAME TYPE	FRAME MAT'L	FRAME FIN	HARD- WARE GROUP	GLAZING	FRR	NOTES
128	915×2200×50	D3	METAL	PT	_	STEEL	PT	*	GL1	_	
128B	490x790x50	D5	METAL	PT	F2	НМ	PT	5	_	45 MINUTES	REFER TO JAMB DETAIL 8/A-301
145	915x2200x50	D4	METAL	PT	_	STEEL	PT	1	GL1	45 MINUTES	MANUAL SLIDING
145B	1000x2200x50	D1	METAL	PT	F3	STEEL	PT	3	_	45 MINUTES	ELECTRIC RELEASE
146	915×2200×50	D2	METAL	PT	_	STEEL	PT	2	GL1	45 MINUTES	MANUAL SLIDING
147	1070×2200×50	D4	METAL	PT	_	STEEL	PT	1	GL1	45 MINUTES	MANUAL SLIDING
147B	915×2200×50	D1	METAL	PT	EXISTING	_	_	4	_	45 MINUTES	


* REFER TO DETAILS ON A-201 AND A-301 FOR GRILLE CONSTRUCTION AND HARDWARE REQUIREMENTS.

PWGSC OI REGION P NUMBER I		JECT ROOM FINISH SCHEDULE							
ROOM NO.	ROOM NAME	FLOOR	BASE	WALLS	FIN.	CLG	FIN.	HEIGHT mm	NOTES
128	CORRIDOR	EXIST	MATCH EXIST.	CONC.BLK./ SHEET STEEL	PT	EXIST CONC.	PT	EXIST	PATCH, REPAIR & MAKE GOOD ANY DAMAGED AREA TO LIKE NEW CONDITION
145	HOLDING CELL	EPOXY	EPOXY	CONC.BLK./ SHEET STEEL	PT	EXIST CONC.	PT	EXIST	
145B	DRUG LOO	EPOXY	EPOXY	CONC.BLK./ SHEET STEEL	РТ	EXIST CONC.	PT	EXIST	
146	RECOVERY ROOM	EPOXY	EPOXY	CONC.BLK.	PT	EXIST CONC.	PT	EXIST	
147	SHOWER	EPOXY	EPOXY	CONC.BLK./ STEEL STUD	STAINLESS STEEL	EXIST CONC.	PT	EXIST	
147B	SERVICE ROOM	EPOXY	EPOXY	CONC.BLK./ STEEL STUD	_	EXIST CONC.	_	EXIST	

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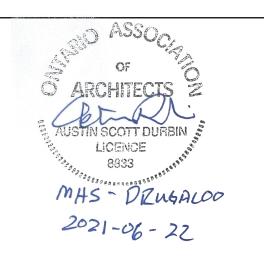
Travaux publics et
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Services d'architecture et de génie



ARCHITECTURE 49

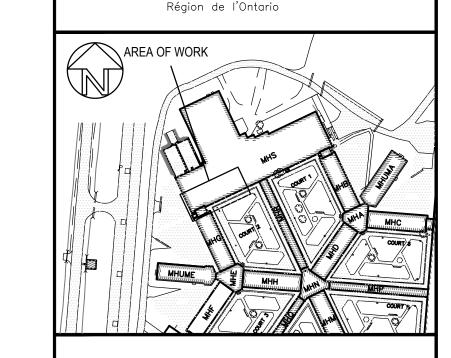



1	ISSUED FOR TENDER	2021-06-22
revision	description	date

Do not scale drawings.

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A Detail No.
No. du détail
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project title
titre du projet

MILLHAVEN INSTITUTION
CSC
5775 BATH RD.
BATH, ON KOH 1GO

DRY CELL RELOCATION —
STRUCTURED INTERVENTION UNIT

drawing title titre du dessin

NEW FLOOR PLAN AND NEW REFLECTED CEILING PLAN

drawn by dessine par AK

designed by conc par AD

approved by approuve par AD


project date date date du projet 2021-02-19


project no. no. du projet

R.106776.001

drawing no.

A-102

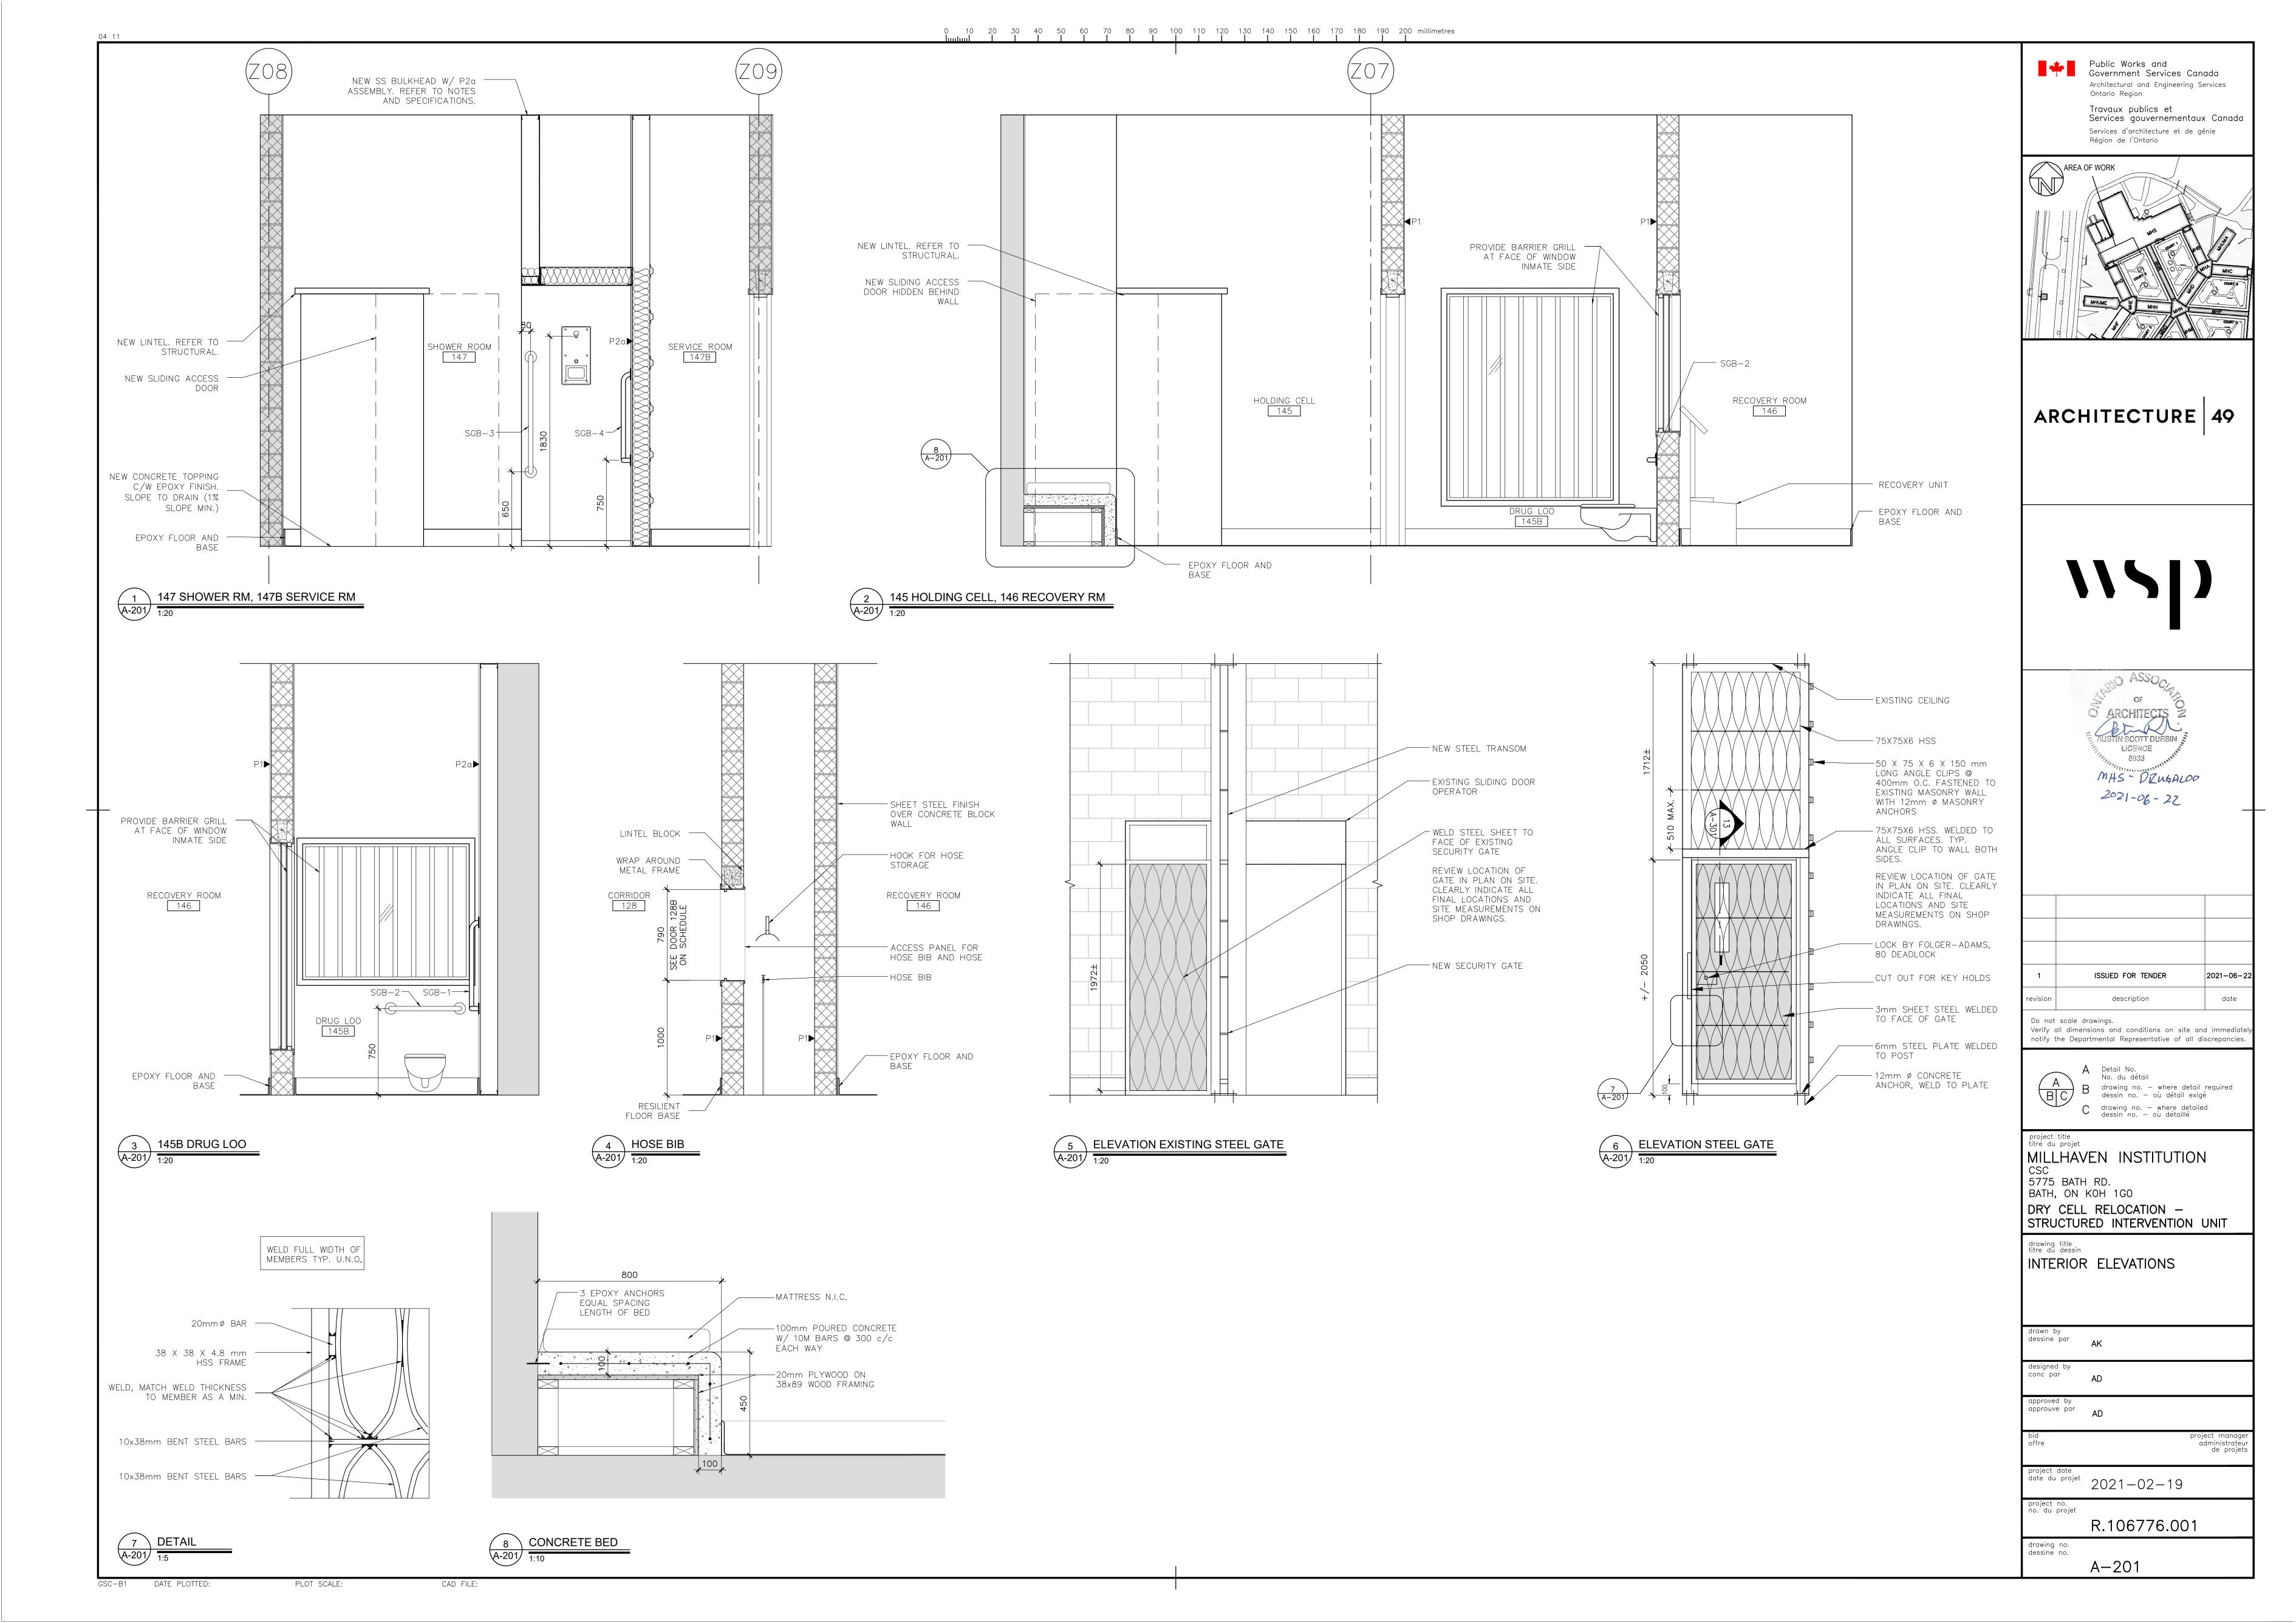

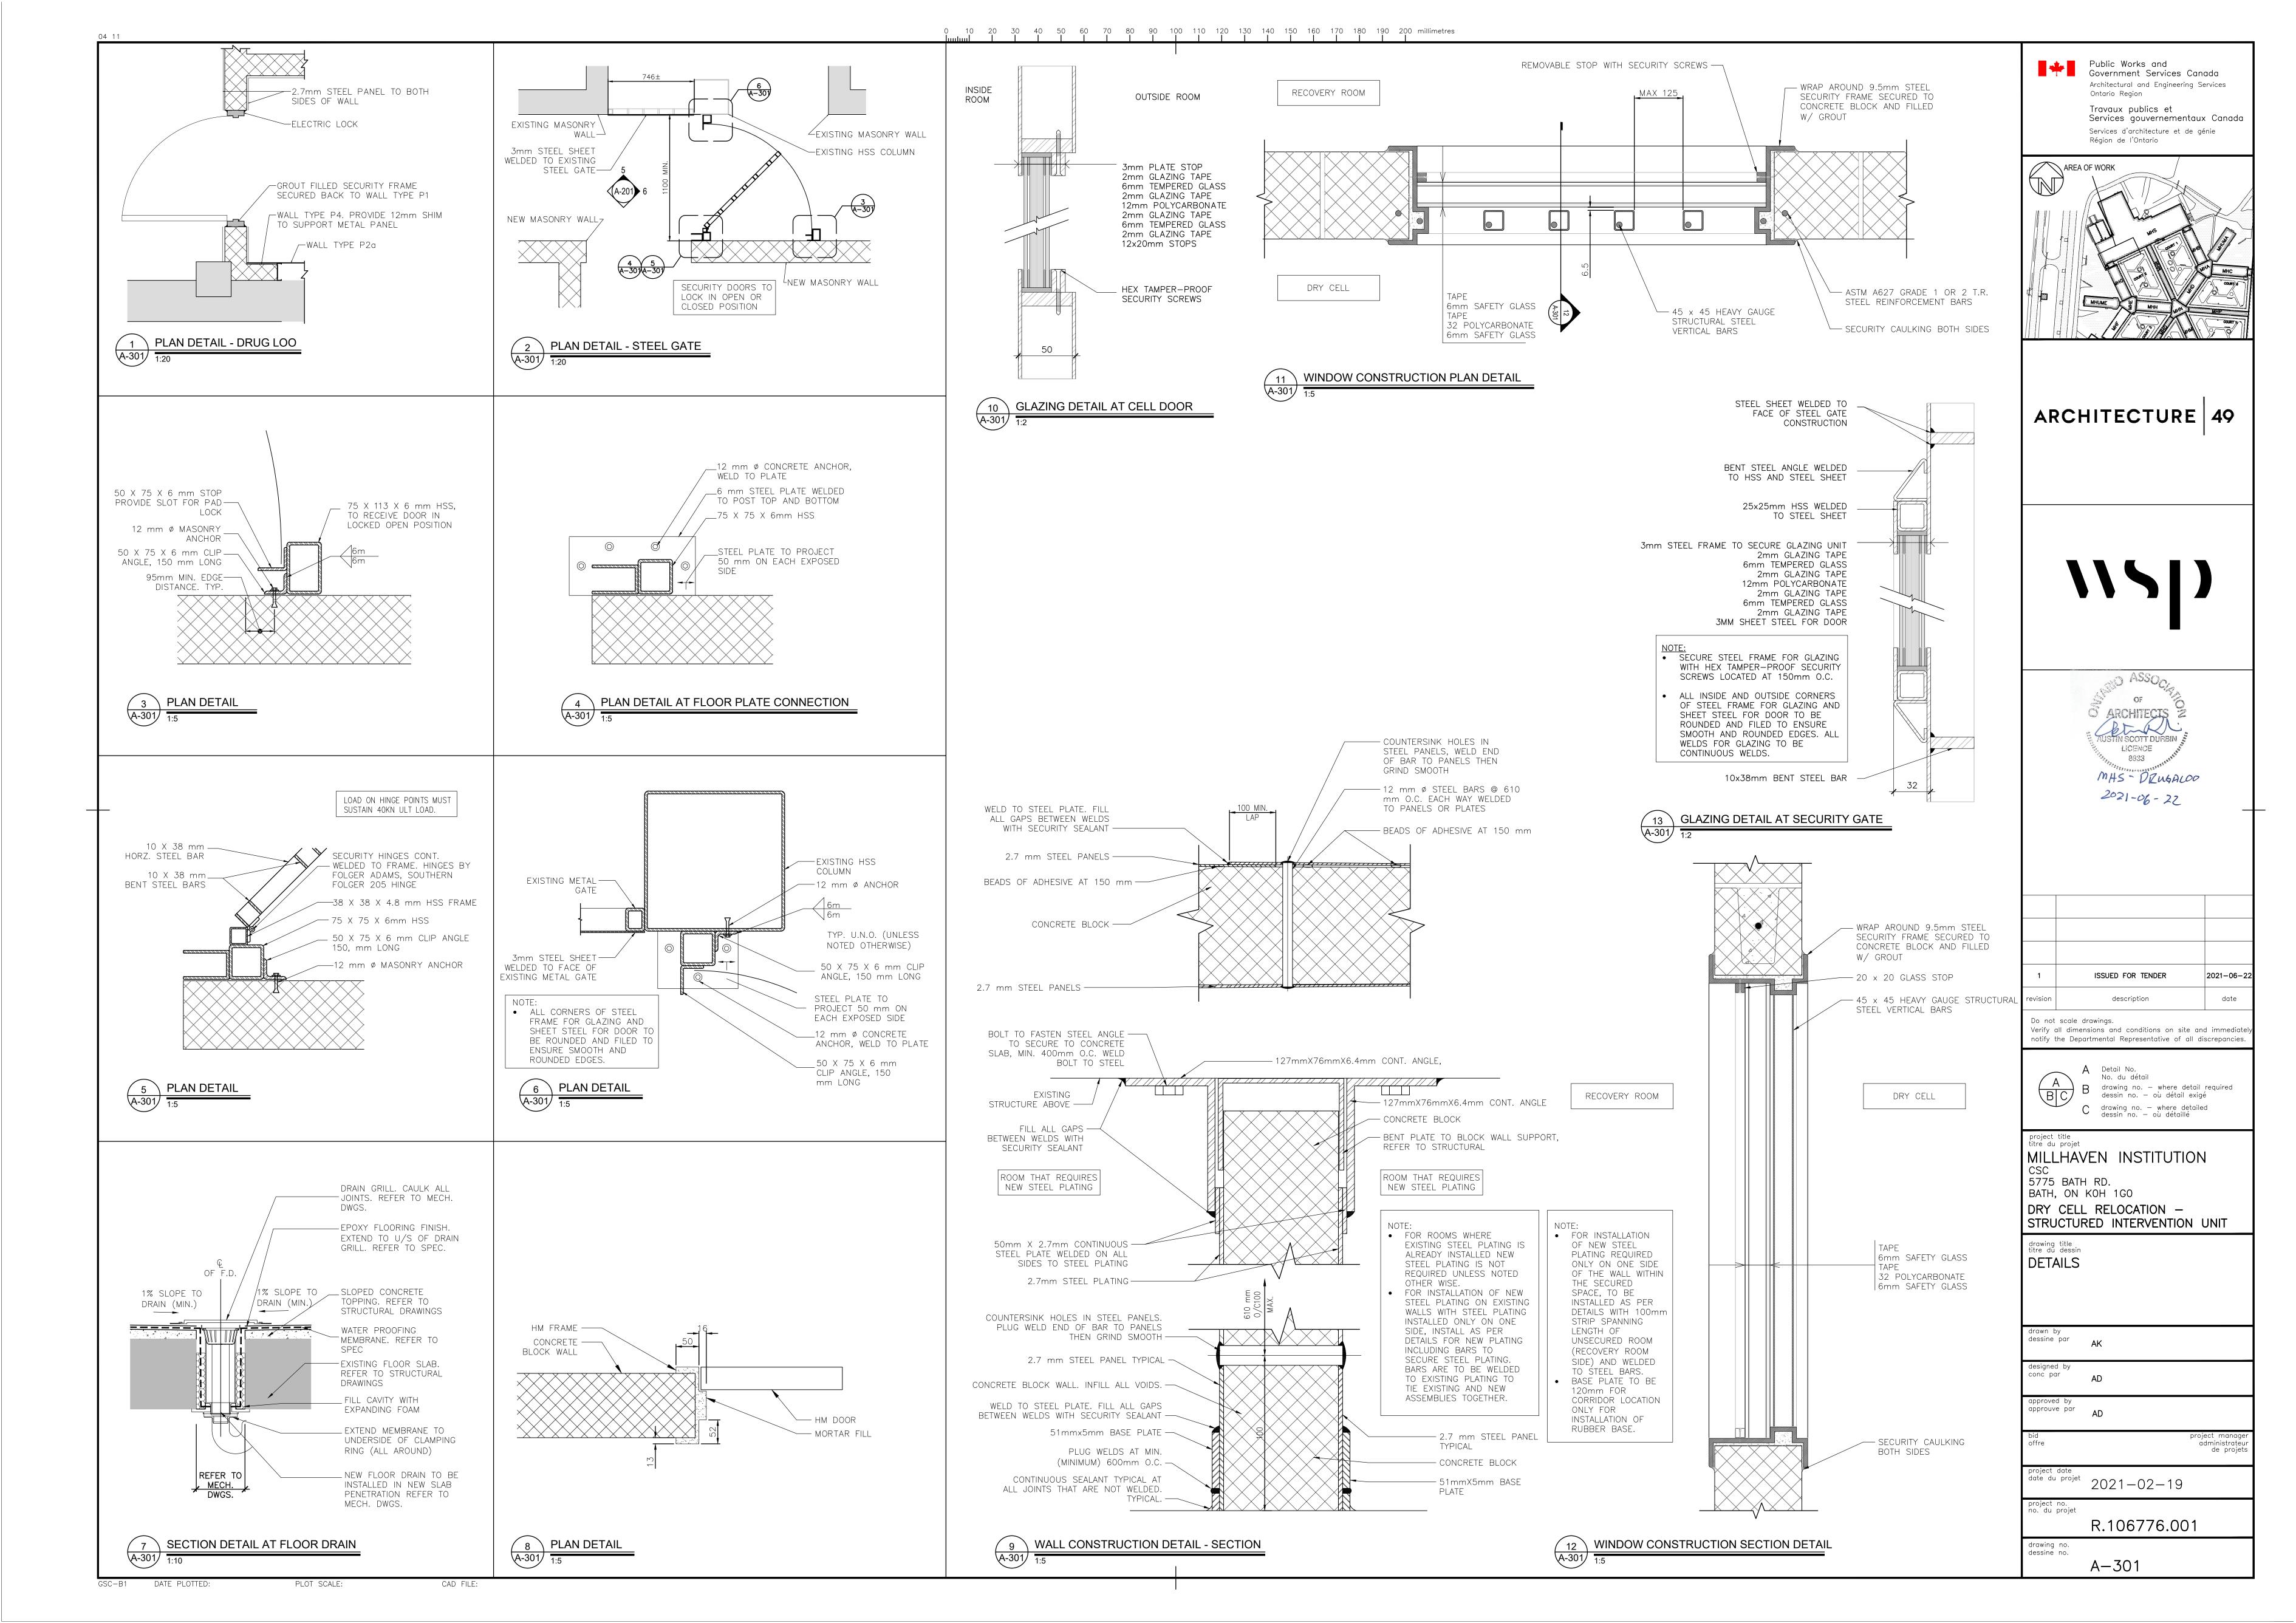

GENERAL

- THIS IS A METRIC PROJECT. UNLESS OTHERWISE NOTED, ALL DIMENSIONS ARE IN MILLIMETERS. 2. PROVIDE ALL MATERIAL AND LABOUR REQUIRED FOR COMPLETION OF THE WORK.
- 3. PRIOR TO CONSTRUCTION, REVIEW STRUCTURAL DRAWINGS IN CONJUNCTION WITH DRAWINGS PROVIDED BY ALL OTHER DISCIPLINES, AND WITH EXISTING CONDITIONS.
- 4. REPORT DISCREPANCIES TO THE DEPARTMENTAL REPRESENTATIVE BEFORE PROCEEDING WITH THE WORK.
- 5. VERIFY EXISTING DIMENSIONS AND CONDITIONS ON SITE PRIOR TO CONSTRUCTION. 6. USE THESE DRAWINGS ONLY FOR THE PURPOSE IDENTIFIED IN THE REVISIONS COLUMN. DO NOT CONSTRUCT FROM
- THESE DRAWINGS UNLESS MARKED "ISSUED FOR CONSTRUCTION".

COMPONENTS DURING ERECTION AS WELL AS SAFETY OF OCCUPANTS AND WORKERS.

- DO NOT USE INFORMATION ON THESE DRAWINGS FOR ANY OTHER PROJECT OR WORKS.
- 8. DO NOT SCALE THESE DRAWINGS. 9. ALL SECTIONS, DETAILS, AND STATEMENTS NOTED AS "TYPICAL" APPLY TO LIKE/SIMILAR CONDITIONS IN THE
- STRUCTURE. 10. DRAWINGS SHOW COMPLETED STRUCTURE ONLY. THEY DO NOT SHOW TEMPORARY WORKS FOR WHICH THE CONTRACTOR IS RESPONSIBLE AND WHICH MAY BE REQUIRED FOR EXECUTION OF THE PROJECT. THE CONTRACTOR TO ESTABLISH CONSTRUCTION PROCEDURE AND SEQUENCE TO ENSURE SAFETY OF THE WHOLE STRUCTURE AND ALL ITS
- 11. MAKE ADEQUATE PROVISIONS FOR ALL LOADS ACTING ON THE EXISTING STRUCTURE DURING CONSTRUCTION. PROVIDE TEMPORARY SHORING AND BRACING TO KEEP THE STRUCTURE PLUMB AND IN TRUE ALIGNMENT DURING CONSTRUCTION.
- 12. DESIGN OF ALL TEMPORARY WORKS TO BE CARRIED OUT BY A PROFESSIONAL ENGINEER RETAINED BY THE
- CONTRACTOR, LICENSED IN THE PLACE WHERE THE PROJECT IS LOCATED. 13. DESIGN OF NON- STRUCTURAL AND SECONDARY STRUCTURAL ELEMENTS (SUCH AS MISCELLANEOUS STEEL STAIRS, RAILINGS AND GUARDRAILS, PARTITIONS, CLADDING, BULKHEADS, ETC.) IS THE RESPONSIBILITY OF PROFESSIONAL ENGINEERS ENGAGED BY THE CONTRACTOR.

DESIGN CRITERIA

- 1. STRUCTURAL DESIGN IS IN ACCORDANCE WITH THE 2012 ONTARIO BUILDING CODE (OBC, SUPPLEMENTED BY THE 2015
- NATIONAL BUILDING CODE OF CANADA STRUCTURAL COMMENTARY). ALL REFERENCED STANDARDS SHALL BE THE CURRENT EDITION UNLESS DIFFERENT EDITION IS REFERENCED BY THE
- APPLICABLE BUILDING CODE NOTED ABOVE. 3. EXISTING STRUCTURAL DRAWINGS ARE AVAILABLE THROUGH THE DEPARTMENTAL REPRESENTATIVE. CONTRACTOR
- SHALL VERIFY THE VALIDITY OF THE EXISTING DRAWINGS WITH TRUE SITE CONDITIONS. THE DRAWINGS MAY NOT DEPICT THE ACTUAL CONDITION ENCOUNTERED ON SITE.
- 4. IF ONLY ONE VALUE IS GIVEN FOR A LOAD, CONSIDER IT LIVE LOAD.

FIELD REVIEW

- 1. DEPARTMENTAL REPRESENTATIVE WILL PROVIDE PERIODIC FIELD REVIEW OF A REPRESENTATIVE SAMPLE OF THE STRUCTURAL WORKS DETAILED ON THESE DRAWINGS FOR GENERAL CONFORMANCE WITH CONTRACT DOCUMENTS THESE REVIEWS DO NOT REPLACE THE CONTRACTOR'S RESPONSIBILITY TO IMPLEMENT AND MAINTAIN A QUALITY CONTROL PROGRAM, AND DO NOT MAKE DEPARTMENTAL REPRESENTATIVE A GUARANTOR OF THE CONTRACTOR'S
- 2. CONTRACTOR SHALL ASSIST THE DEPARTMENTAL REPRESENTATIVE DOING FIELD REVIEW, AND PROVIDE SAFE ACCESS TO WORK AREAS AS REQUIRED.
- 3. CHECK THE WORK PRIOR TO FIELD REVIEW TO CONFIRM IT IS COMPLETED AND IN ACCORDANCE WITH CONTRACT
- 4. CONTRACTOR SHALL NOTIFY THE DEPARTMENTAL REPRESENTATIVE 48 HOURS PRIOR TO CONCRETE POURS, BACKFILLING, AND COVERING UP THE STRUCTURE WITH FINISHES.

EXISTING STRUCTURE

- 1. EXISTING STRUCTURAL INFORMATION IS BASED UPON DRAWINGS PREPARED BY J.L. RICHARDS & ASSOCIATES LTD., DATED DECEMBER 1967.
- 2. EXISTING CONDITIONS ARE ASSUMED. SURVEY THE EXISTING STRUCTURE AFTER REMOVING FINISHES AND REPORT ANY VARIATIONS TO DEPARTMENTAL REPRESENTATIVE BEFORE PROCEEDING WITH THE WORK.
- 3. TAKE ALL PRECAUTIONS NECESSARY TO PROTECT THE EXISTING STRUCTURE DURING CONSTRUCTION. 4. SCHEDULE WORK TO MINIMIZE EFFECT ON THE EXISTING BUILDING OPERATION. USE EQUIPMENT AND PROCEDURES TO
- MINIMIZE NOISE, DUST AND VIBRATIONS. SUBMIT PROPOSED SCHEDULE FOR REVIEW BY THE DEPARTMENTAL REPRESENTATIVE. 5. DO NOT PERMIT LOADS FROM CONCRETE FORMWORK TO BE TRANSMITTED TO ADJACENT EXISTING STRUCTURES. 6. ALL DEMOLITION, SHORING, AND OTHER TEMPORARY WORKS TO BE DESIGNED BY A PROFESSIONAL ENGINEER RETAINED BY THE CONTRACTOR, LICENSED IN THE PLACE WHERE THE PROJECT IS LOCATED. PREPARE DRAWINGS
- SIGNED AND SEALED BY THAT ENGINEER SHOWING DEMOLITION PROCEDURE AND SEQUENCE AND ALL THE NECESSARY SHORING AND SUBMIT TO THE DEPARTMENTAL REPRESENTATIVE FOR REVIEW. 7. UNDERTAKE CHIPPING, CUTTING, CORING, REPAIRS, PATCHING, AND REMOVAL OF DEBRIS, MAKE CUTS WITH THE
- PROPER SAWS AND BITS WHEN A CLEAN LINE IS REQUIRED. REFER TO CUTTING AND CORING SECTION FOR ADDITIONAL PROCEDURES.
- 8. DO NOT ALTER MATERIAL PROPERTIES OF THE STRUCTURAL STEEL WHICH IS TO REMAIN BY CUTTING AND DEMOLITION PROCEDURE. SUBMIT ALL PROCEDURES FOR REVIEW PRIOR TO PROCEEDING WITH THE WORK.
- 9. MAKE GOOD ALL EXISTING WORK DISTURBED BY SHORING OPERATIONS, EXCAVATION AND OTHER CONSTRUCTION
- PROCEDURES.

CONCRETE

- 1. CONCRETE IS SPECIFIED PER ALTERNATIVE 1 PERFORMANCE SPECIFICATION, AS OUTLINED IN CSA A23.1:19/A23.2:19. THE CONTRACTOR AND THE CONTRACTORS SUB-TRADE TO MEET ALL CERTIFICATION, DOCUMENTATION, AND QUALITY CONTROL REQUIREMENTS.
- 2. THE CONTRACTORS SUB-TRADE TO BE CERTIFIED BY THE READY MIXED CONCRETE ASSOCIATION OF ONTARIO. 3. CONCRETE TO BE NORMAL DENSITY (MIN. 2300 kg/m³) UNLESS NOTED OTHERWISE.
- 4. CEMENT TO BE PORTLAND CEMENT TYPE GU, UNLESS NOTED OTHERWISE OR REQUIRED BY EXPOSURE CLASS. CEMENT TO CONFORM TO CSA A3000.
- 5. AGGREGATE TO CONFORM TO CSA A23.1:19 / A23.2:19. DO NOT USE RECYCLED CONCRETE AS AGGREGATE.
- 6. CONCRETE ADMIXTURES SHALL NOT CONTAIN CHLORIDES.
- SUBMIT CONCRETE MIX DESIGNS TO DEPARTMENTAL REPRESENTATIVE
- 8. INTERIOR APPLICATIONS:
- EXPOSURE CLASS: N - MINIMUM COMPRESSIVE STRENGTH AT 28 DAYS: 25 MPa.
- NOMINAL SIZE OF COARSE AGGREGATE: 20
- NOMINAL SIZE OF COURSE AGGREGATE FOR :
- TOPPINGS BETWEEN 25 AND 35 MM THICK: 10mm - TOPPINGS BETWEEN 35 AND 50 MM THICK: 14mm
- 9. PROTECT CONCRETE FROM EXCESSIVE HEAT AND DRYING. USE HOT WEATHER CONCRETING METHODS IN ACCORDANCE
- WITH CSA A23.1/A23.2 WHENEVER THE OUTDOOR TEMPERATURE IS GREATER THAN 27°C. 10. PROTECT CONCRETE FROM FREEZING. USE COLD WEATHER CONCRETING METHODS IN ACCORDANCE WITH CSA A23.1/A23.2 WHENEVER OUTDOOR TEMPERATURE IS LESS THAN +5°C. ALL INSULATED COVERS, HEATERS, AND OTHER MATERIALS NEEDED TO PROTECT CONCRETE TO BE ON HAND PRIOR TO POUR. DELIVER CONCRETE AT A TEMPERATURE
- BETWEEN +15°C AND +27°C. ENSURE A MINIMUM CONCRETE TEMPERATURE OF 10° IS MAINTAINED THROUGHOUT THE CURING PERIOD (MINIMUM 3 DAYS). 11. FORMWORK DESIGN, MATERIAL, FABRICATION, AND ERECTION TO CONFORM TO CSA S269.1

PLOT SCALE:

- 12. FORMWORK MATERIAL TO BE NEW EXTERIOR PLYWOOD CONFORMING TO CSA 0121, EXCEPT FOR ROUGH CONCRETE IN UNEXPOSED LOCATIONS (SUCH AS FOUNDATIONS) WHERE USED MATERIAL IS ACCEPTABLE.
- 13. CURE CONCRETE SURFACES NOT IN CONTACT WITH FORMS IN ACCORDANCE WITH CSA A23.1:19 / A23.2:19, BY APPLICATION OF A CURING-SEALING COMPOUND CONFORMING TO ASTM C309 IMMEDIATELY AFTER DISAPPEARANCE OF SURFACE WATER SHEEN. ENSURE CURING-SEALING COMPOUND IS COMPATIBLE WITH APPLIED FINISHES.

CONCRETE REINFORCEMENT

- 1. REINFORCEMENT DEFORMED BAR REINFORCEMENT CONFORMING TO CSA G30.18 GRADE 400R. USE 400W ONLY WHERE NOTED ON DRAWINGS.
- WELDED WIRE FABRIC CONFORM TO ASTM A1064/A1064M, YIELD STRENGTH 450 MPa, SUPPLIED IN FLAT SHEETS ONLY. LAP WELDED WIRE FABRIC SHEETS BY ONE SPACING OF CROSS WIRES + 50, MEASURED BETWEEN THE OUTERMOST CROSS WIRES IN EACH SHEET. IN SLABS, PLACE AT 1/3 SLAB THICKNESS BELOW TOP OF SLAB.
- 4. ACCESSORIES, BAR SUPPORTS, AND TIES TO CONFORM TO REINFORCING STEEL INSTITUTE OF CANADA (RSIC) MANUAL OF STANDARD PRACTICE AND CSA A23.1:19 / A23.2:19.
- 5. ALL REINFORCING BAR SIZES ARE METRIC; "M" IS NOT NECESSARILY MARKED AFTER A BAR SIZE. FOR EXAMPLE, 10-15B NOTED ON PLAN INDICATES 10 BARS OF 15M DIAMETER, PLACED AT BOTTOM.
- 6. SUBMIT SHOP DRAWINGS FOR REINFORCEMENT DETAILED IN ACCORDANCE WITH THE RSIC MANUAL OF STANDARD PRACTICE. SUBMIT PLANS AND DETAILS NECESSARY TO FABRICATE, PLACE, AND REVIEW REINFORCEMENT
- 7. ALL REBAR HOOKS TO BE STANDARD LENGTH 90° OR 180° HOOKS. REBAR LENGTHS LISTED ON DRAWINGS DO NOT INCLUDE THE HOOK LENGTH.
- 8. FIELD BENDING OF BARS IS NOT PERMITTED UNLESS INDICATED OR APPROVED BY DEPARTMENTAL REPRESENTATIVE. APPROVED FIELD BENDING TO BE DONE WITHOUT THE USE OF HEAT, THROUGH APPLICATION OF SLOW AND STEADY
- PRESSURE. REPLACE BARS WITH CRACKS OR SPLITS. ALL REINFORCING TO BE CLEAN, FREE OF LOOSE SCALE, OIL, DIRT, RUST, AND ANY OTHER FOREIGN COATING THAT
- AFFECT BONDING CAPACITY. 10. UNLESS OTHERWISE NOTED, LAP ALL HORIZONTAL GRADE BEAM REINFORCING WITH CLASS B LAPS. CARRY
- CONTINUOUSLY THROUGH PIERS AND PILE CAPS WHERE APPLICABLE 11. FOR CLASS N CONCRETE, MINIMUM CONCRETE COVER TO REINFORCING BARS CLOSEST TO THE CONCRETE SURFACE
- TO BE 40 FOR BEAMS AND COLUMNS AND 25 FOR SLABS AND WALLS. 12. ENSURE COVER TO REINFORCEMENT IS MAINTAINED DURING CONCRETE POUR.

MASONRY

- CONFORM TO CAN/CSA-A371-14(R2019) AND CSA S304.1.
- UNLESS OTHERWISE NOTED ON PLANS, MATERIALS TO BE:
- HOLLOW BLOCK: CSA A165.1-14(R2019) H/15/A/M SOLID BLOCK: CSA A165.1 -14(R2019)- SF/15/A/M
- MORTAR:
 - CAN/CSA-A179 TYPE S, PROPORTIONED BY VOLUME.
- MASONRY GROUT: CAN/CSA-A179, PROPORTIONED BY VOLUME COARSE GROUT, 1:3:2 CEMENT: SAND: MAX 9.5
- AGGREGATE, OR FINE GROUT, 1:3 CEMENT:SAND, OR APPROVED PRE-BAGGED MATERIAL NON LOAD-BEARING MASONRY WALLS ARE NOT NECESSARILY SHOWN ON STRUCTURAL DRAWINGS, SEE
- ARCHITECTURAL DRAWINGS. 4. UNLESS NOTED OTHERWISE, LAY UNITS IN RUNNING BOND. ALL FACE SHELLS TO BE FULLY BEDDED.
- 5. DO NOT USE MORTAR WHERE GROUT IS SPECIFIED.
- UNLESS OTHERWISE NOTED, PROVIDE DEFORMED, LADDER TYPE HORIZONTAL JOINT REINFORCING (TO SUIT THE WALL THICKNESS) PER ARCHITECTURAL SPECIFICATIONS. STAGGER LAPS MIN. 750 FROM COURSE TO COURSE. CLIP OFF CROSS RODS AT LAPS TO KEEP WIRES IN ONE PLANE. FOR UNREINFORCED WALLS, IT IS ACCEPTABLE TO USE TRUSS TYPE INSTEAD OF LADDER TYPE JOINT REINFORCING.
- 7. FOR WALLS SHOWN TO BE LAID IN STACK BOND, PROVIDE HORIZONTAL JOINT REINFORCING IN EVERY BED JOINT.
- 8. PROVIDE HORIZONTAL JOINT REINFORCING IN THE FIRST TWO BED JOINTS ABOVE AND BELOW EACH WALL OPENING AND
- EXTEND 600 (2'-0") BEYOND EACH SIDE OF OPENING. 9. UNLESS OTHERWISE NOTED, USE CORNER TYPE LADDER REINFORCING AT MASONRY WALL CORNERS AND
- INTERSECTIONS.
- 10. UNLESS OTHERWISE NOTED, INTERLOCK MASONRY COURSES AT WALL CORNERS.
- 11. TOOL JOINTS IN ALL WALLS SHOWN ON STRUCTURAL DRAWINGS (WHETHER EXPOSED OR NOT IN THE FINISHED
- BUILDING) TO PROVIDE HARD, DENSE JOINTS. 12. PROVIDE LATERAL SUPPORT AT TOPS OF ALL WALLS, REFER TO TYPICAL DETAILS TM-LATS-13 AND ARCHITECTURAL
- SPECIFICATIONS. LOCATE MAX 300 FROM WALL ENDS AND MOVEMENT JOINTS. 13. UNLESS OTHERWISE NOTED, PROVIDE MINIMUM 25 DEFLECTION GAP AT TOP OF ALL NON LOAD BEARING MASONR'
- 14. PROVIDE TEMPORARY BRACING FOR LOAD BEARING MASONRY WALLS UNTIL THE SUPPORTED STRUCTURE, WHICH PROVIDES PERMANENT BRACING, IS COMPLETED.
- 15. PROVIDE STANDARD LINTELS OVER ALL OPENINGS IN NON-LOAD BEARING MASONRY WALLS, REFER TO ARCHITECTURAL DRAWINGS AND TYPICAL DETAILS TM-WALL-01, TM-WALL-11 TO TM-WALL- 14. THE OPENINGS ARE NOT NECESSARILY SHOWN ON STRUCTURAL DRAWINGS, REFER TO ARCHITECTURAL, MECHANICAL AND ELECTRICAL DRAWINGS. USE ONLY FINE GROUT TO FILL MASONRY LINTELS.
- 16. REINFORCED MASONRY:
- 17. SEE PLANS AND DETAILS FOR STRUCTURAL MASONRY REINFORCING.
- 18. FOR NON-LOAD BEARING MASONRY, SEE TYPICAL DETAIL TM-WALL-01 FOR MINIMUM SEISMIC MASONRY REINFORCING.
- 19. DO NOT PLACE CONDUITS IN, NOR ALLOW OVER-HANGING MORTAR OR DEBRIS INSIDE, MASONRY CELLS TO BE REINFORCED.
- 20. SPLICES FOR MASONRY WALL REINFORCING TO BE:
- WIRE REINFORCING 300 10M BARS 15M BARS

20M BARS

- 25M BARS LOCATE VERTICAL BARS ACCURATELY WITHIN CELLS AS INDICATED ON DRAWINGS. HOLD IN POSITION TOP AND BOTTOM.
- USE REBAR POSITIONERS AS REQUIRED. 22. LOCATE TOP / BOTOM HORIZONTAL BARS IN MASONRY BEAMS AND LINTELS 50 (2") CLEAR FROM TOP / UNDERSIDE OF
- 23. EXTEND ALL VERTICAL REINFORCING TO WITHIN 50 FROM TOP OF WALL.
- 24. CARRY ALL VERTICAL REINFORCING CONTINUOUSLY THROUGH BOND BEAMS AND MASONRY LINTELS.
- 25. PROVIDE VERTICAL DOWELS AT BASE OF WALLS TO MATCH VERTICAL REINFORCING. UNLESS OTHERWISE NOTED ON DRAWINGS, EMBED INTO SLAB WITH STANDARD HOOKS OR PROVIDE CLASS B LAP INTO FOUNDATION WALLS BELOW (AS APPLICABLE).
- 26. REINFORCE SIDES OF ALL WALL OPENINGS EXCEEDING 1000 IN WIDTH WITH ADDITIONAL 1-15 VERTICAL. CARRY FULL HEIGHT OF WALL. WHERE STEEL OR PRECAST CONCRETE LINTELS ARE USED, OFFSET VERTICALS TO CLEAR LINTEL BEARINGS.
- 27. UNLESS OTHERWISE NOTED, ADD 1-15 VERTICAL AT WALL ENDS, AND AT EACH SIDE OF MOVEMENT JOINTS.
- 28. THE ADDITIONAL REINFORCING SPECIFIED IN THE CLAUSES ABOVE IS NOT NOTED ON PLANS. 29. SEE TYPICAL DETAILS FOR ADDITIONAL REINFORCING UNDER STEEL BEAM AND STEEL JOIST BEARINGS.
- 18. UNLESS MASONRY WALLS ARE NOTED AS "FULLY GROUTED" OR "GROUTED SOLID", GROUT ONLY CELLS CONTAINING
- VERTICAL OR HORIZONTAL REINFORCEMENT AND ANCHOR RODS OR STRAPS, AND OTHER AREAS SPECIFICALLY INDICATED ON DRAWINGS.
- 19. USE ONLY FINE GROUT TO FILL BOND BEAMS.
- 20. USE LOW LIFT GROUTING PROCEDURE UNLESS OTHERWISE APPROVED IN WRITING BY DEPARTMENTAL REPRESENTATIVE. PLACE GROUT IN LIFTS NOT EXCEEDING 1500 HEIGHT. TERMINATE EACH LIFT 40 BELOW TOP OF
- 21. USE POLYPROPYLENE GROUT SCREENS BELOW BOND COURSES AND GROUTED BLOCKS TO ISOLATE GROUT FLOW IN DESIGNATED AREAS. DO NOT USE BUILDING PAPER.
- 22. SEE TYPICAL DETAILS FOR GROUTING UNDER STEEL BEAM AND STEEL JOIST BEARINGS.

CUTTING AND CORING

- 1. RETAIN AN INDEPENDENT TESTING COMPANY TO LOCATE AND MARK EXISTING REINFORCEMENT AND CONDUIT IN THE AREAS OF PROPOSED OPENINGS USING A NON-DESTRUCTIVE METHOD. IF LOCATIONS ARE NOT ACCEPTABLE TO DEPARTMENTAL REPRESENTATIVE RELOCATE PROPOSED OPENINGS AND REPEAT PROCESS AT NO EXTRA COST TO THE
- 2. CORING: DO NOT CUT EXISTING REINFORCEMENT OR CONDUIT WHEN CORING EXISTING CONCRETE UNLESS APPROVED IN ADVANCE BY DEPARTMENTAL REPRESENTATIVE. SAVE COMPLETE LENGTH OF ALL CORES AND LABEL WITH LOCATION TAKEN. MAKE ALL CORES AVAILABLE FOR REVIEW, DO NOT DISPOSE OF CORES WITHOUT DEPARTMENTAL
- REPRESENTATIVE APPROVAL. CUTTING: DO NOT CUT EXISTING REINFORCEMENT AND CONDUIT UNLESS APPROVED IN ADVANCE BY DEPARTMENTAL REPRESENTATIVE. DO NOT OVERCUT OPENINGS. CORE FOUR CORNERS AND ENDS OF INTERMEDIATE SAWCUTS OF ALL OPENINGS PRIOR TO CUTTING SIDES AND INTERMEDIATE LINES. CHIP CORNERS SQUARE AFTER SAWCUTTING IF NECESSARY. IF NEW REINFORCEMENT IS REQUIRED AT AN OPENING, INSTALL IT BEFORE CUTTING OR SHORE THE
- STRUCTURE UNTIL THE NEW REINFORCEMENT IS INSTALLED. 4. CUTTING: REFER TO TYPICAL DETAIL TC-SL-71 FOR CONCRETE SAWCUTTING PROCEDURE.

INSPECTION AND TESTING

- PROVIDE INSPECTION REPORTS PREPARED BY AN INDEPENDENT INSPECTION AND TESTING AGENCY FOR THE SCOPES LISTED BELOW. THE COST OF THE INSPECTION WILL BE BORNE BY THE CONTRACTOR. SELECTION OF INDEPENDENT
- INSPECTION AND TESTING AGENCY WILL BE BY DEPARTMENTAL REPRESENTATIVE MAKE ONE STANDARD TEST FOR EACH 50 CUBIC METRES OF CONCRETE, BUT NOT LESS THAN ONE TEST FOR CONCRETE CAST EACH DAY. PROVIDE A GROUP OF THREE CONCRETE CYLINDERS FOR EACH STANDARD CONCRETE TEST IN
- ACCORDANCE WITH CSA A23.1:19 / A23.2:19. 3. PROVIDE AT LEAST 3 CYLINDERS TO BE TESTED FOR EACH AN/C20 CUBIC METRES OF MASONRY GROUT, IN

AND REPLACED WITH A PRODUCT THAT IS IN ACCORDANCE WITH THE SPECIFICATIONS.

ACCORDANCE WITH CAN/CSA-A179. MAKE AT LEAST ONE SET OF CYLINDERS EACH DAY THE GROUT IS PLACED. STRUCTURAL STEEL INSPECTION REPORTS TO INCLUDE VERIFICATION OF SPECIFIED MEMBER SIZES AND TOLERANCES AND INSPECTION OF WELDING, BOLTING AND REVIEW OF WELDERS' CWB CERTIFICATION AT THE CONTRACTORS COST,

REJECTED WORK


1. DO NOT DELIVER MATERIALS WHICH ARE KNOWN NOT TO MEET THE REQUIREMENTS OF THE SPECIFICATIONS. IF REJECTED AFTER DELIVERY, REMOVE IMMEDIATELY FROM SITE.

GENERAL NOTES



Government Services Canada Architectural and Engineering Services Ontario Region Travaux publics et Services gouvernementaux Canada Services d'architecture et de génie

Public Works and

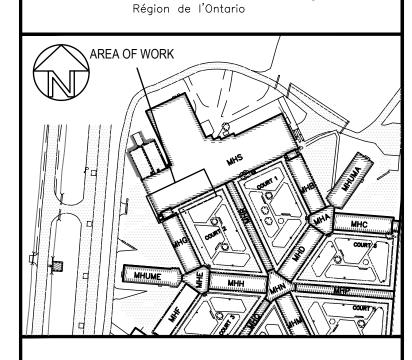

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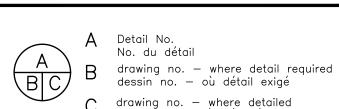




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Verify all dimensions and conditions on site and immediate

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Do not scale drawings.

MILLHAVEN INSTITUTION 5775 BATH RD. BATH, ON KOH 1GO DRY CELL RELOCATION -STRUCTURED INTERVENTION UNIT

GENERAL NOTES


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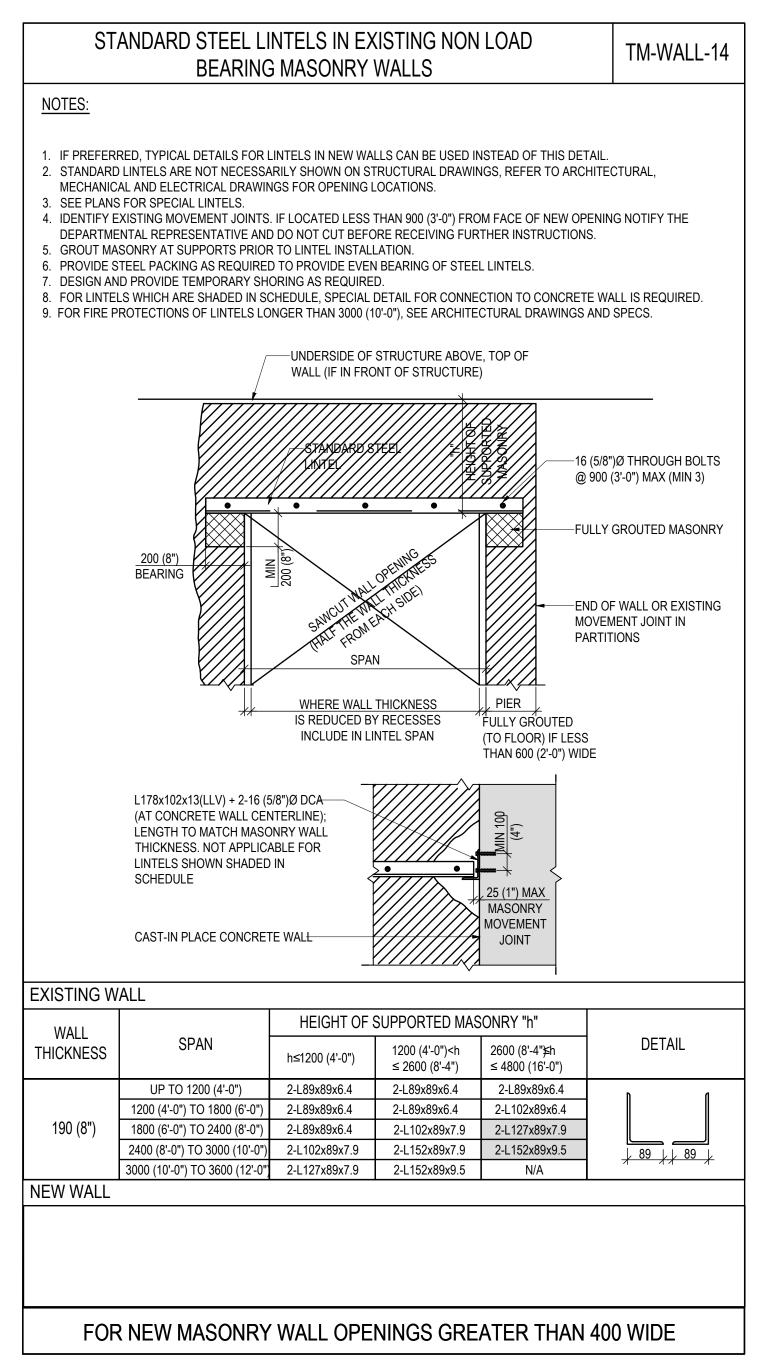
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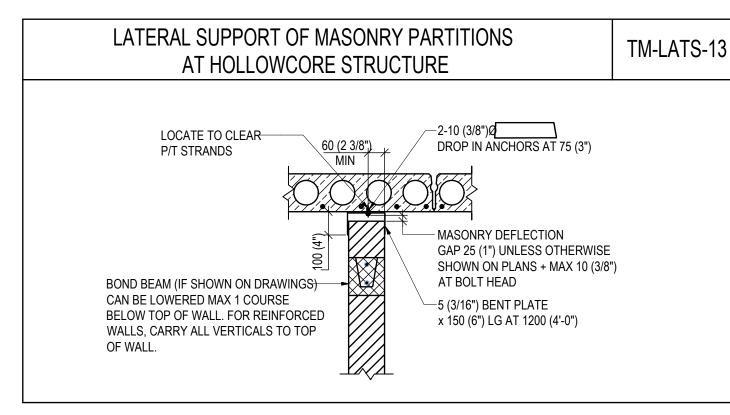
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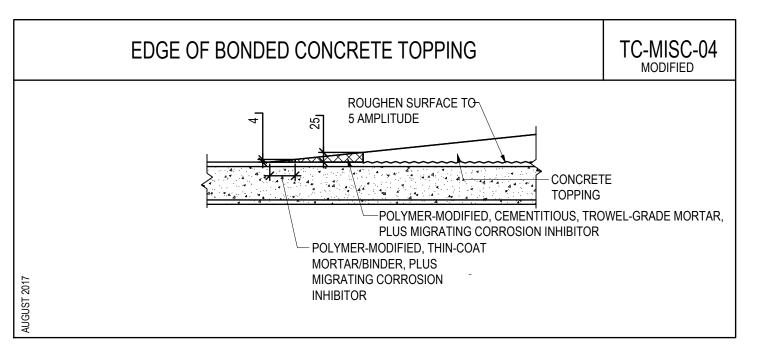
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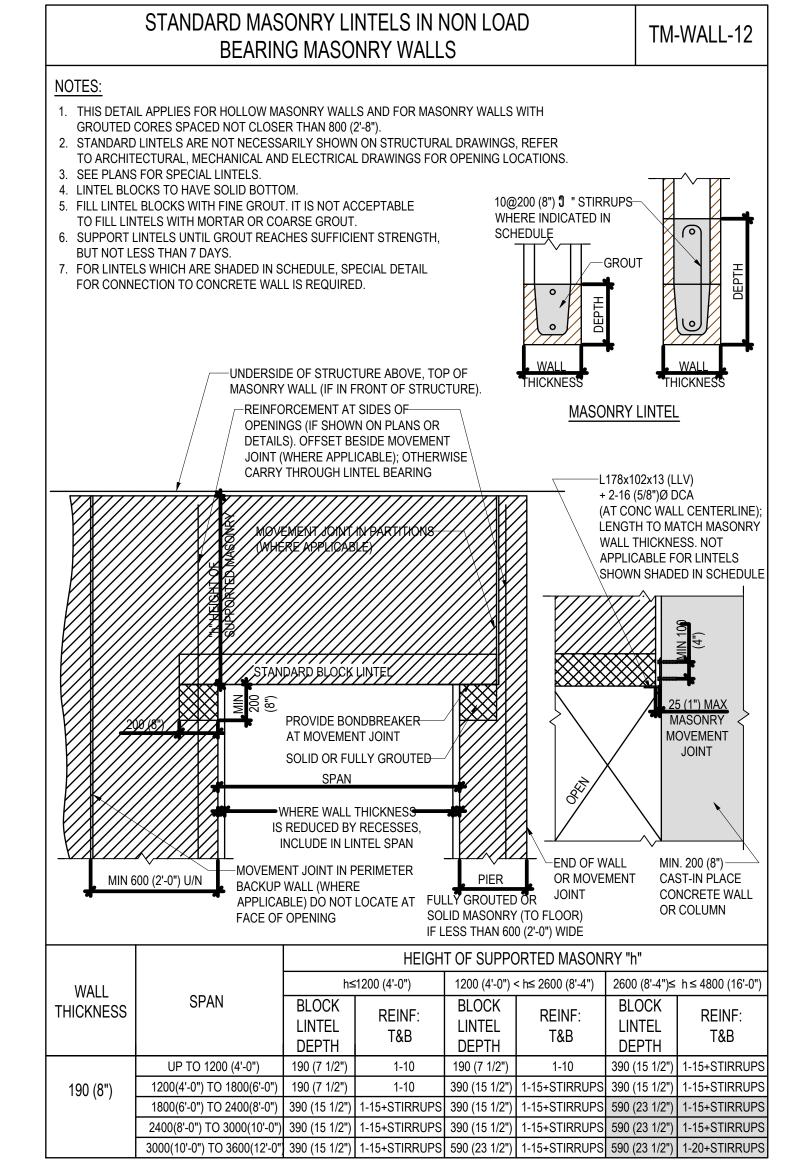
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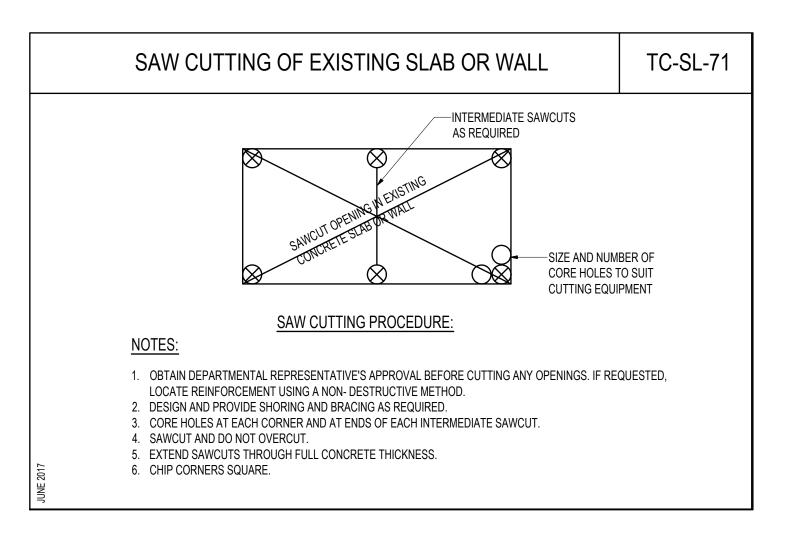












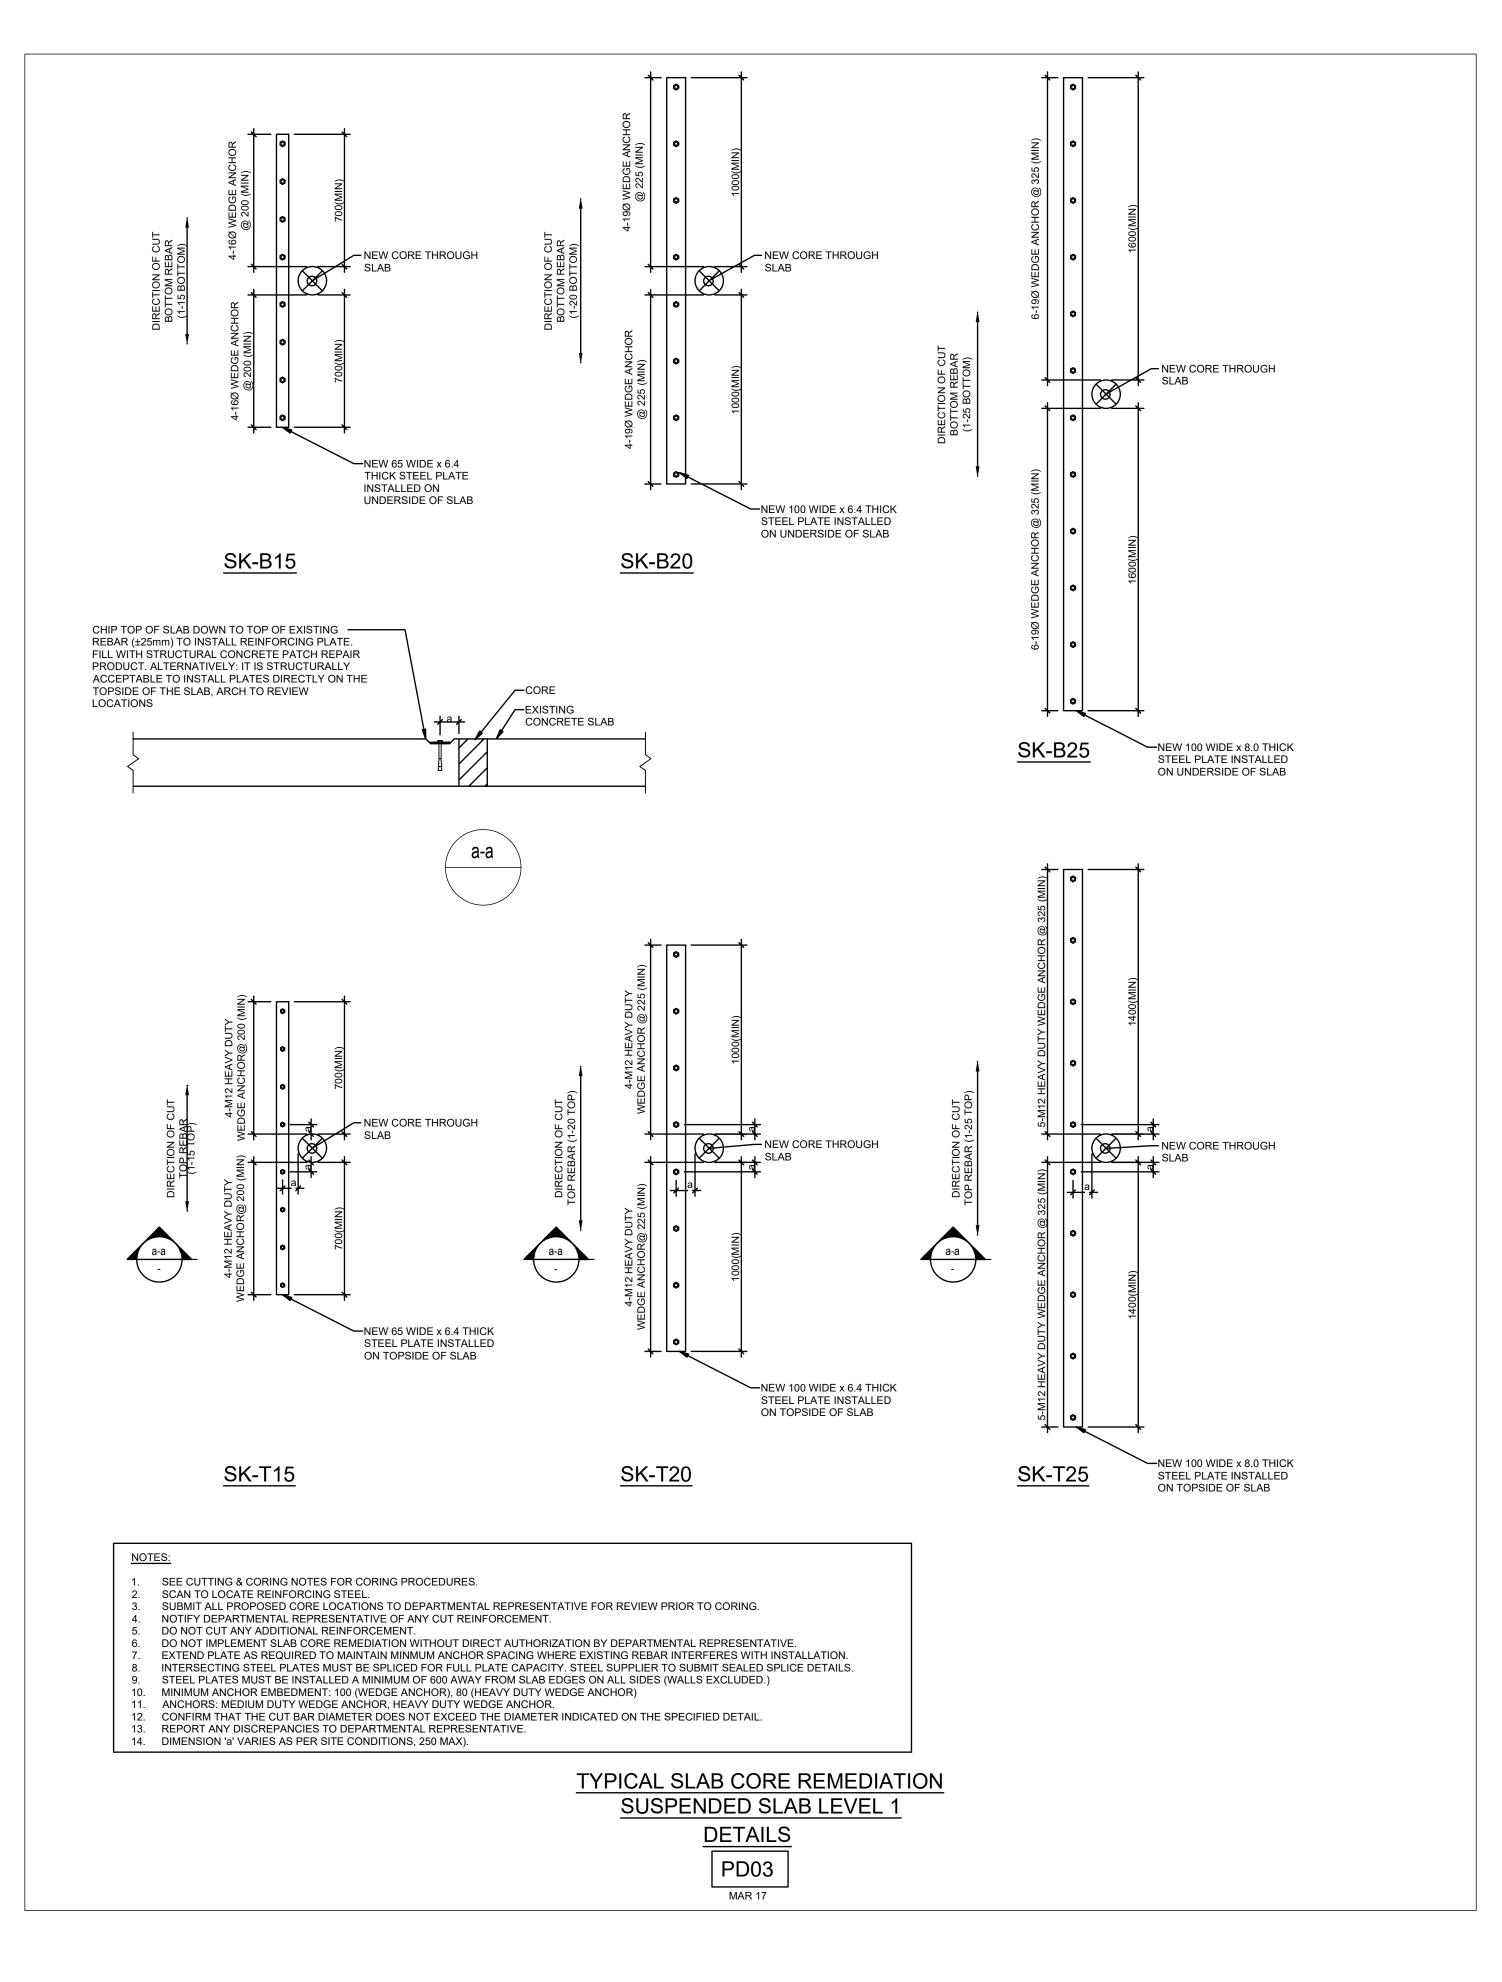

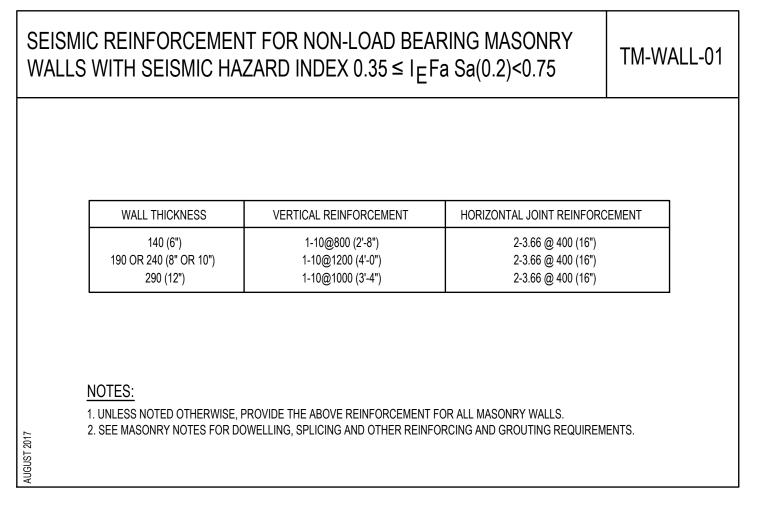


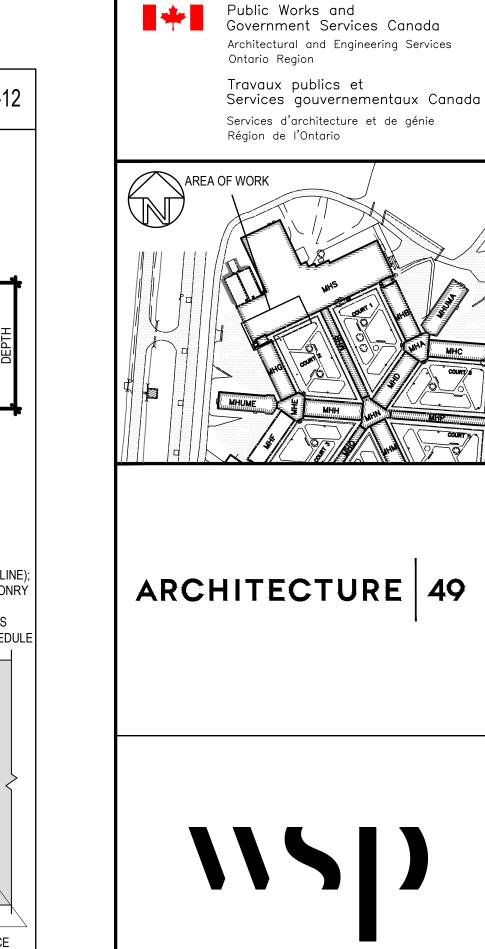



1	ISSUED FOR TENDER	2021-06-22
revision	description	date
Do not	scale drawings	

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B drawing no. - where detail required dessin no. — où détail exigé C drawing no. — where detailed dessin no. — où détaillé

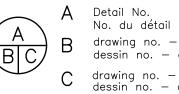project title titre du projet MILLHAVEN INSTITUTION CSC 5775 BATH RD. BATH, ON KOH 1GO DRY CELL RELOCATION -STRUCTURED INTERVENTION UNIT


drawing title titre du dessin TYPICAL DETAILS designed by conc par AC NH


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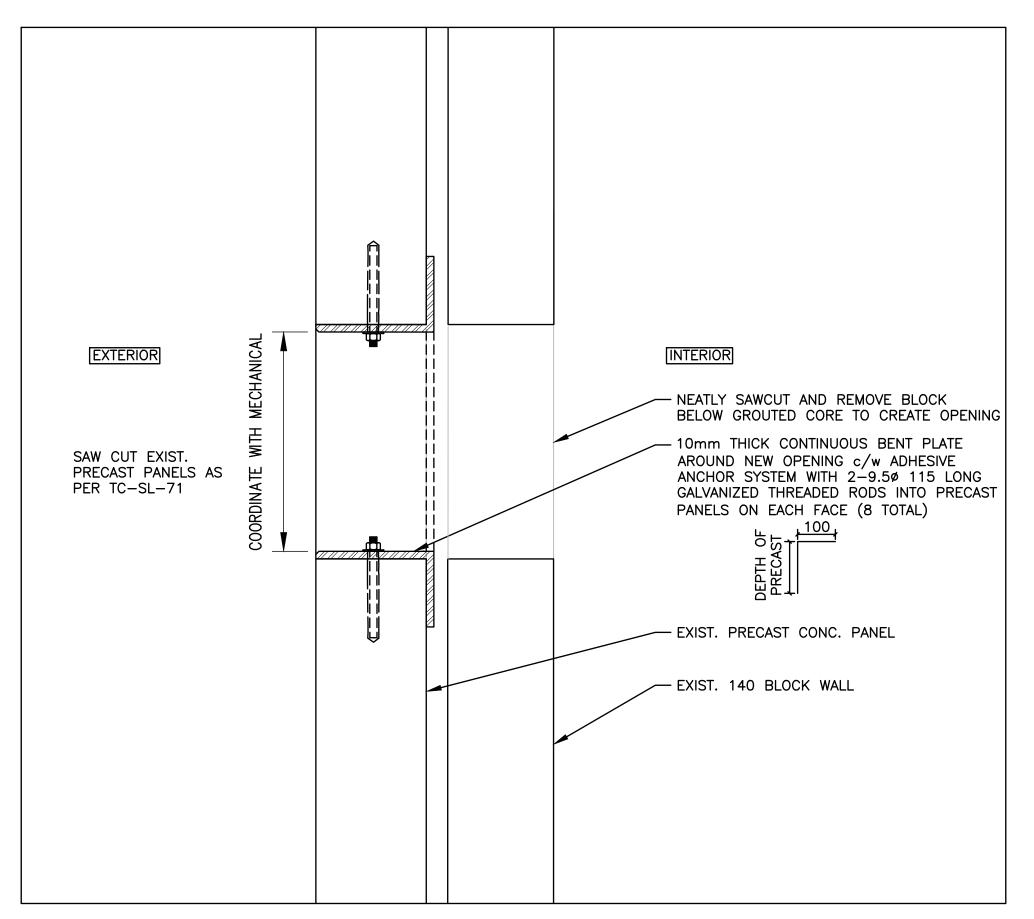
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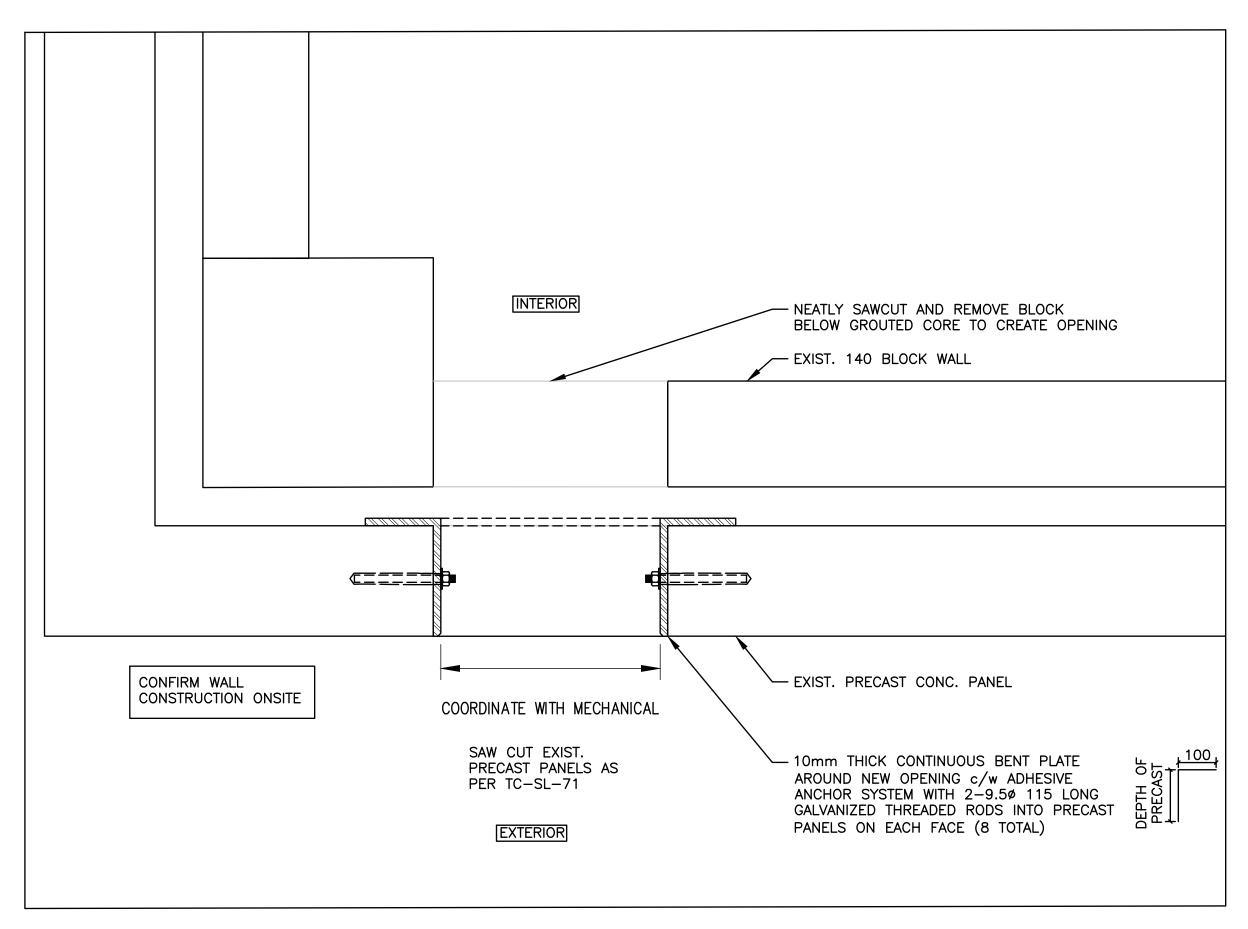
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PART GROUND FLOOR PLAN






4 MECH OPENING

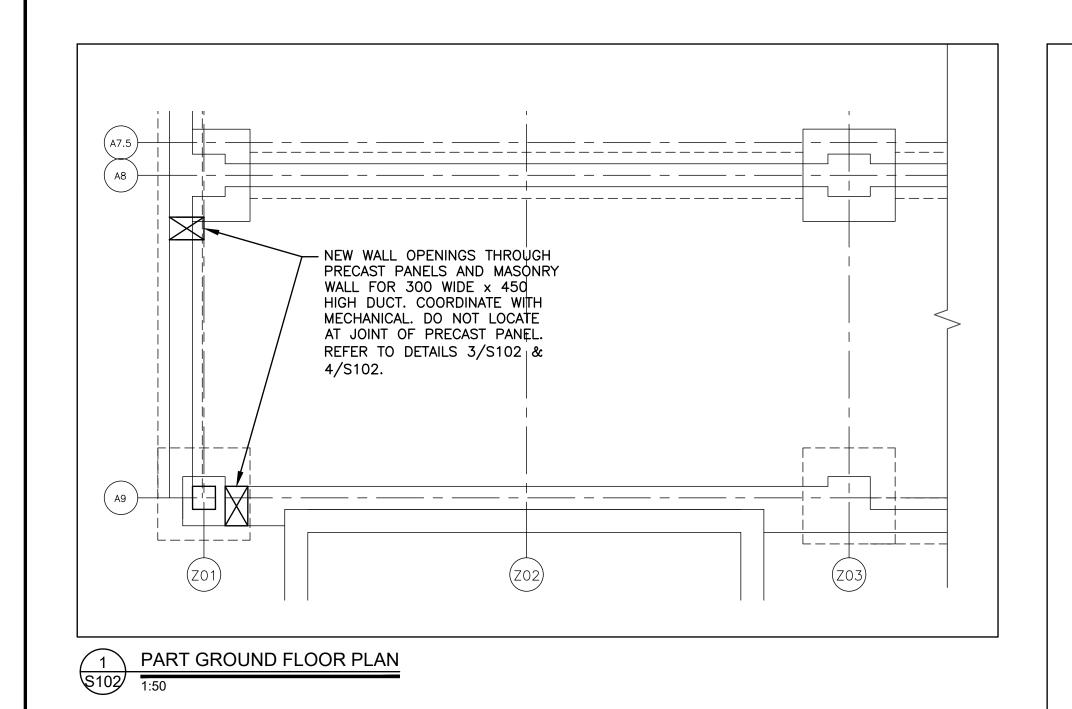Public Works and
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Architectural and Engineering Services
Ontario Region

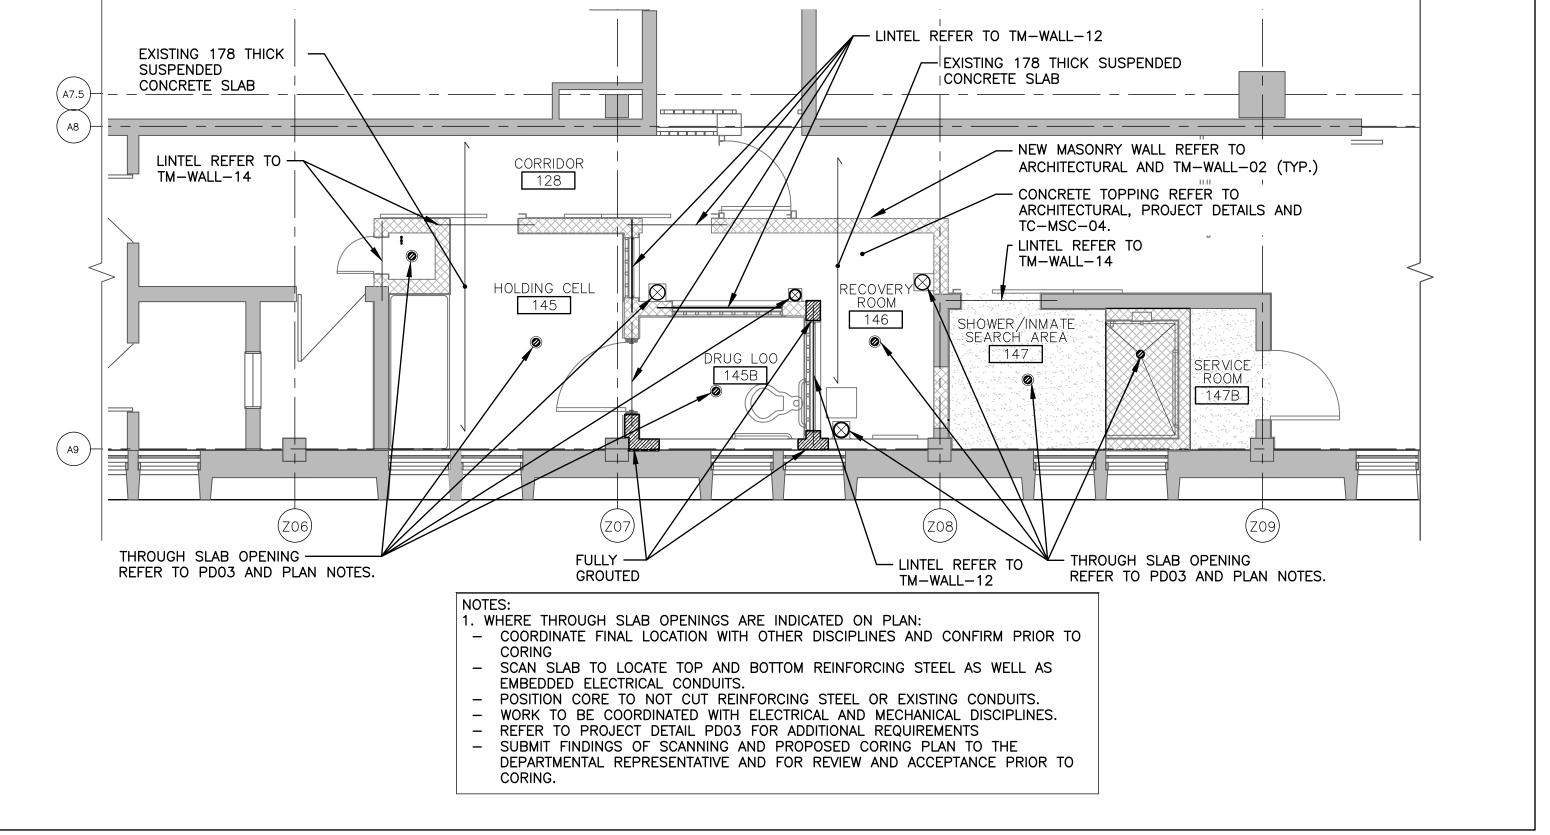Travaux publics et
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1 ISSUED FOR TENDER 2021-06-22 revision description date
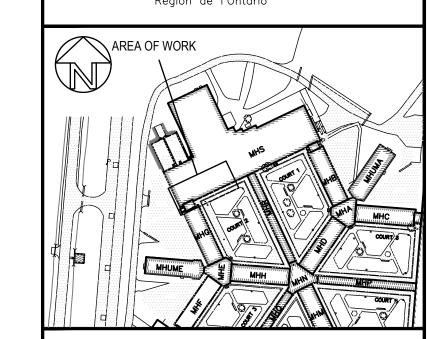
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A Detail No.
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C drawing no. — where detailed dessin no. — où détaillé

project title titre du projet

MILLHAVEN INSTITUTION CSC 5775 BATH RD. BATH, ON KOH 1GO

DRY CELL RELOCATION —

drawing title titre du dessin

PART GROUND FLOOR PLANS
& DETAILS

STRUCTURED INTERVENTION UNIT

drawn by NH

designed by conc par AC NH

approved by approuve par AC

re administr de pr

project date date date du projet 2021-02-19

project no. no. du projet R.106776.001

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MECH OPENING DETAIL

R.106776.001

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AND OTHER ASSOCIATED ITEMS FOR HVAC INDICATED TO BE

REMOVED, UNLESS OTHERWISE INDICATED. EXACT LOCATION OF


DISCONNECTION, CAPS, QUANTITIES OF DUCT TO BE REMOVED,


ETC.... TO BE DETERMINED ON SITE.

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SCALE: 1:50

project no. no. du projet


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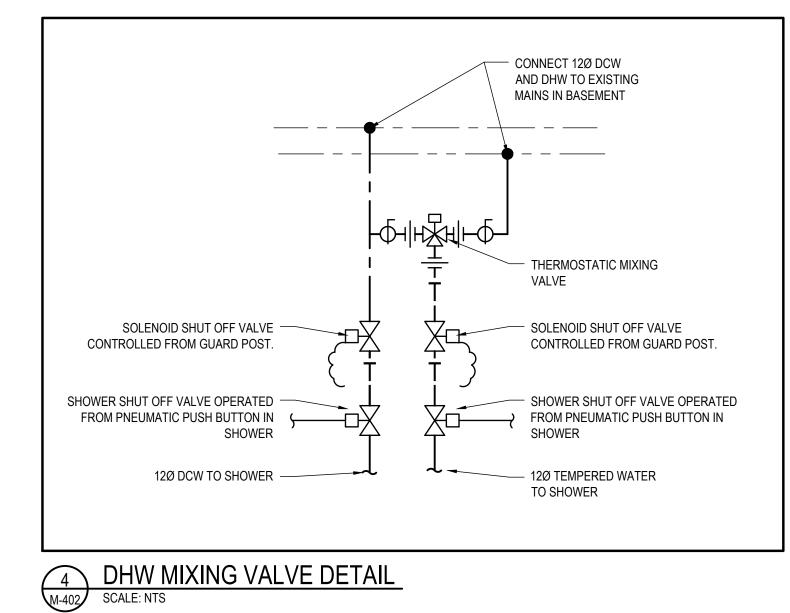
GROUND FLOOR PLUMBING LAYOUT
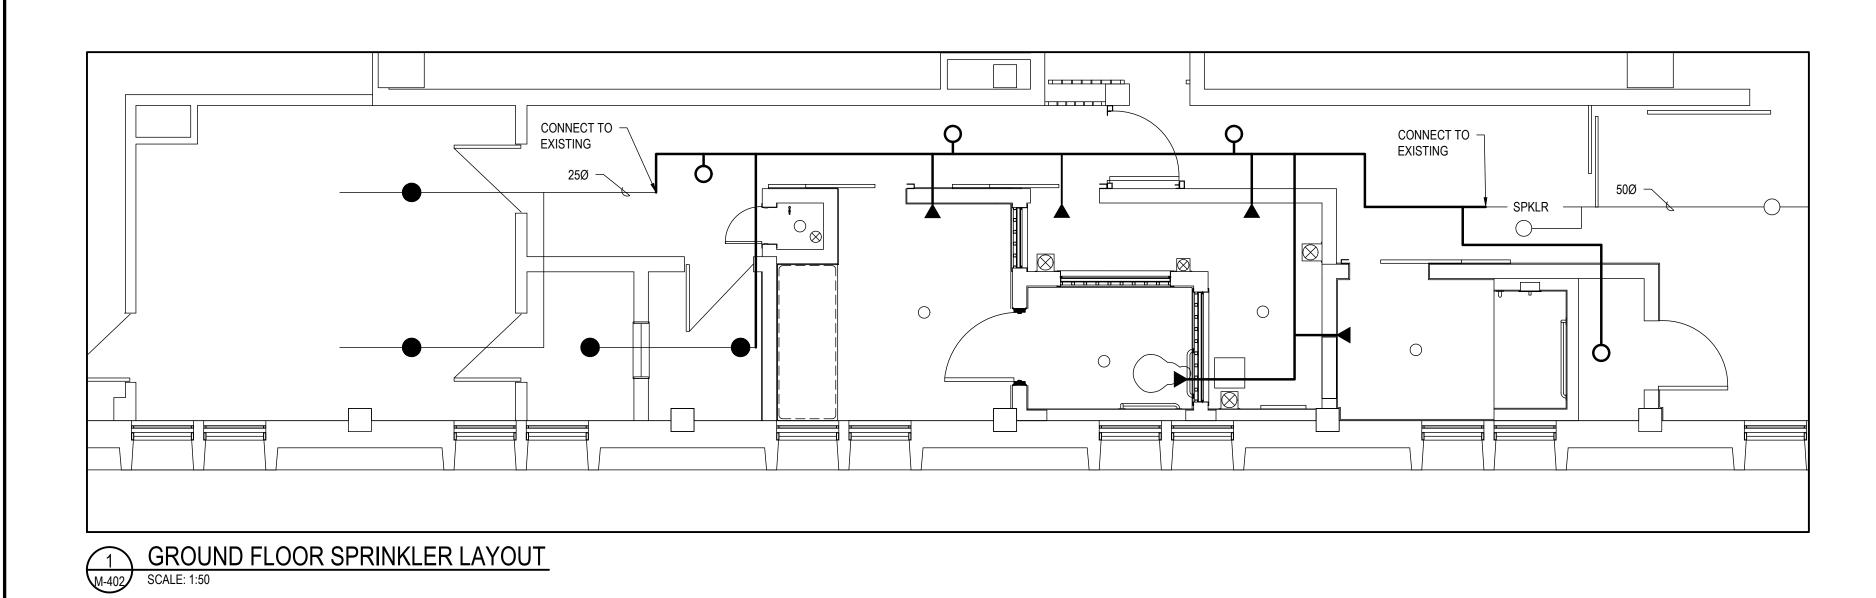
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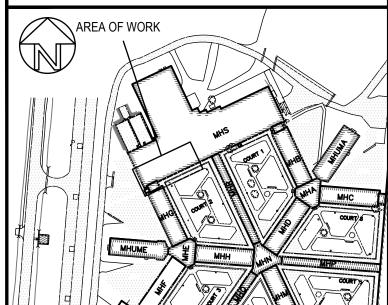


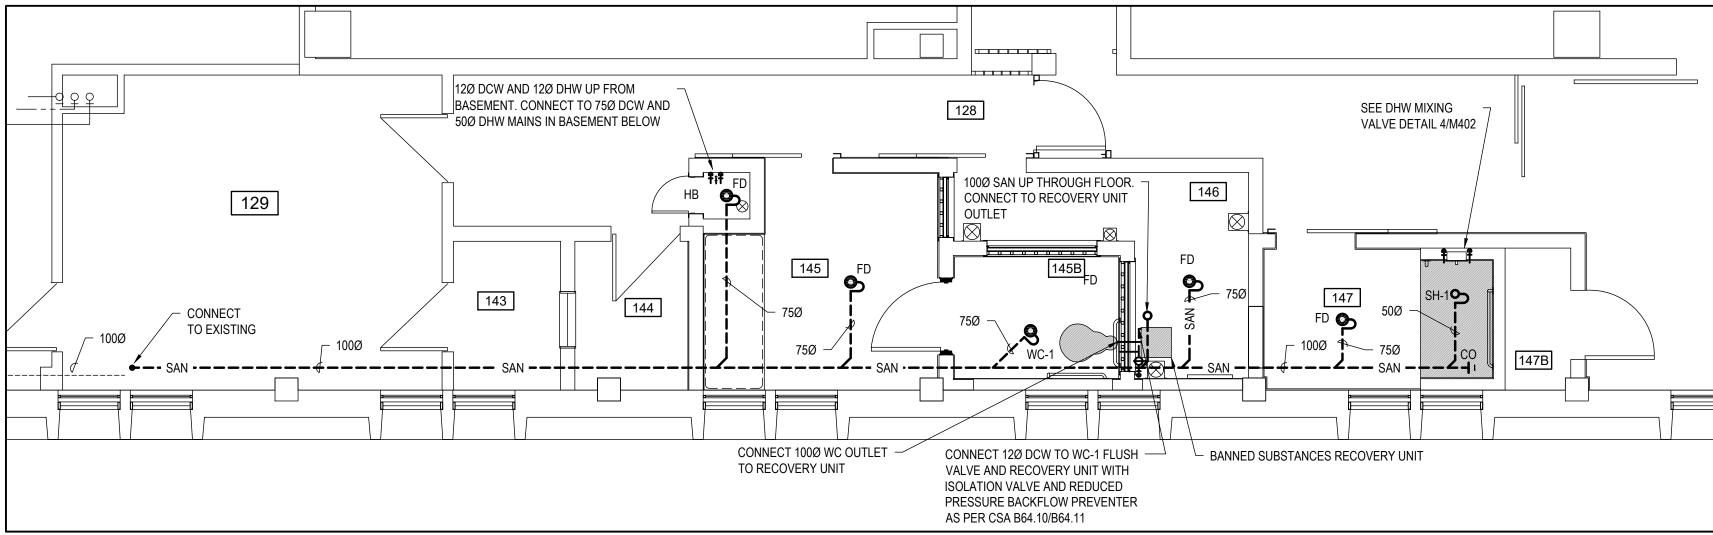BASEMENT PLUMBING LAYOUT

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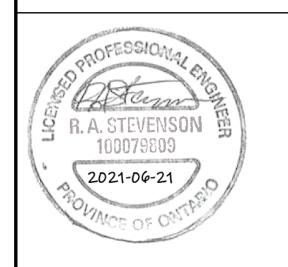


Public Works and
Government Services Canada Architectural and Engineering Services Ontario Region Travaux publics et Services gouvernementaux Canada Services d'architecture et de génie Région de l'Ontario AREA OF WORK

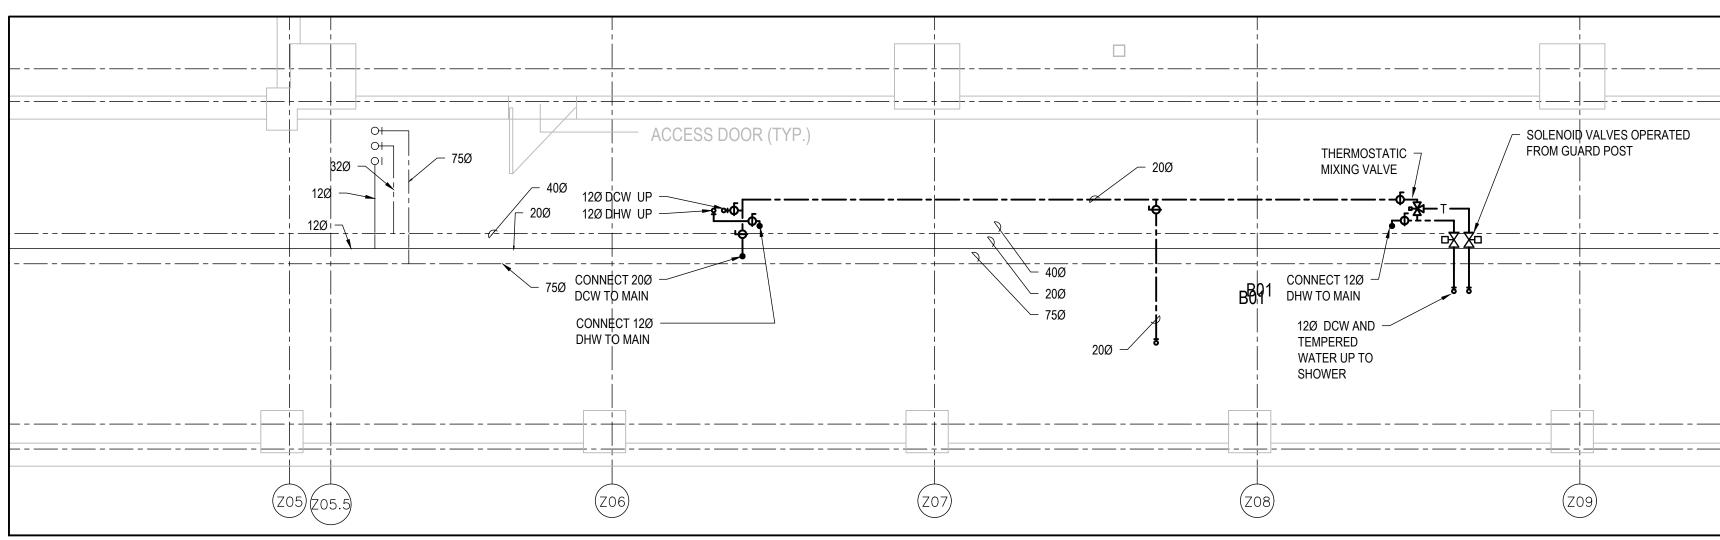


ARCHITECTURE 49





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B drawing no. - where detail required dessin no. — où détail exigé C drawing no. — where detailed dessin no. — où détaillé project title titre du projet

No. du détail

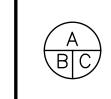MILLHAVEN INSTITUTION 5775 BATH RD. BATH, ON KOH 1GO DRY CELL RELOCATION -STRUCTURED INTERVENTION UNIT

drawing title titre du dessin

S UNITS PLUMBING AND SPRINKLER LAYOUTS

drawn by dessine par ET

designed by conc par

approuve par

project date date date du projet 2021-02-19


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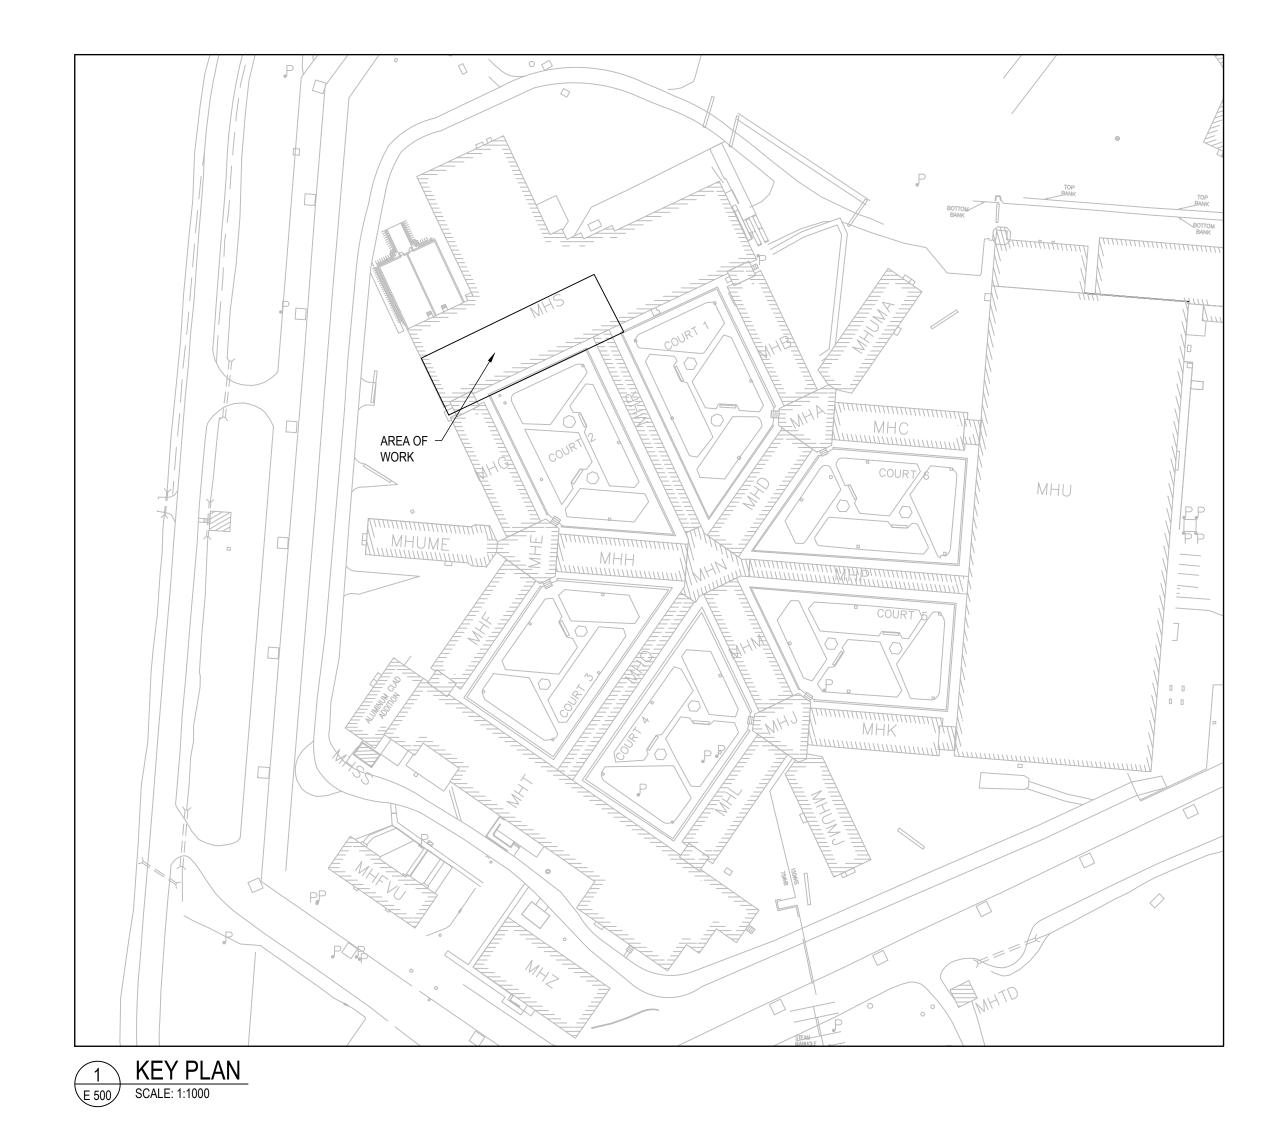
M - 402

administrateur de projets

GENERAL NOTES

- EXISTING MECHANICAL SYSTEMS SHOWN ARE DIAGRAMMATIC AND ARE BASED ON ORIGINAL DRAWINGS. THE DRAWINGS MAY NOT REPRESENT "AS-BUILT" CONDITIONS. IT IS THE RESPONSIBILITY OF THE CONTRACTOR TO VERIFY ON SITE PRIOR TO TENDER CLOSE, THE EXTENT AND CONFIGURATION OF EXISTING MECHANICAL SYSTEMS AND ALLOW FOR ADDITIONAL REMOVALS AS DETERMINED ON SITE TO MEET THE INTENT OF THE DEMOLITION INDICATED. NO EXTRAS WILL BE ALLOWED FOR FAILURE OF THE CONTRACTOR IN COMPLETING A THOROUGH REVIEW OF THE SITE PRIOR TO
- SUBMITTING CONTRACT AMOUNT. DUCTWORK SHOWN IN LOCATIONS ARE TO BE COORDINATED WITH ALL OTHER TRADES. PROVIDE COMPLETE, FULLY TESTED AND OPERATIONAL MECHANICAL SYSTEMS TO MEET THE REQUIREMENTS DESCRIBED HEREIN AND IN COMPLETE ACCORD WITH APPLICABLE CODES AND
- ORDINANCES. FOLLOW MANUFACTURERS RECOMMENDED INSTALLATION DETAILS AND PROCEDURES FOR EQUIPMENT, SUPPLEMENTED BY REQUIREMENTS OF CONTRACT DOCUMENTS.



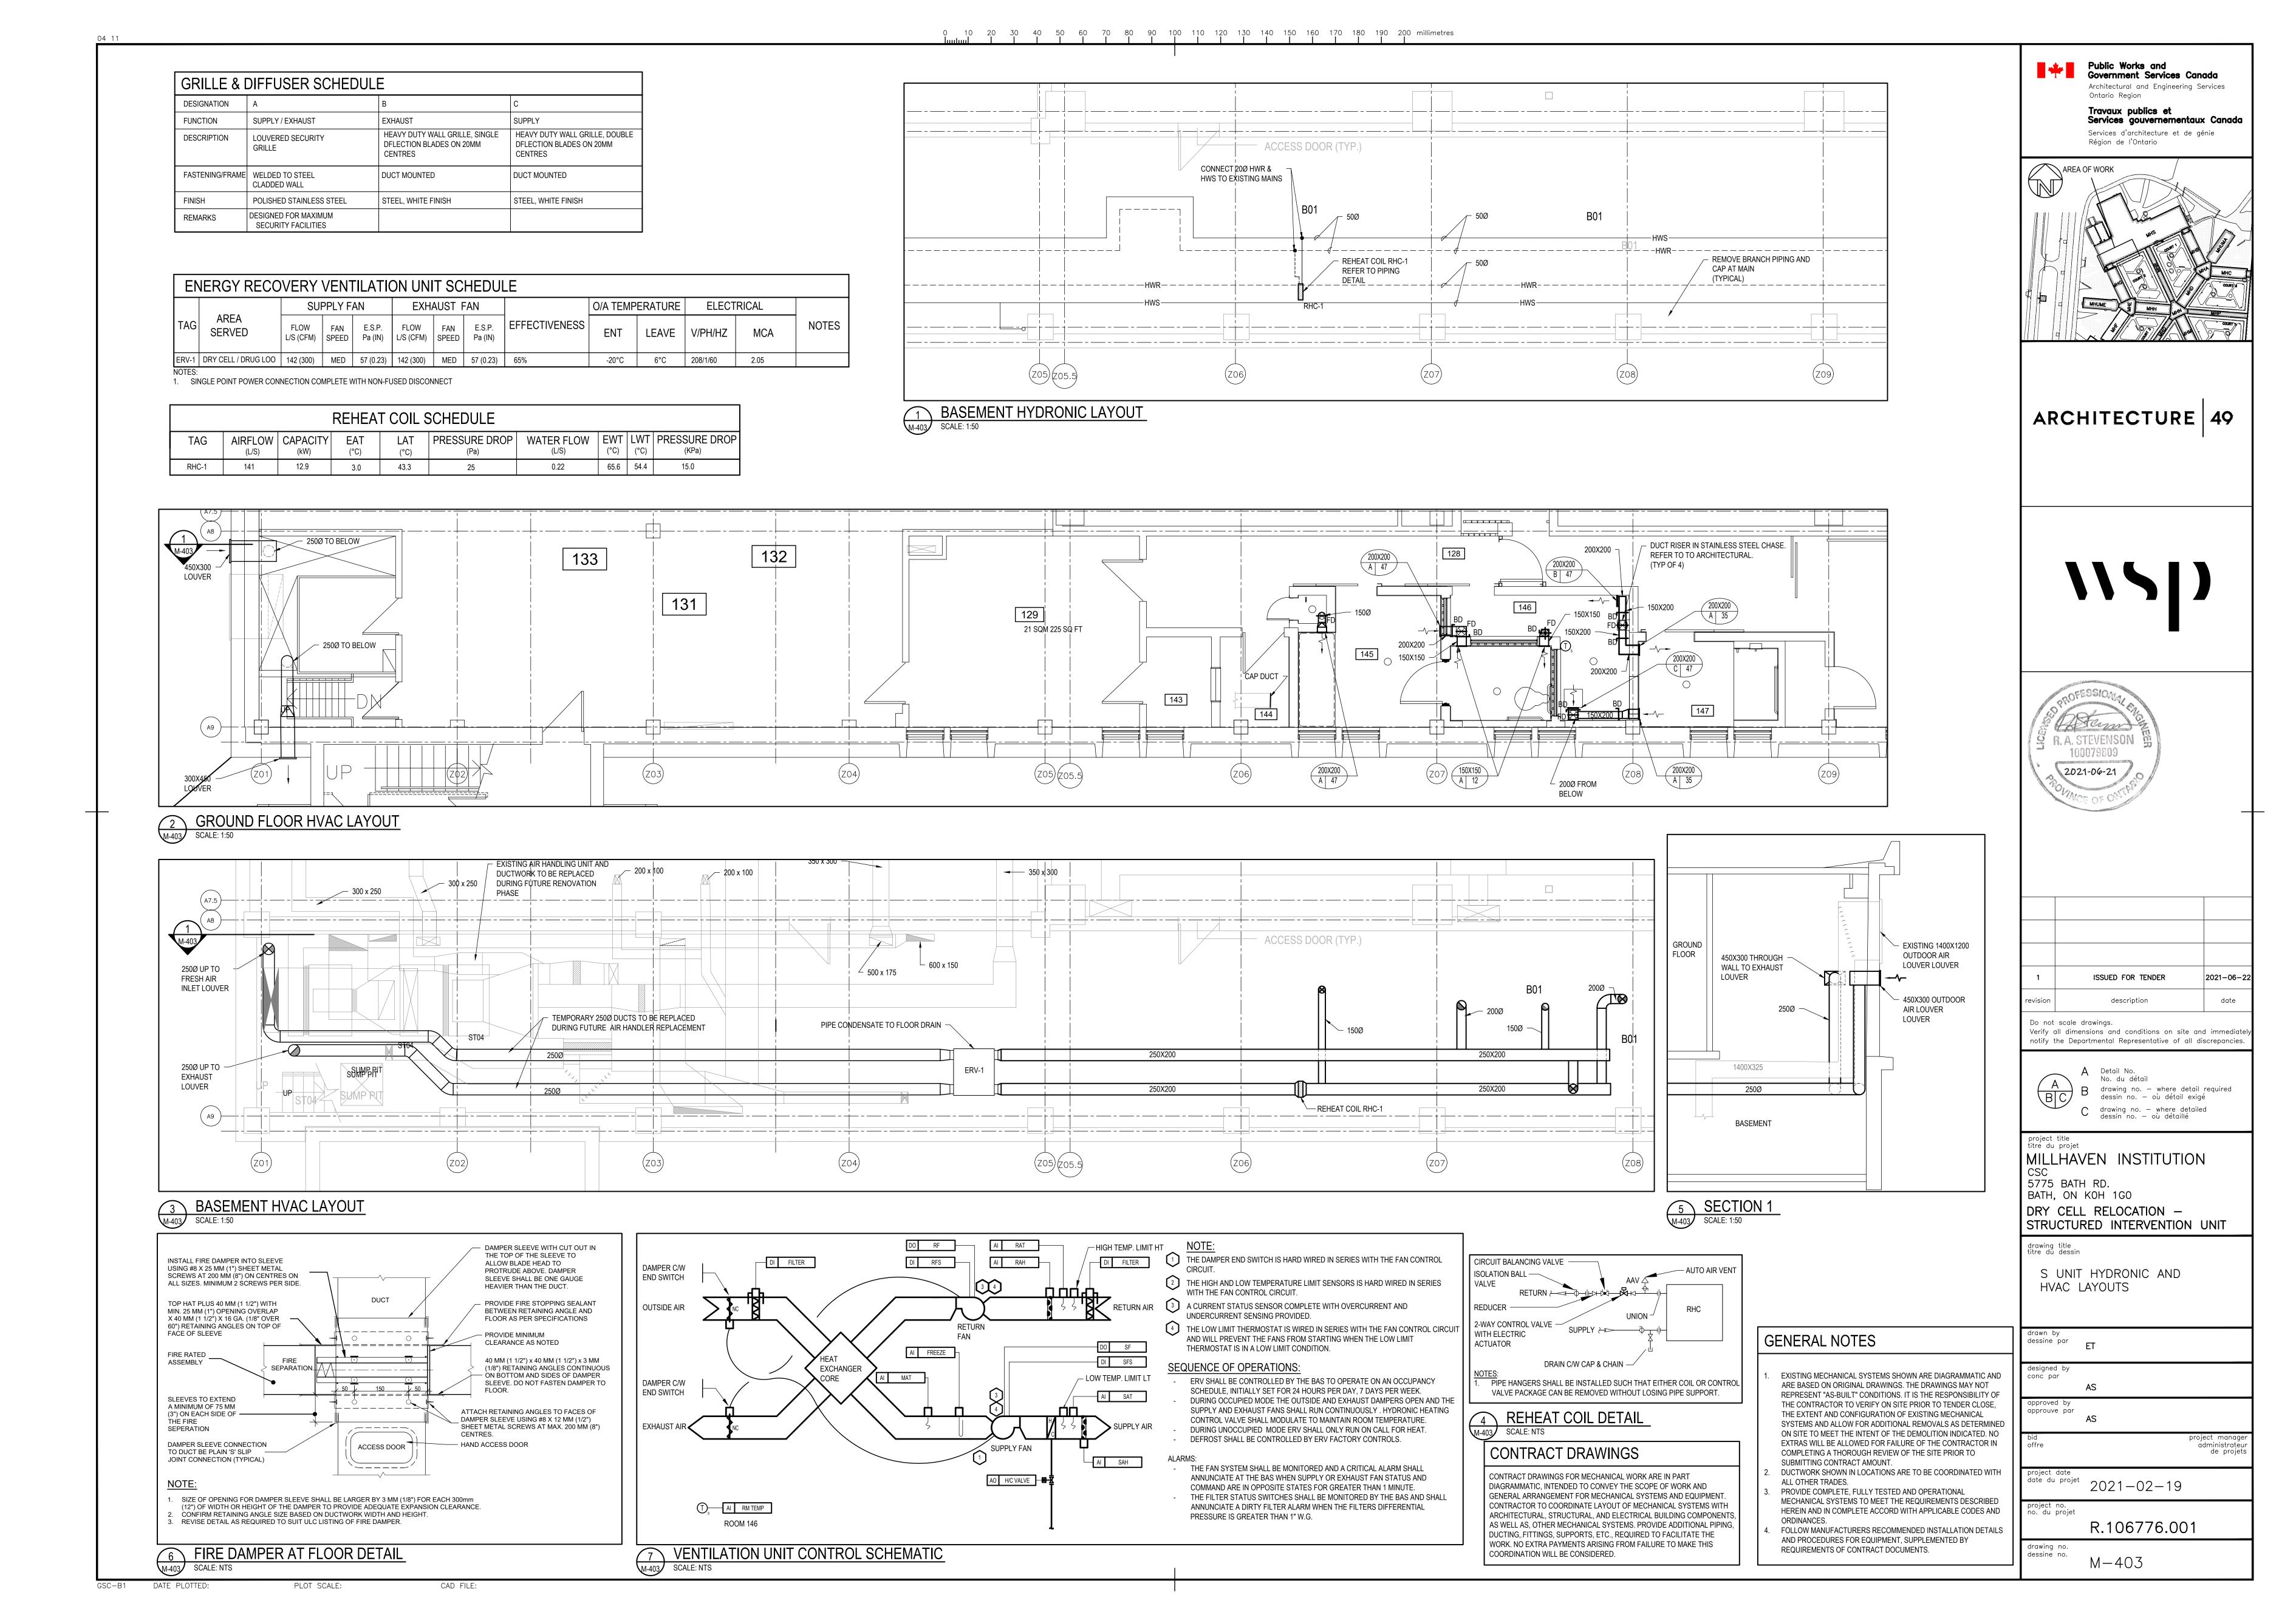

LEGENDS REMOVE 300X1200MM FIXTURE, WIRING AND CONDUIT BACK TO SOURCE UNLESS OTHERWISE NOTED L____J REMOVE TOGGLE SWITCH, BOX, WIRING AND CONDUIT REMOVE DUPLEX RECEPTACLE, BOX WIRING AND CONDUIT BACK REMOVE SMOKE DETECTOR, BOX, WIRING AND CONDUIT BACK TO SOURCE RELOCATE FIRE ALARM BELL CAMERA TO BE REMOVED AND HANDED OVER TO OWNER LIGHT TO REMAIN CAMERA CONDUIT, WIRING ETC. BY DIVISION 26 TOGGLE SWITCH 300X1200MM LED SECURITY TYPE LIGHT FIXTURE 300X1200MM LED SECURITY TYPE LIGHT FIXTURE WALL MOUNT LIGHT FIXTURE DUPLEX RECEPTACLE 15A-120V DIRECT CONNECTION TO DRUGLOO EQUIPMENT RELOCATED SMOKE DETECTOR RELOCATED FIRE ALARM BELL ELECTRIC STRIKE FOR DOOR OCCUPANCY SENSOR MOMENTARY ELECTRIC STRIKE PUSHBUTTON STATION COUNTER HEIGHT

NOTE


 ADD SMOKE DETECTOR DEVICES TO SYSTEM PROGRAM AND VERIFY ANNUNCIATION, OPERATION, ETC.

CONTRACT DRAWINGS

CONTRACT DRAWINGS FOR ELECTRICAL WORK ARE IN PART DIAGRAMMATIC, INTENDED TO CONVEY THE SCOPE OF WORK AND GENERAL ARRANGEMENT FOR EQUIPMENT, CONDUIT AND OUTLETS. CONTRACTOR TO COORDINATE LAYOUT OF ELECTRICAL SYSTEMS WITH ARCHITECTURAL, STRUCTURAL, AND MECHANICAL BUILDING COMPONENTS, AS WELL AS OTHER ELECTRICAL SYSTEMS. PROVIDE ADDITIONAL JUNCTION BOXES, FITTINGS, SUPPORTS, ETC. REQUIRED TO FACILITATE THE WORK. NO EXTRA PAYMENTS ARISING FROM FAILURE TO MAKE THIS COORDINATION WILL BE CONSIDERED.

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A Detail No.
No. du détail
B drawing no. — where detail required dessin no. — où détail exigé
C drawing no. — where detailed dessin no. — où détaillé

project title
titre du projet

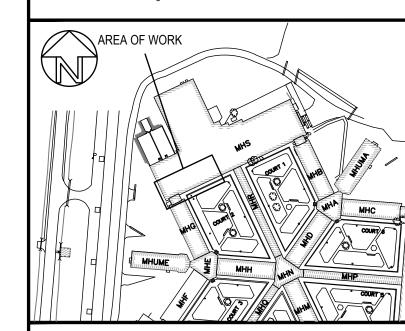MILLHAVEN INSTITUTION
CSC
5775 BATH RD.
BATH, ON KOH 1GO
DRY CELL RELOCATION —
STRUCTURED INTERVENTION UNIT

drawing title titre du dessin

KEY PLAN AND LEGEND

drawn by dessine par **OK**

designed by conc par GL/OK

approved by approuve par


bid

project date date date du projet 2021-02-19

project no.

R.106776.001

drawing no. dessine no. E-500

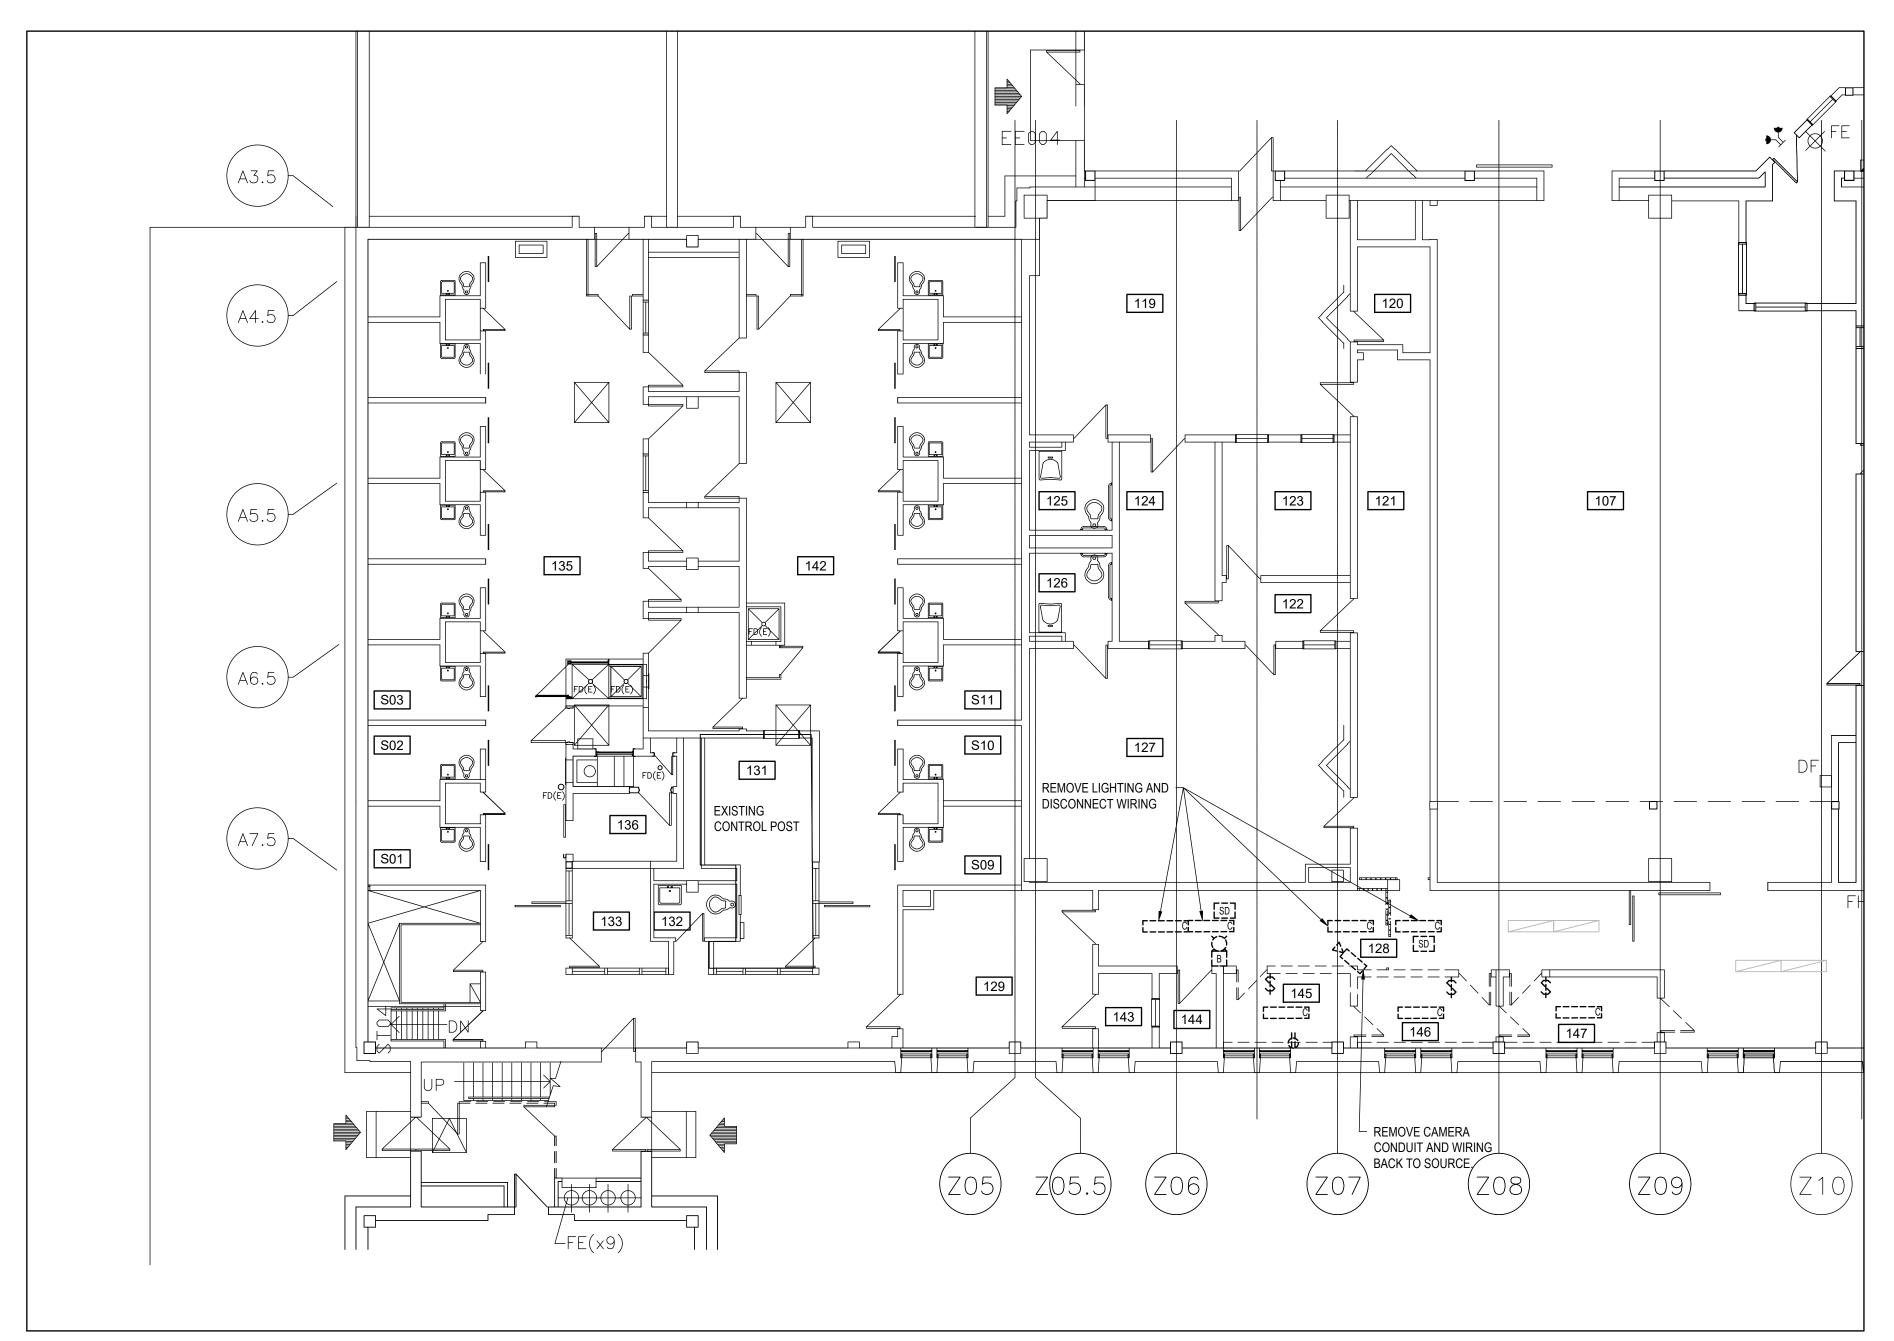

1 ELECTRICAL DEMO
SCALE: 1:100


CONTRACT DRAWINGS

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Région de l'Ontario



ARCHITECTURE 49



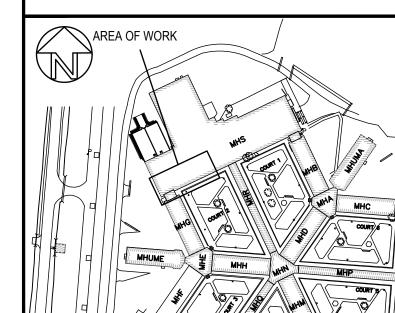

1	ISSUED FOR TENDER	2021-06-
revision	description	date

Do not scale drawings.

Verify all dimensions and conditions on site and immediately notify the Departmental Representative of all discrepancies.



No. du détail

B drawing no. — where detail required dessin no. — où détail exigé

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project title
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MILLHAVEN INSTITUTION

CSC
5775 BATH RD.
BATH, ON KOH 1GO

DRY CELL RELOCATION —
STRUCTURED INTERVENTION UNIT

drawing title titre du dessin

DEMOLITION

DRY CELL

drawn by
dessine par OK

designed by
conc par

GL/OK

approved by
approuve par

NM


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project date date date du projet 2021-02-19

R.106776.001

E-501

1 LIGHTING LAYOUT SCALE: 1:100

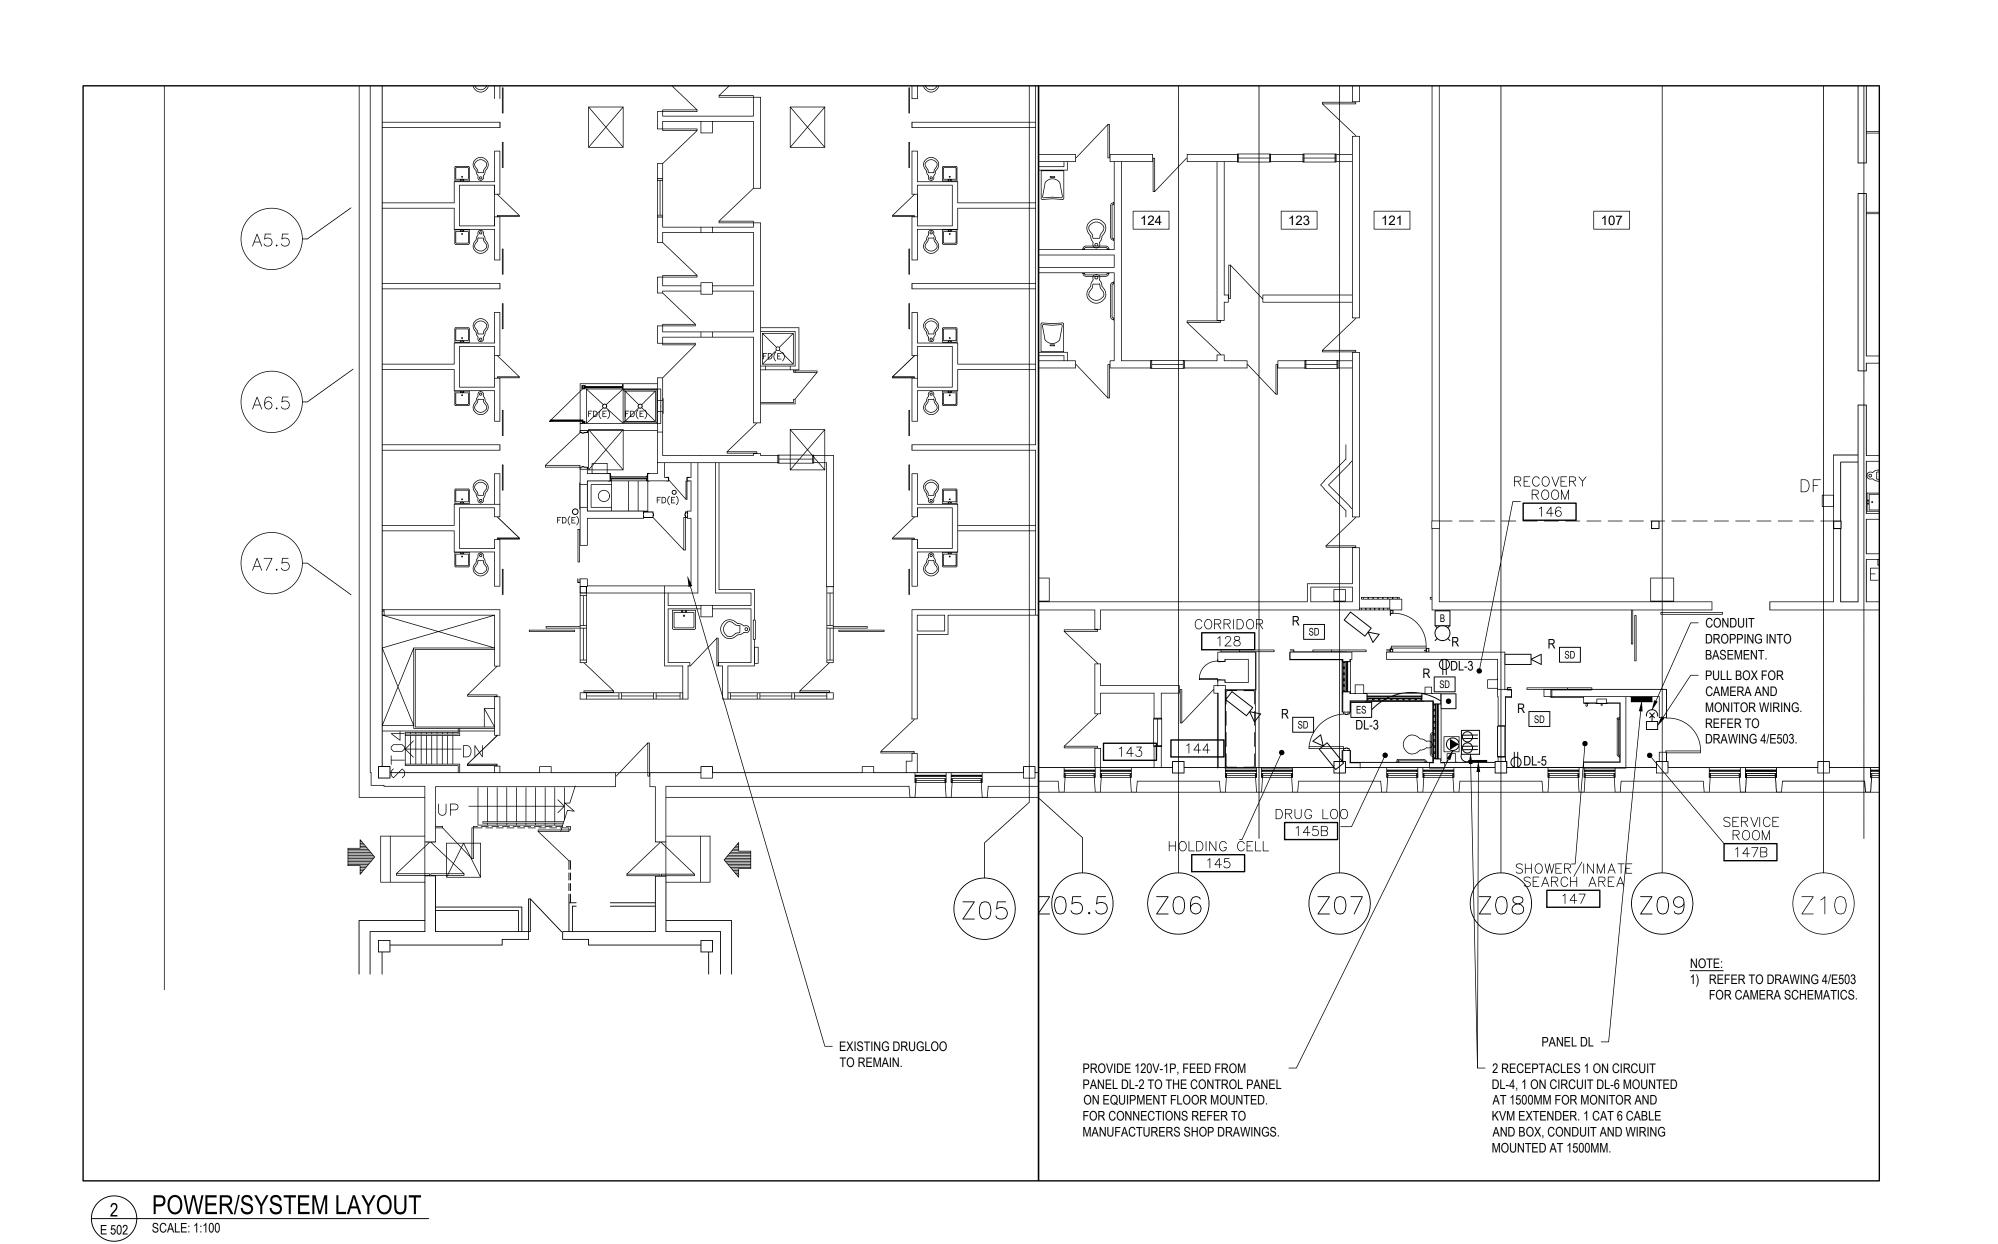


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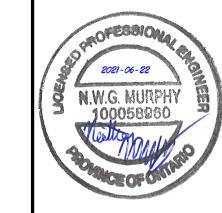
Public Works and
Government Services Canada
Architectural and Engineering Services
Ontario Region

Travaux publics et
Services gouvernementaux Canada



ARCHITECTURE 49

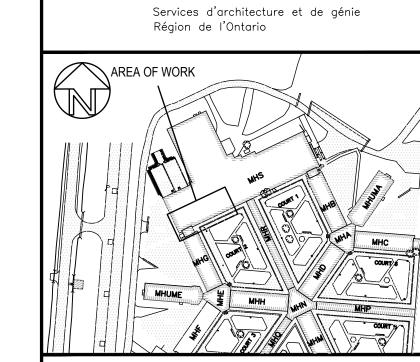



1 ISSUED FOR TENDER 2021-06-22
sion description date

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A Detail No.
No. du détail
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drawing no. — where detailed dessin no. — où détaillé

project title titre du projet

MILLHAVEN INSTITUTION
CSC
5775 BATH RD.
BATH, ON KOH 1GO
DRY CELL RELOCATION —
STRUCTURED INTERVENTION UNIT

drawing title titre du dessin

DRY CELL LIGHTING AND POWER/SYSTEM LAYOUT

drawn by dessine par **OK**

designed by conc par

GL/OK


approved by approuve par NM

project adm

project date date date date du projet 2021-02-19

project no.
no. du projet

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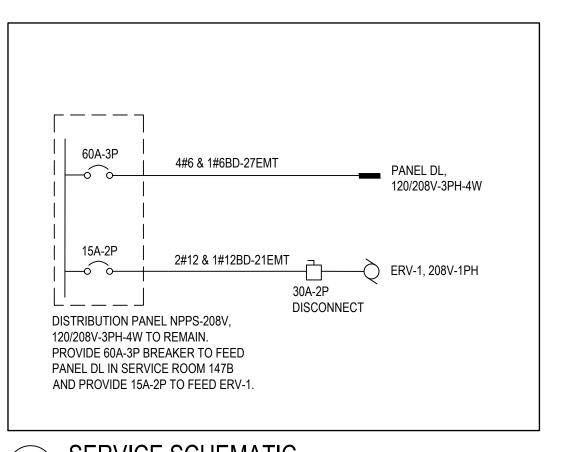


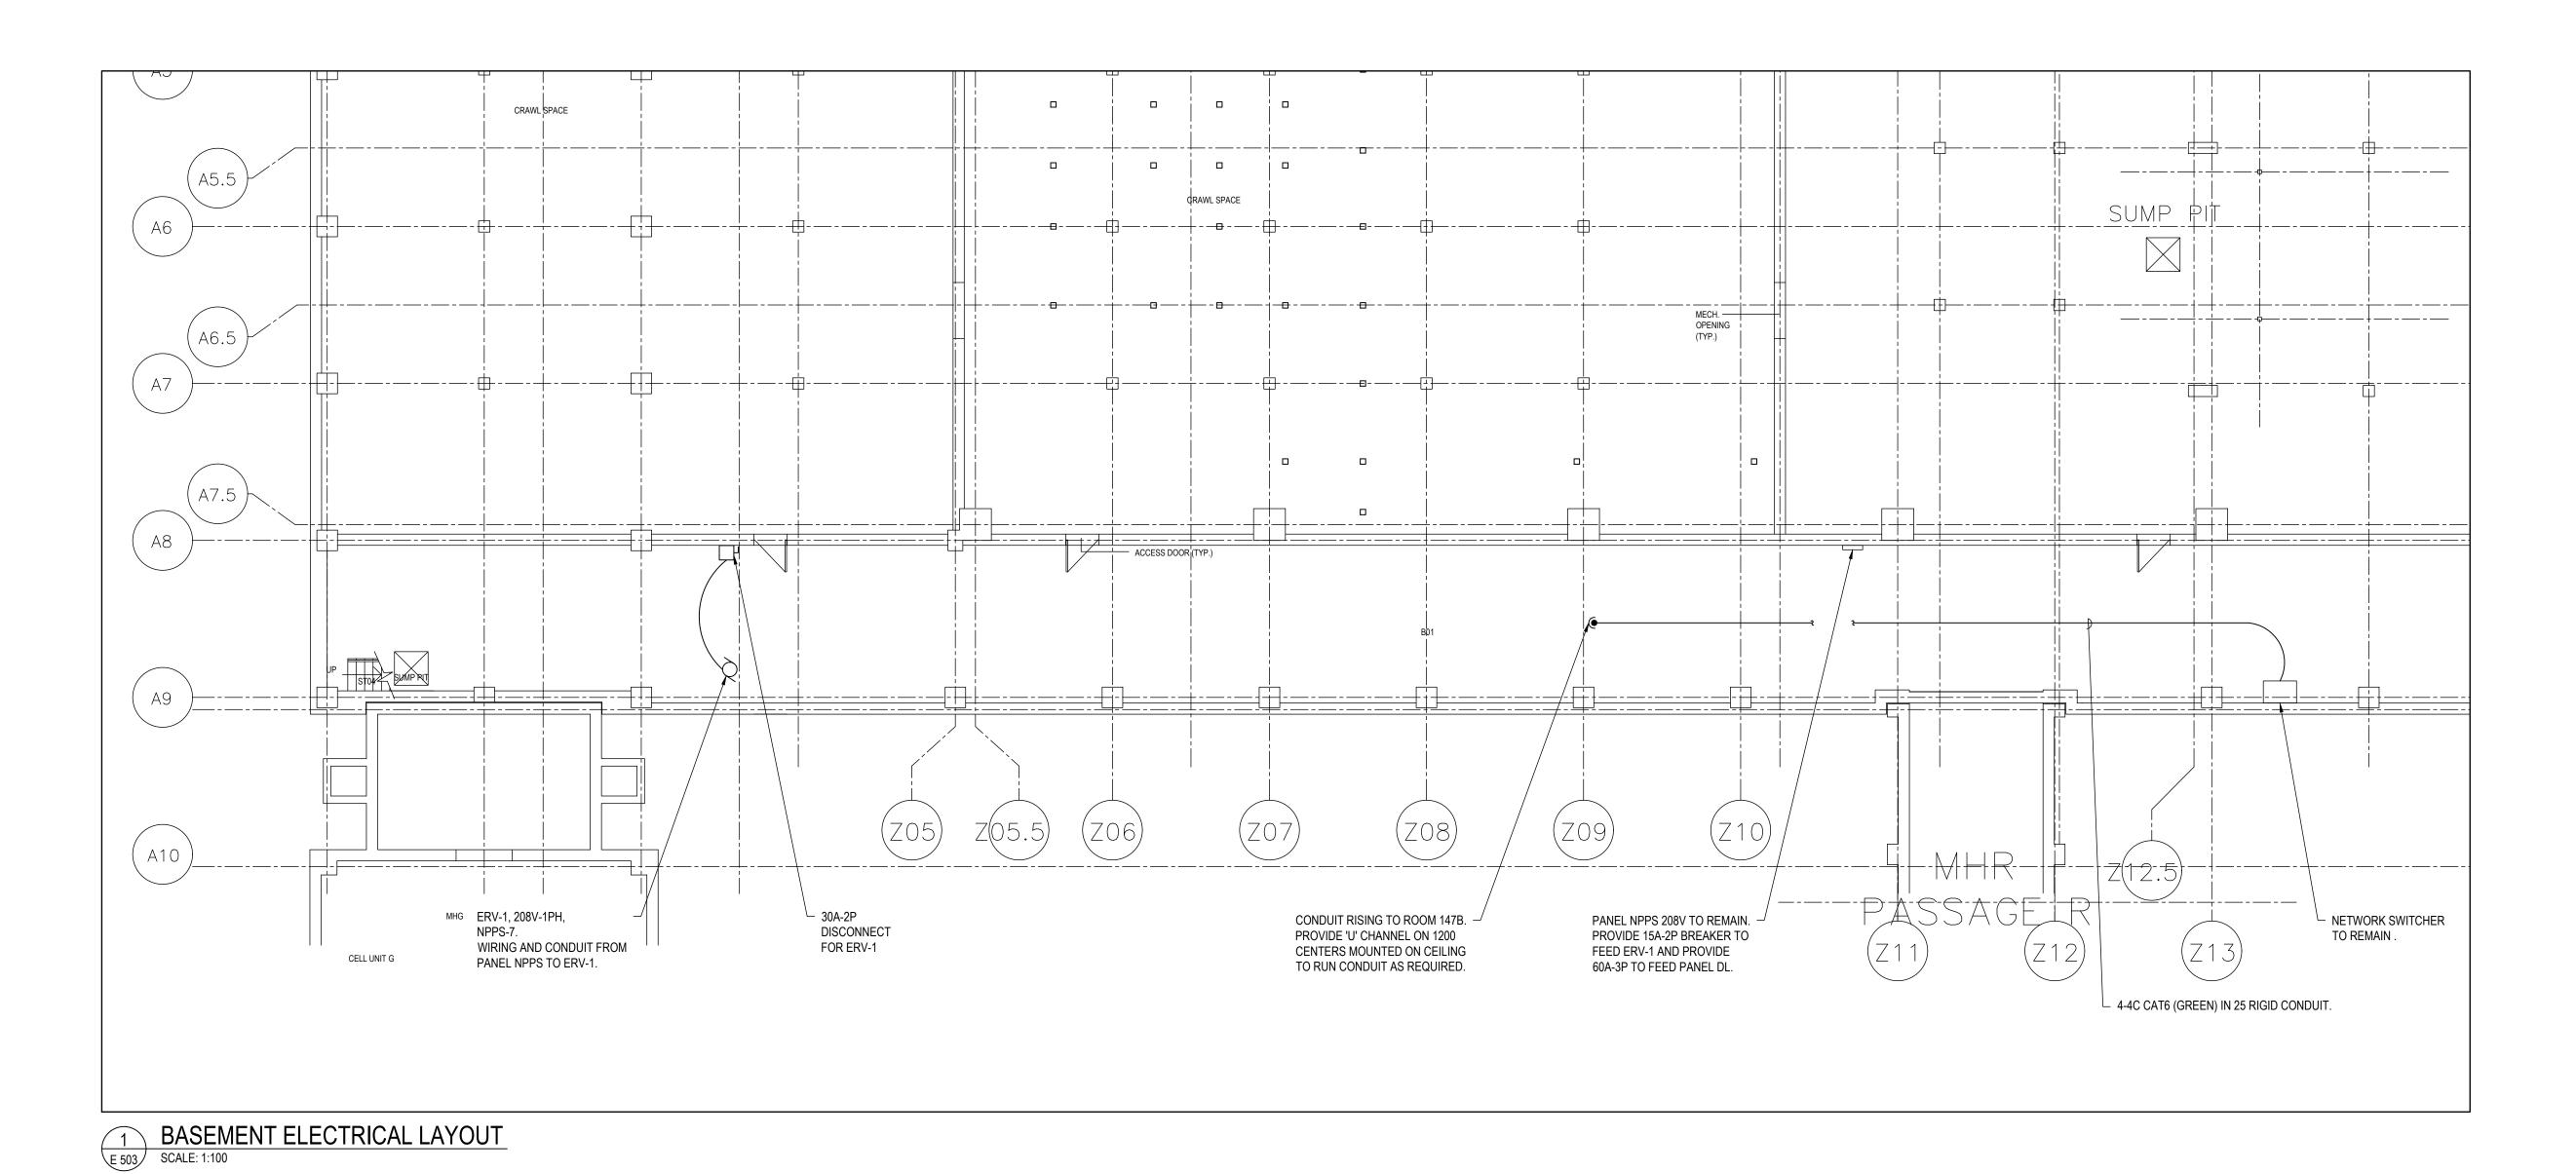BKR CCT CCT BKR LEG KW KW LEG DESCRIPTION DESCRIPTION .3 L LIGHTING 15 1 2 15 DRUGLOO CONTROL PANEL .5 P RECOVERY ROOM REC, ES & PB 15 3 4 15 RECEPTACLE MONITOR * 15 5 6 15 RECEPTACLE KVM


15 7 8 15 SPARE .4 P SHOWER INMATE/SEARCH ROOM REC
 15
 9
 10
 15
 SPARE

 11
 12
 SPACE
 SPARE SPACE 13 14 SPACE SPACE 15 16 SPACE SPACE 17 18 SPACE SPACE 19 20 SPACE SPACE SHORT CIRCUIT RATING: 10 KAIC TYPE: SURFACE MOUNT MAINS RATING: 100 A MAIN BREAKER C/W BARRIER: N/A VOLTAGE RATING: 120/208V 3PH 4W P-POWER, H-HEATING, L-LIGHTING, M-MOTOR, *-GFCI BKR

PANEL SCHEDULE DL SCALE: N.T.S




3 SERVICE SCHEMATIC E 503 SCALE: N.T.S

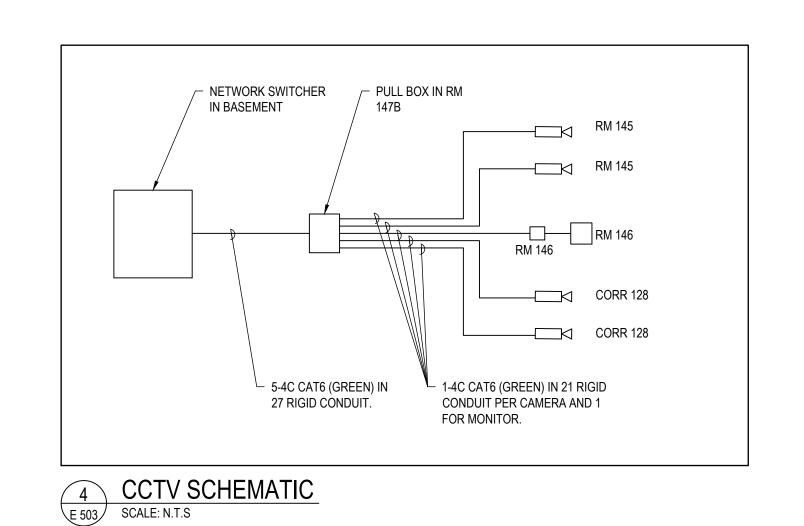

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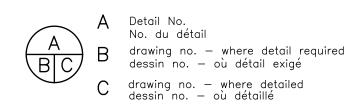
ARCHITECTURE 49



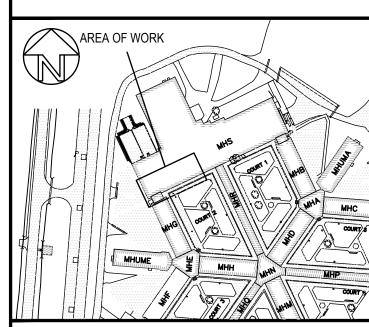

1	ISSUED FOR TENDER	2021-06-
revision	description	date
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project title titre du projet MILLHAVEN INSTITUTION 5775 BATH RD. BATH, ON KOH 1GO DRY CELL RELOCATION -

STRUCTURED INTERVENTION UNIT drawing title titre du dessin

ELECTRICAL BASEMENT LAYOUT PANEL SCHEDULE, SERVICE AND CCTV SCHEMATICS

drawn by dessine par **OK** designed by conc par GL/OK approved by approuve par project manager administrateur de projets

project date date du projet 2021-02-19

project no. no. du projet R.106776.001

drawing no. dessine no.

E - 503