NEW RESIDENCE

NEW AIYANSH, BC







REAL PROPERTY SERVICES

Pacific Region SERVICES IMMOBILIERS





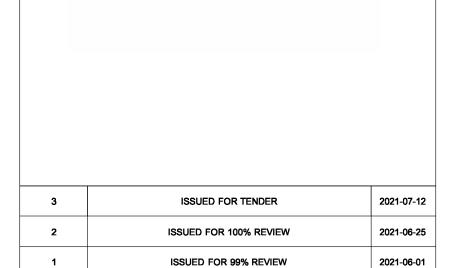

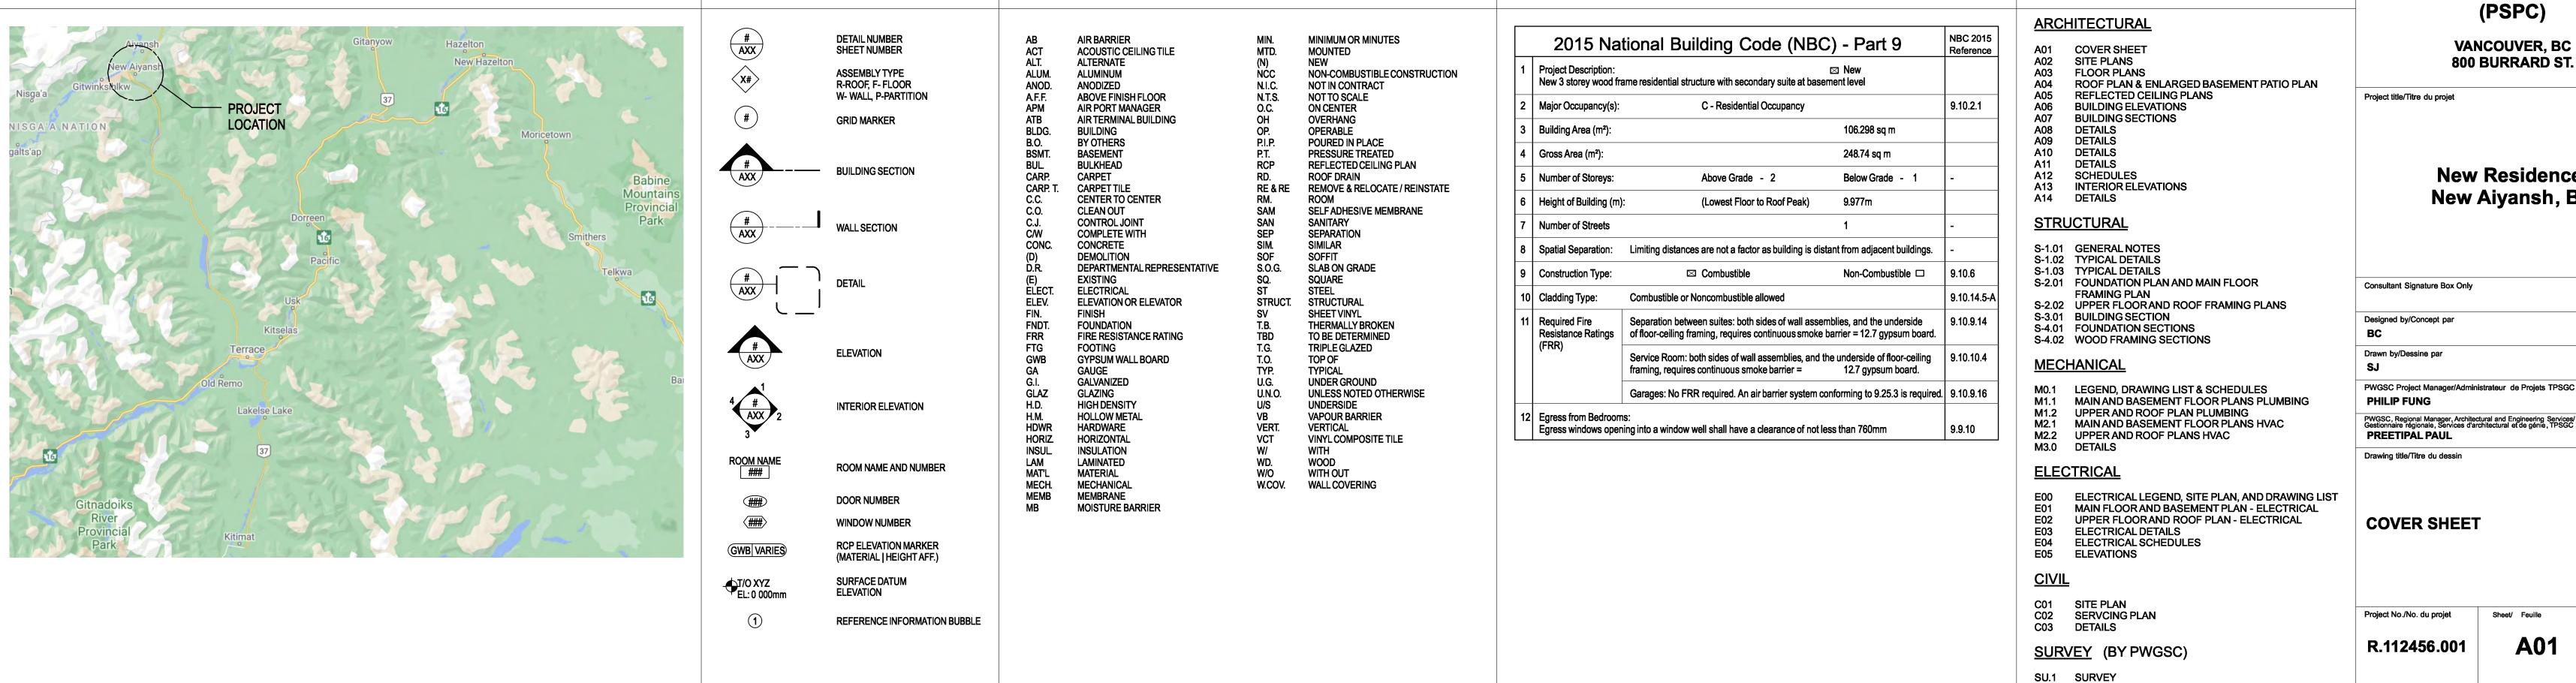

CODE REVIEW

ABBREVIATIONS

Description/Description **Public Services and Procurement Canada**

ISSUED FOR 66% REVIEW

2021-05-03

VANCOUVER, BC

DRAWING LIST


New Residence, New Aiyansh, BC


PWGSC, Regional Manager, Architectural and Engineering Services/ Gestionnaire régionale, Services d'architectural et de génie, TPSGC


A01

LEGEND




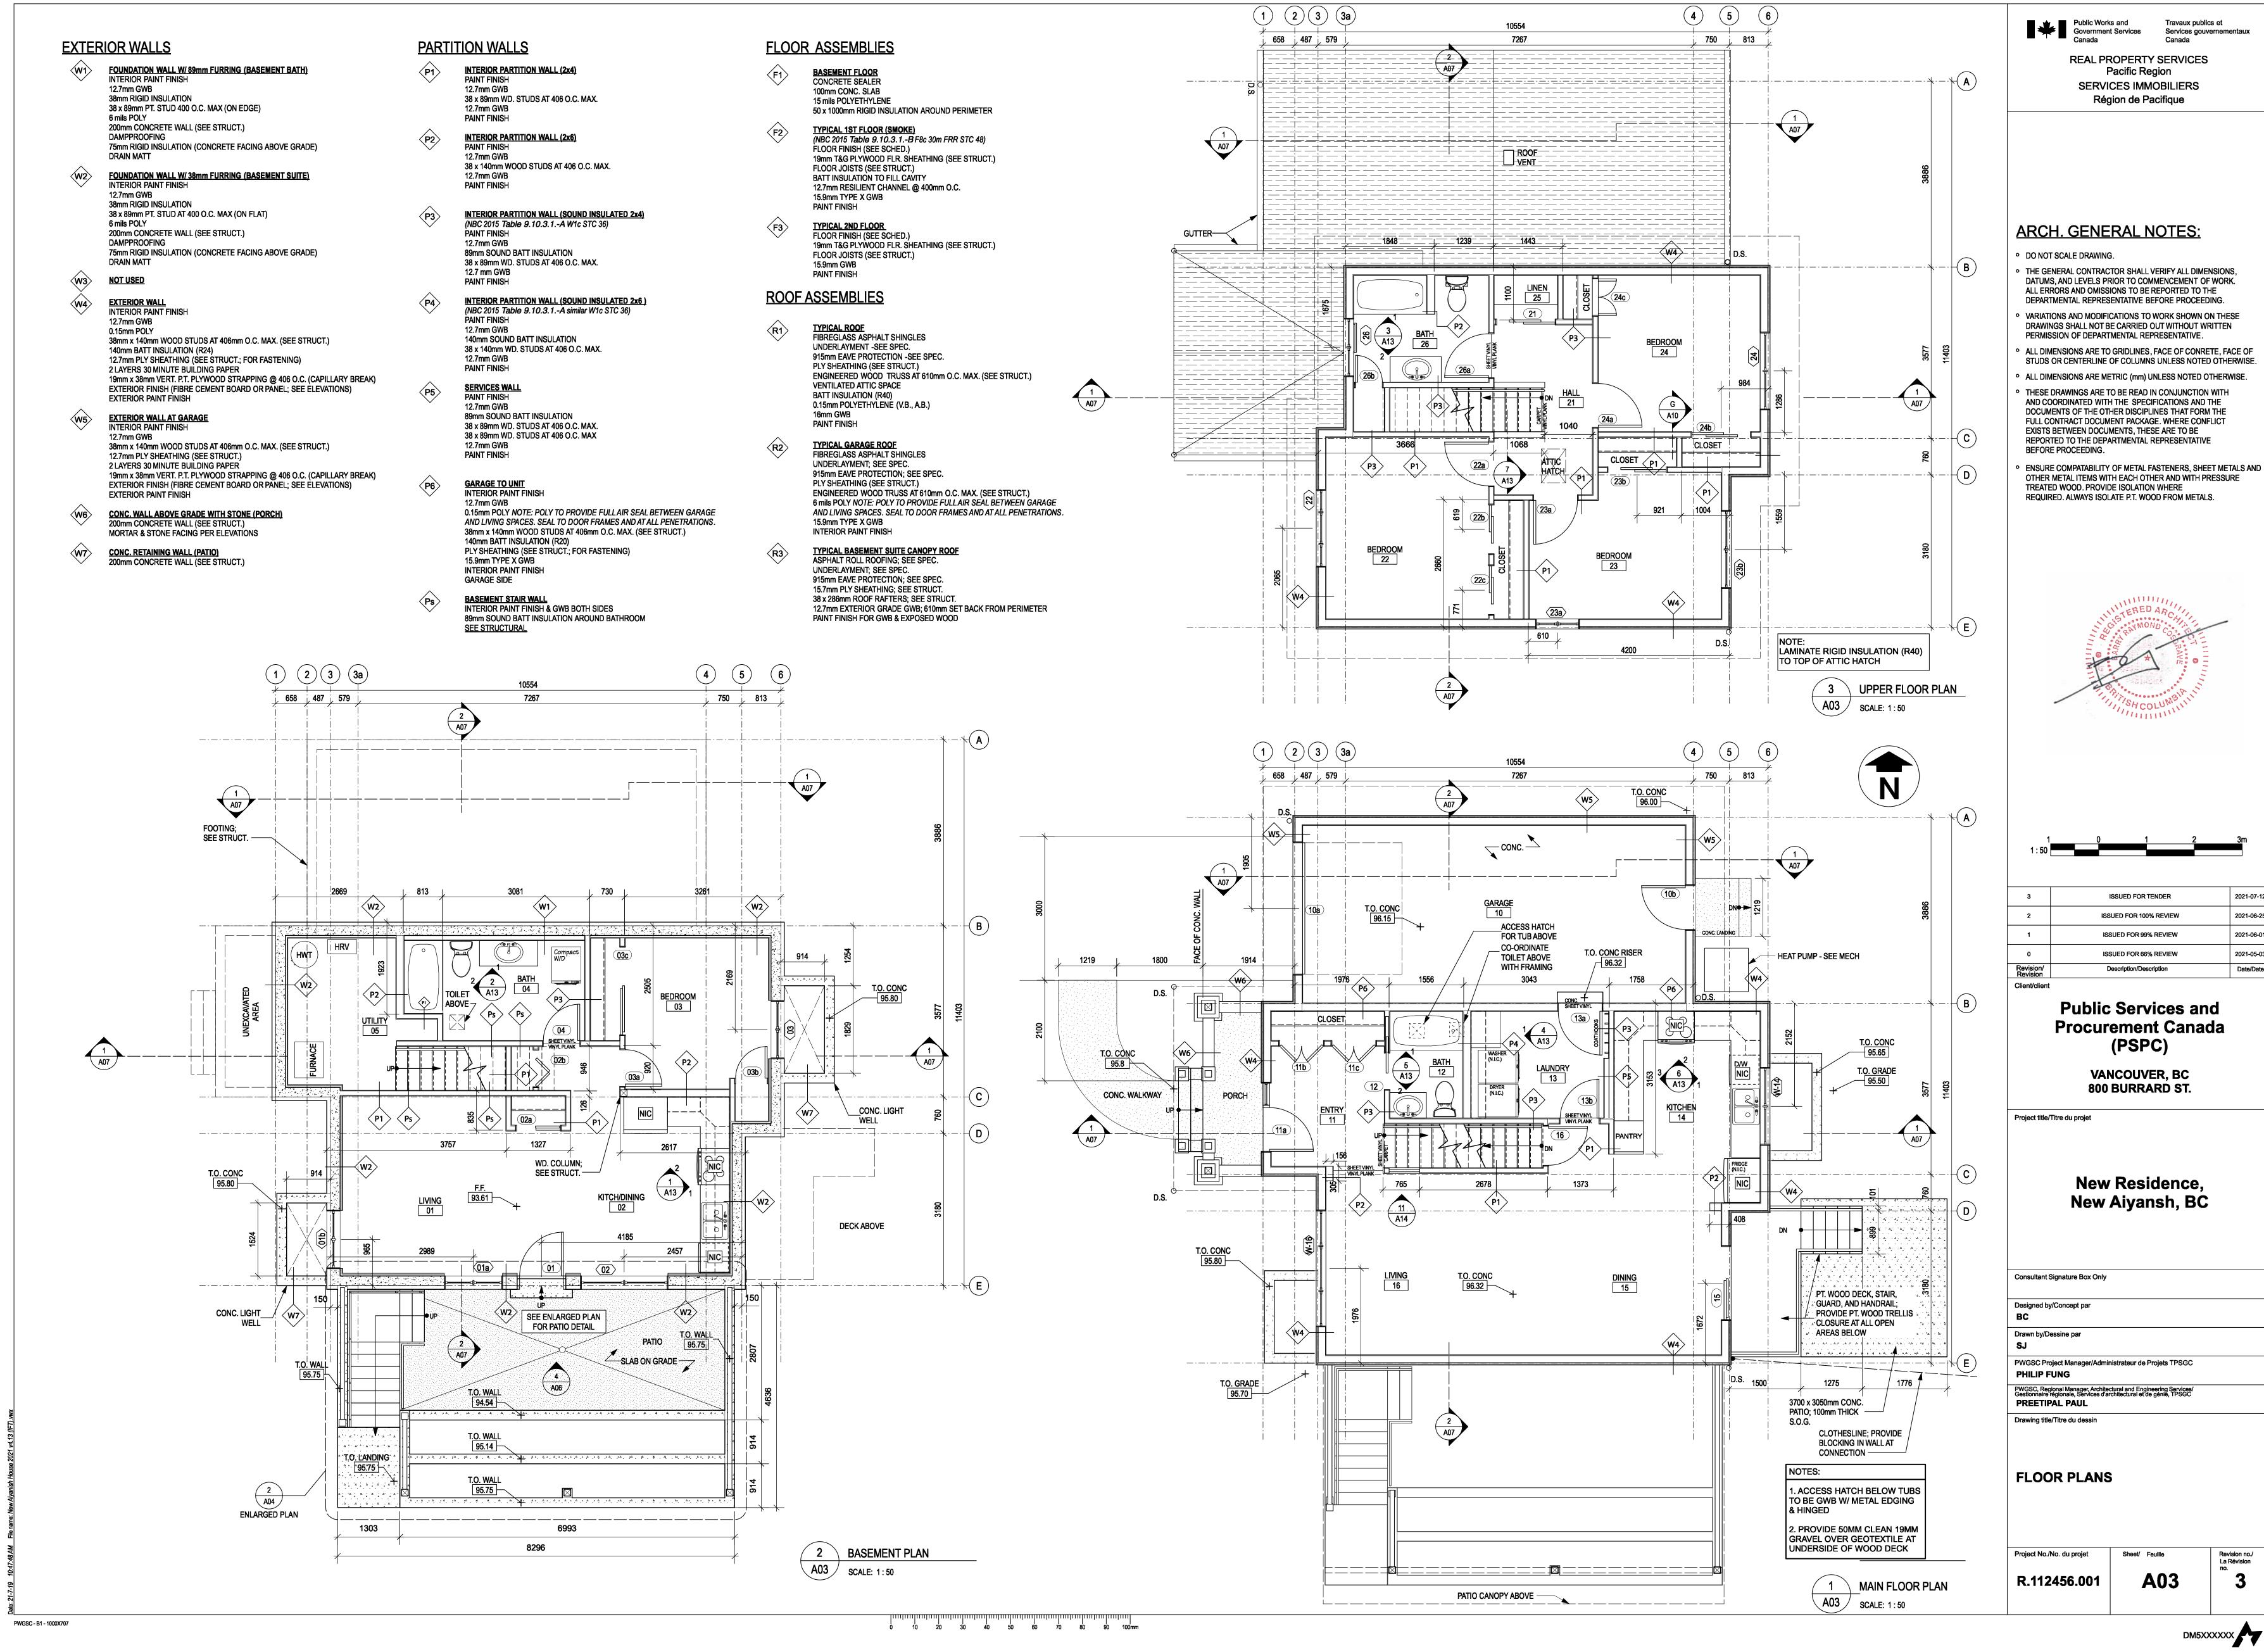


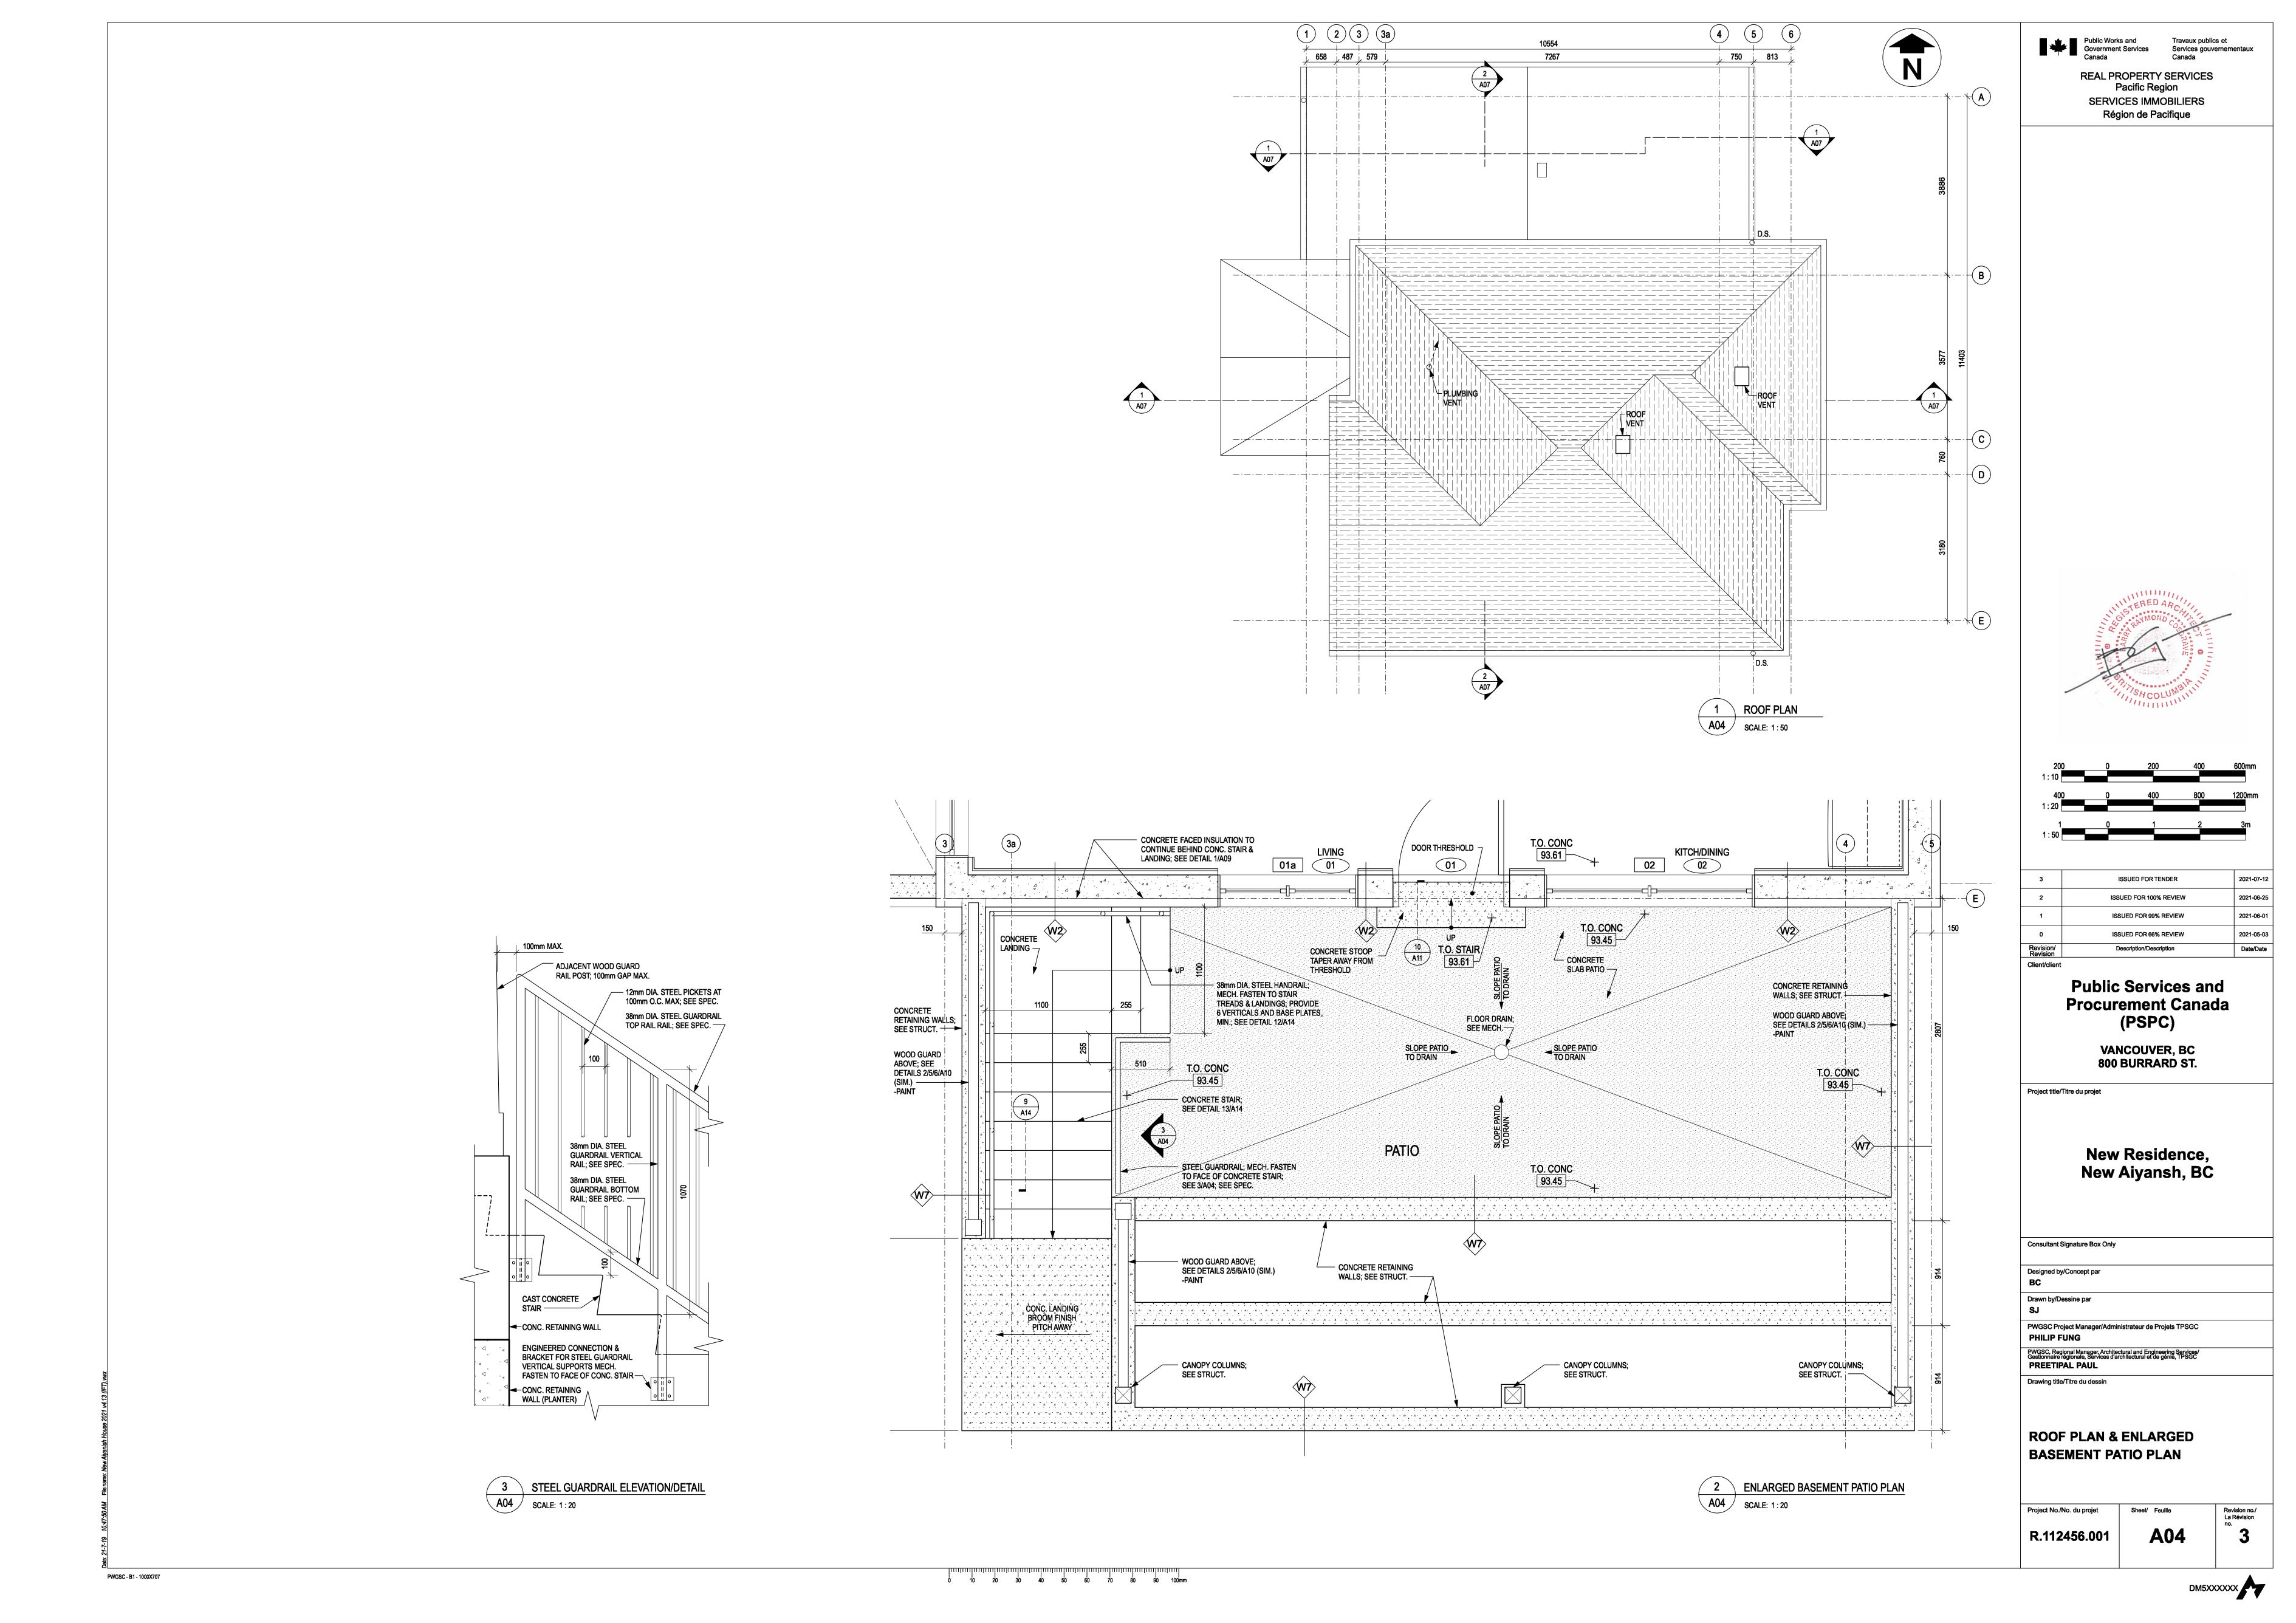


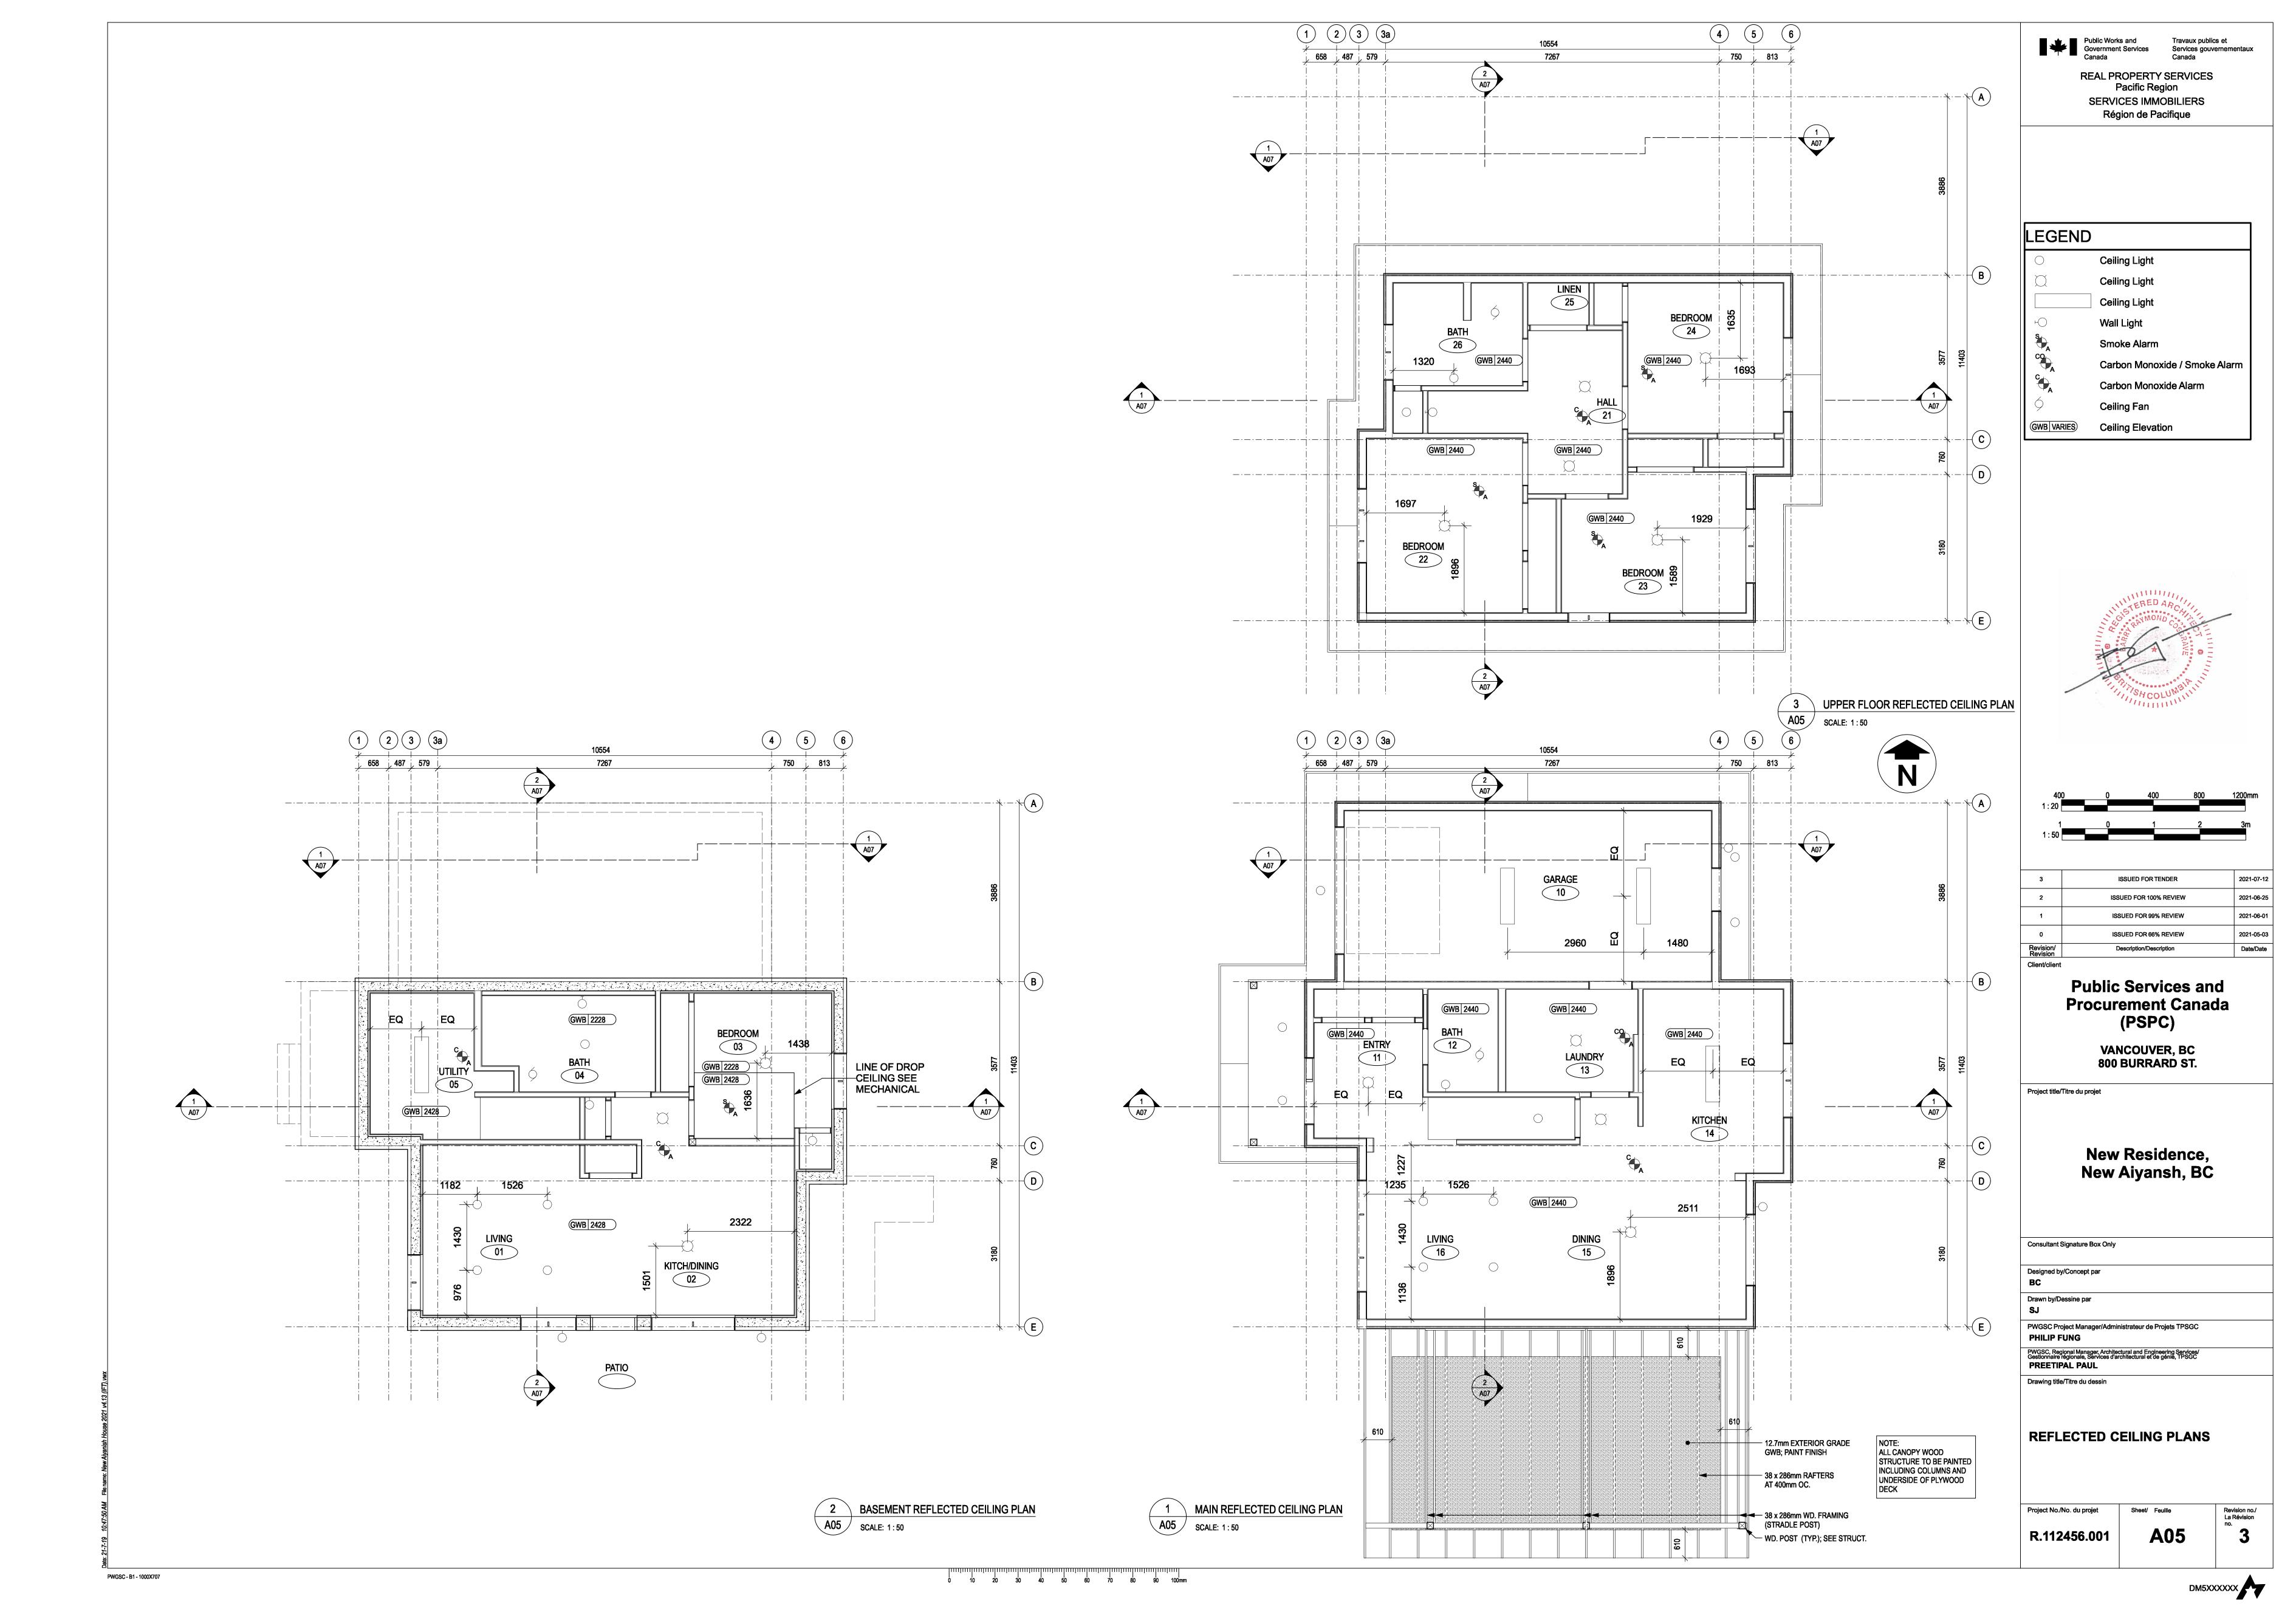





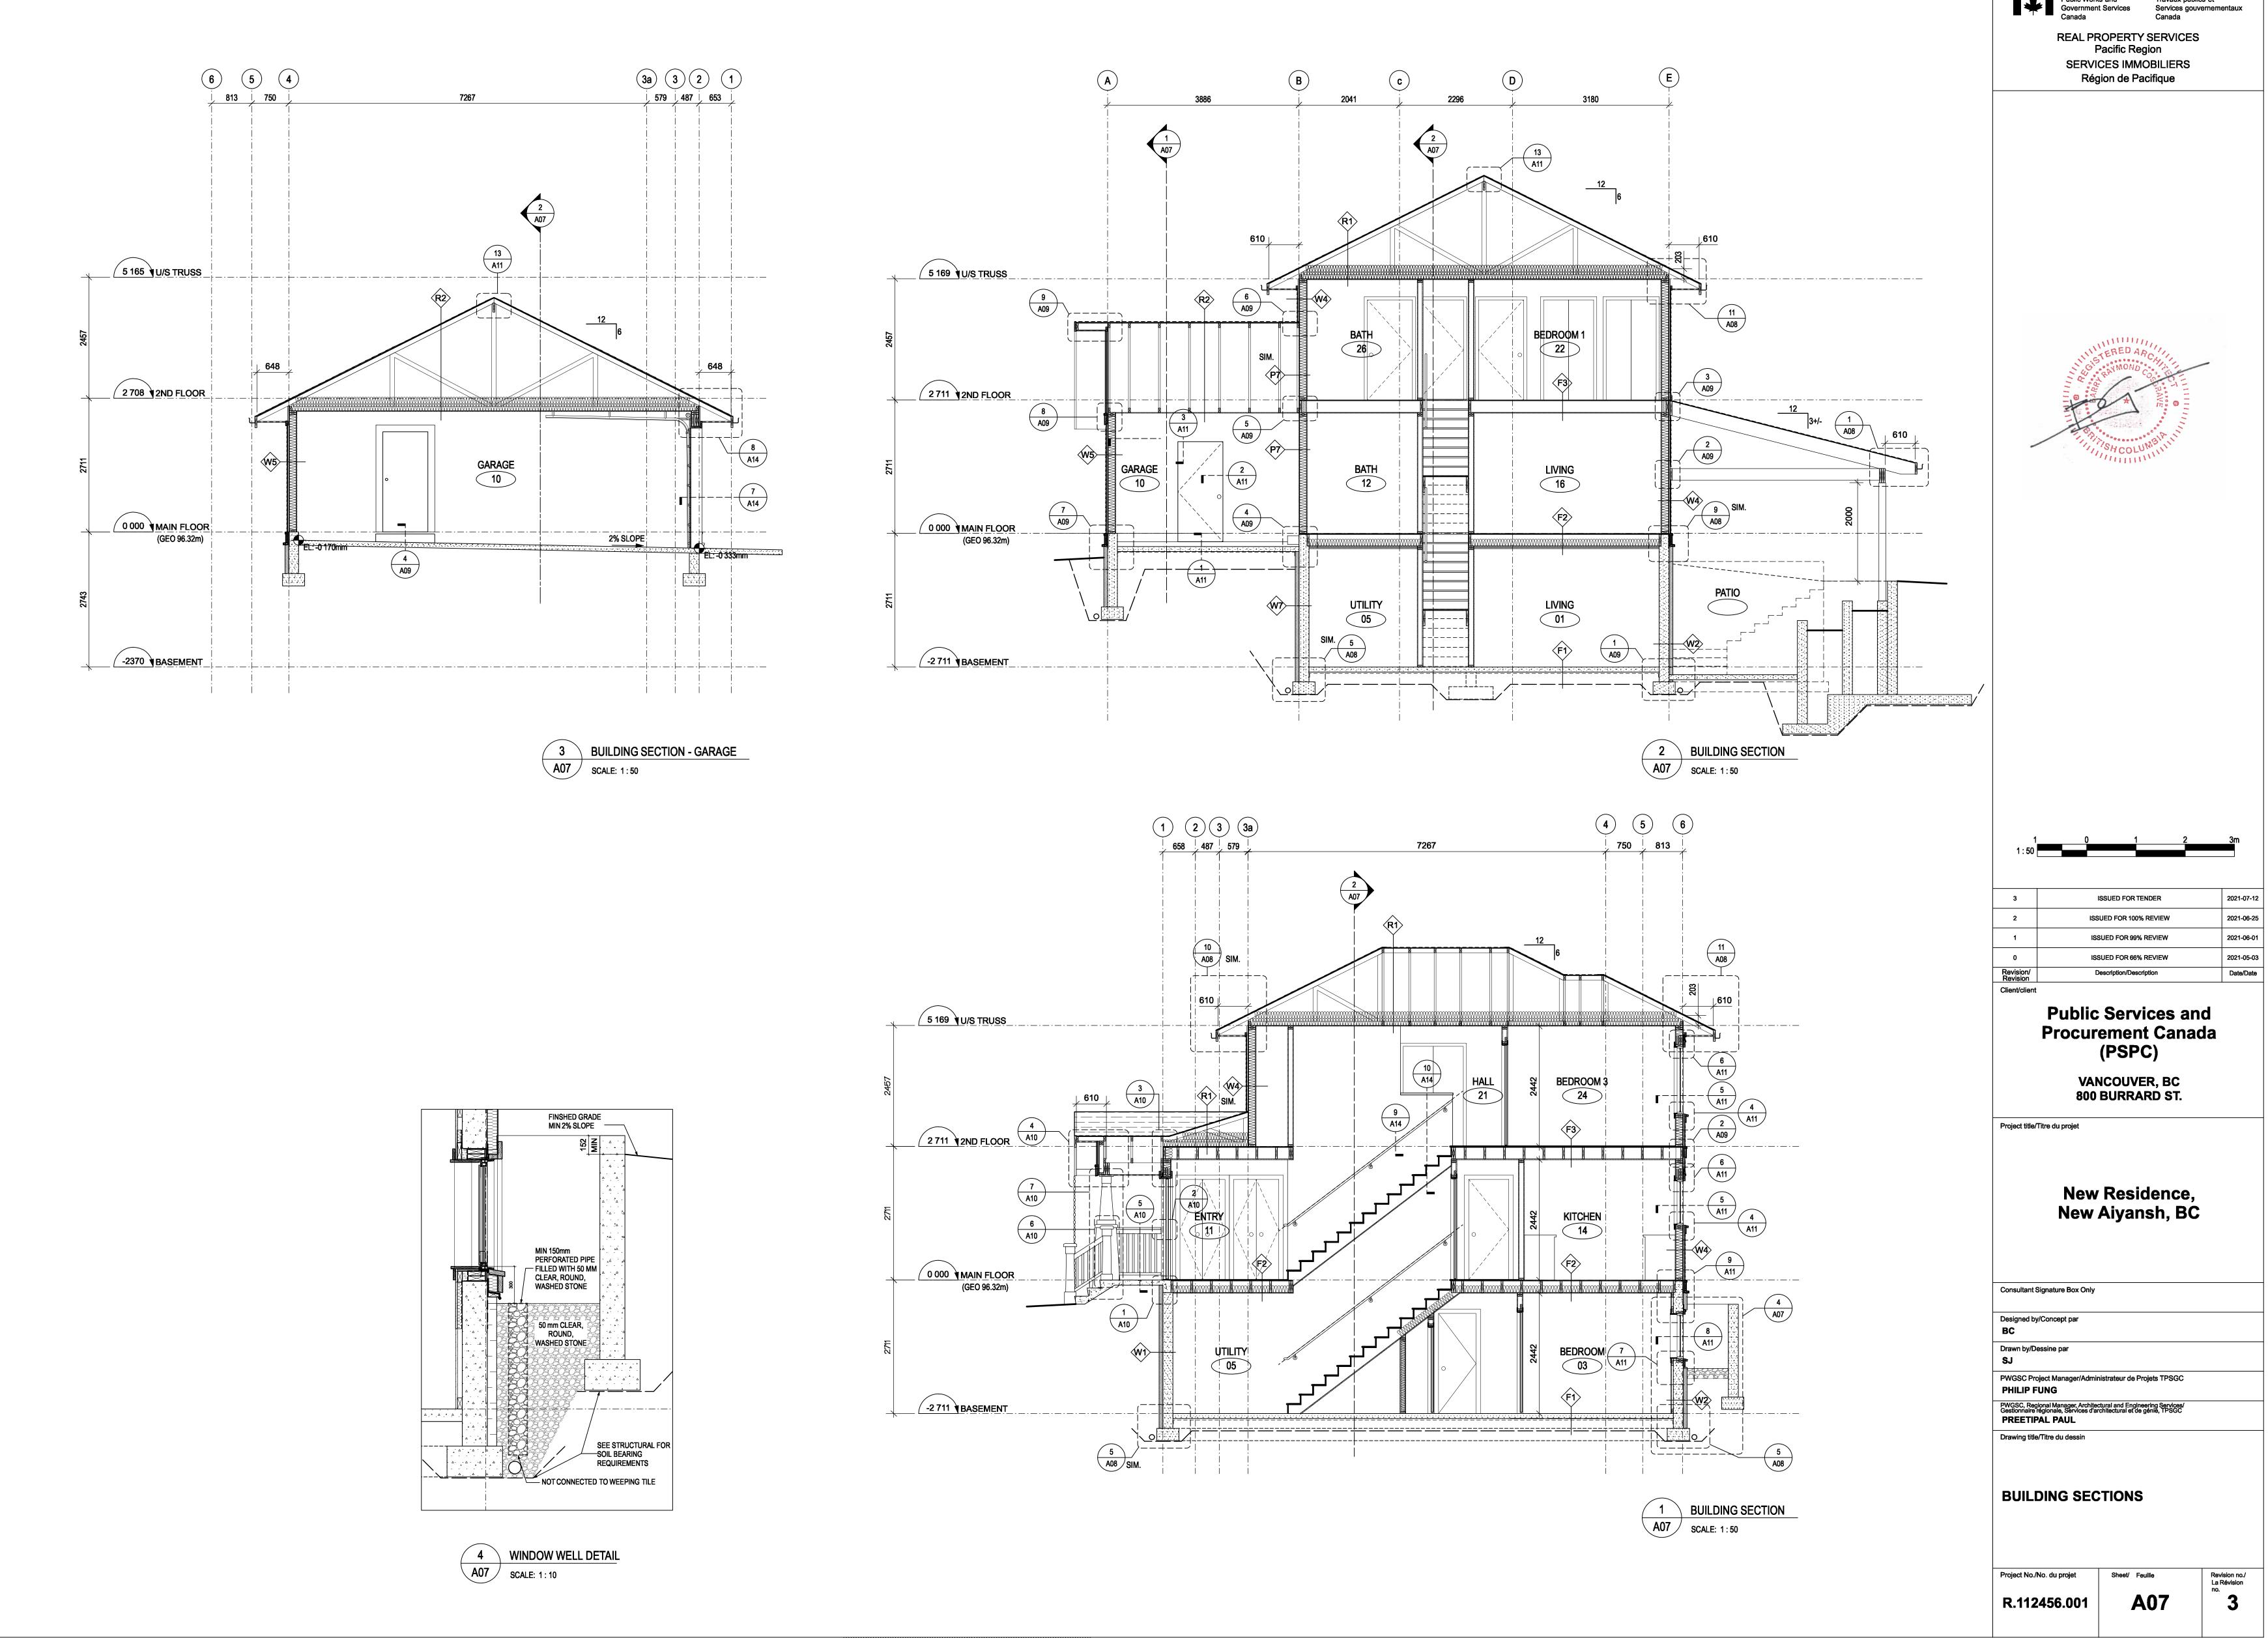

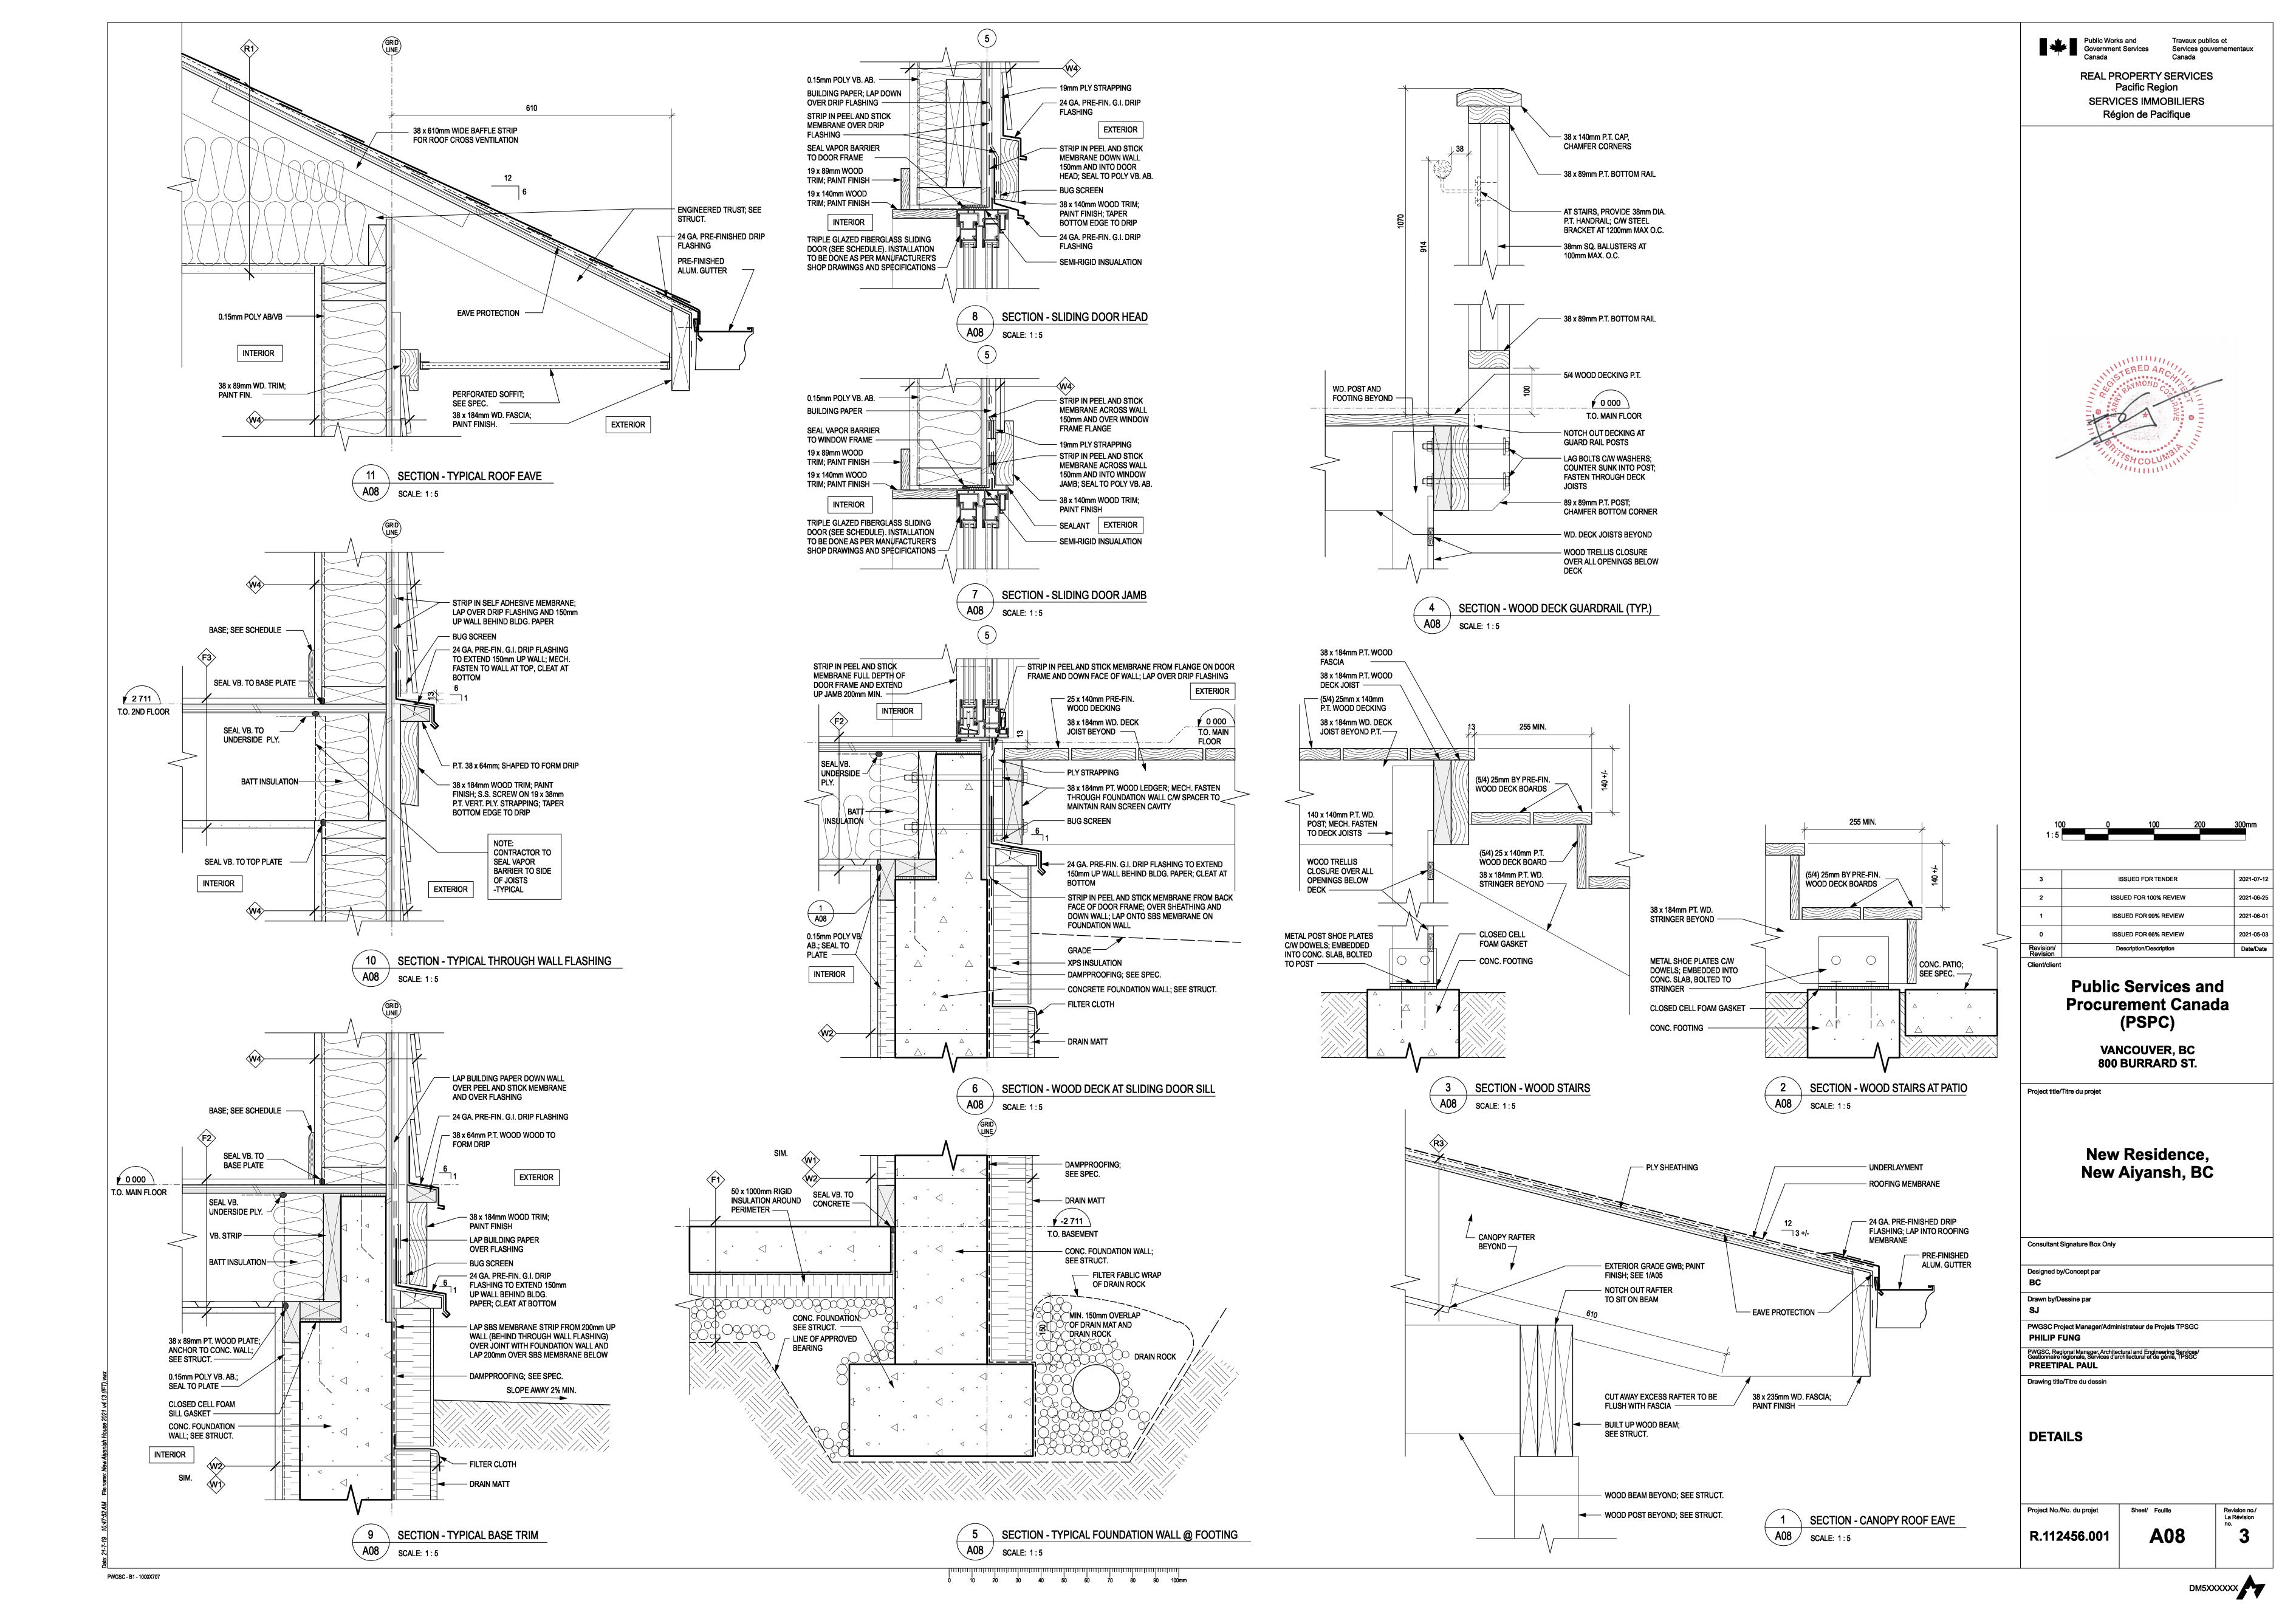


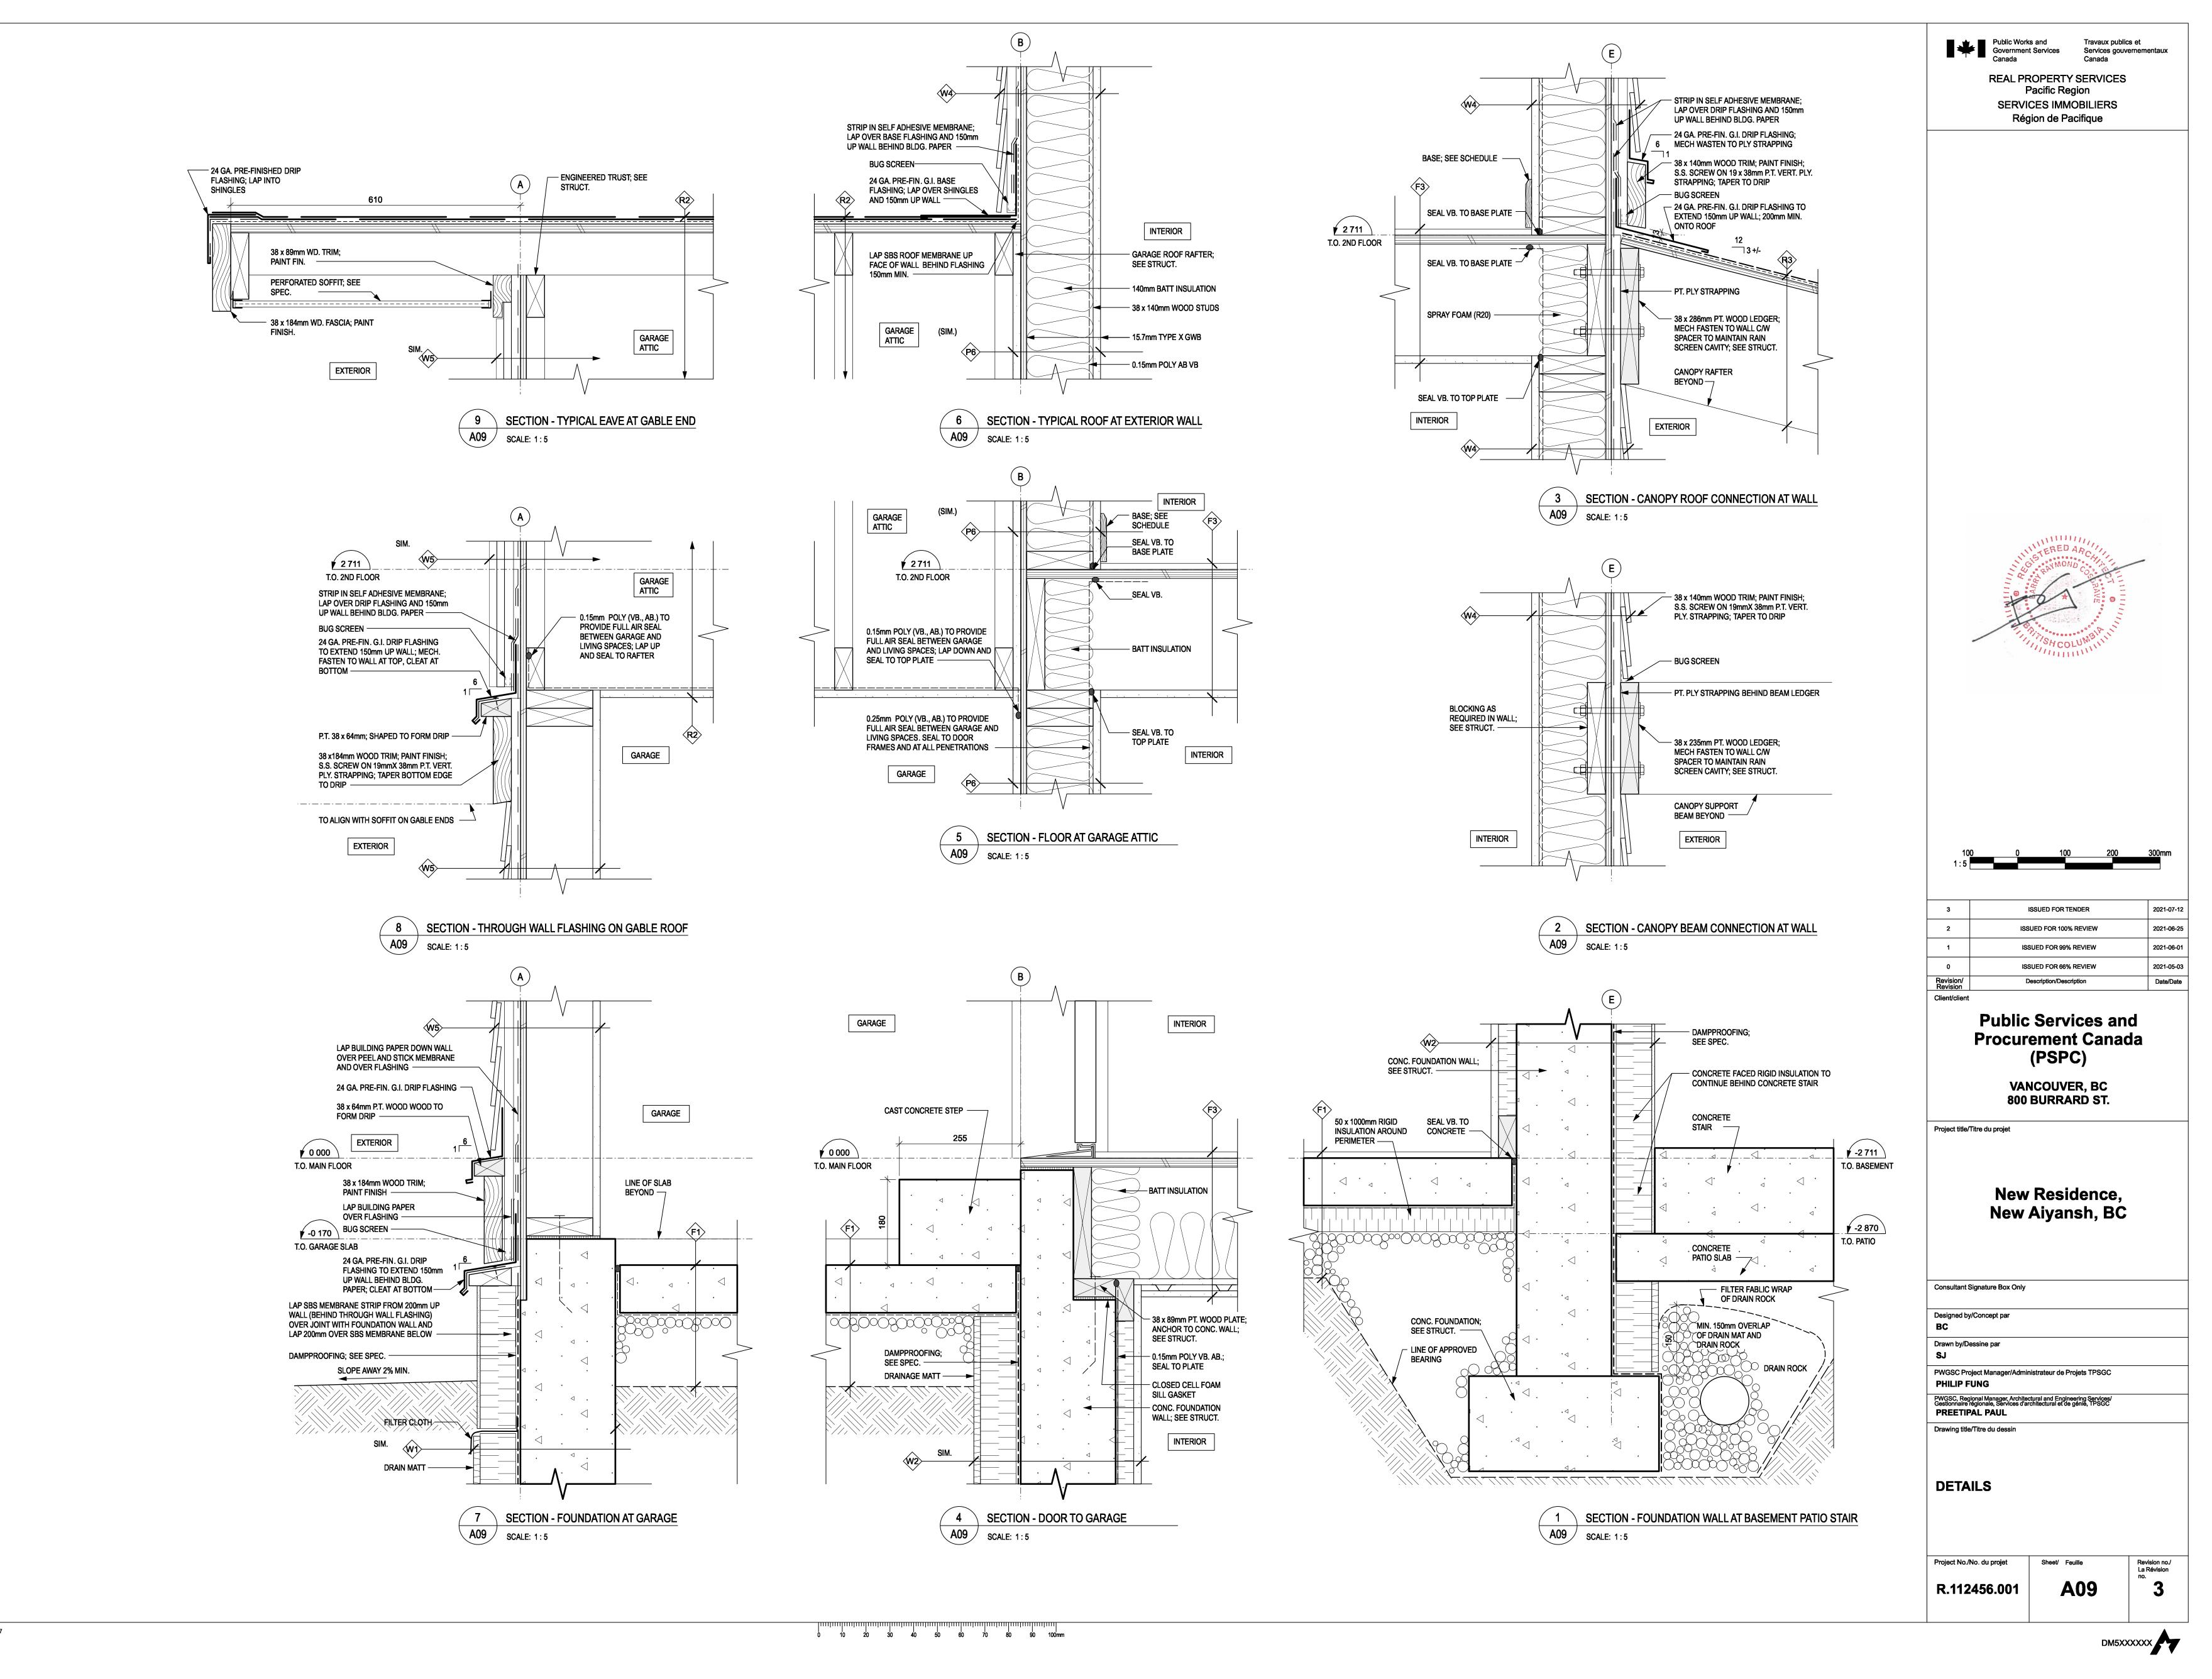

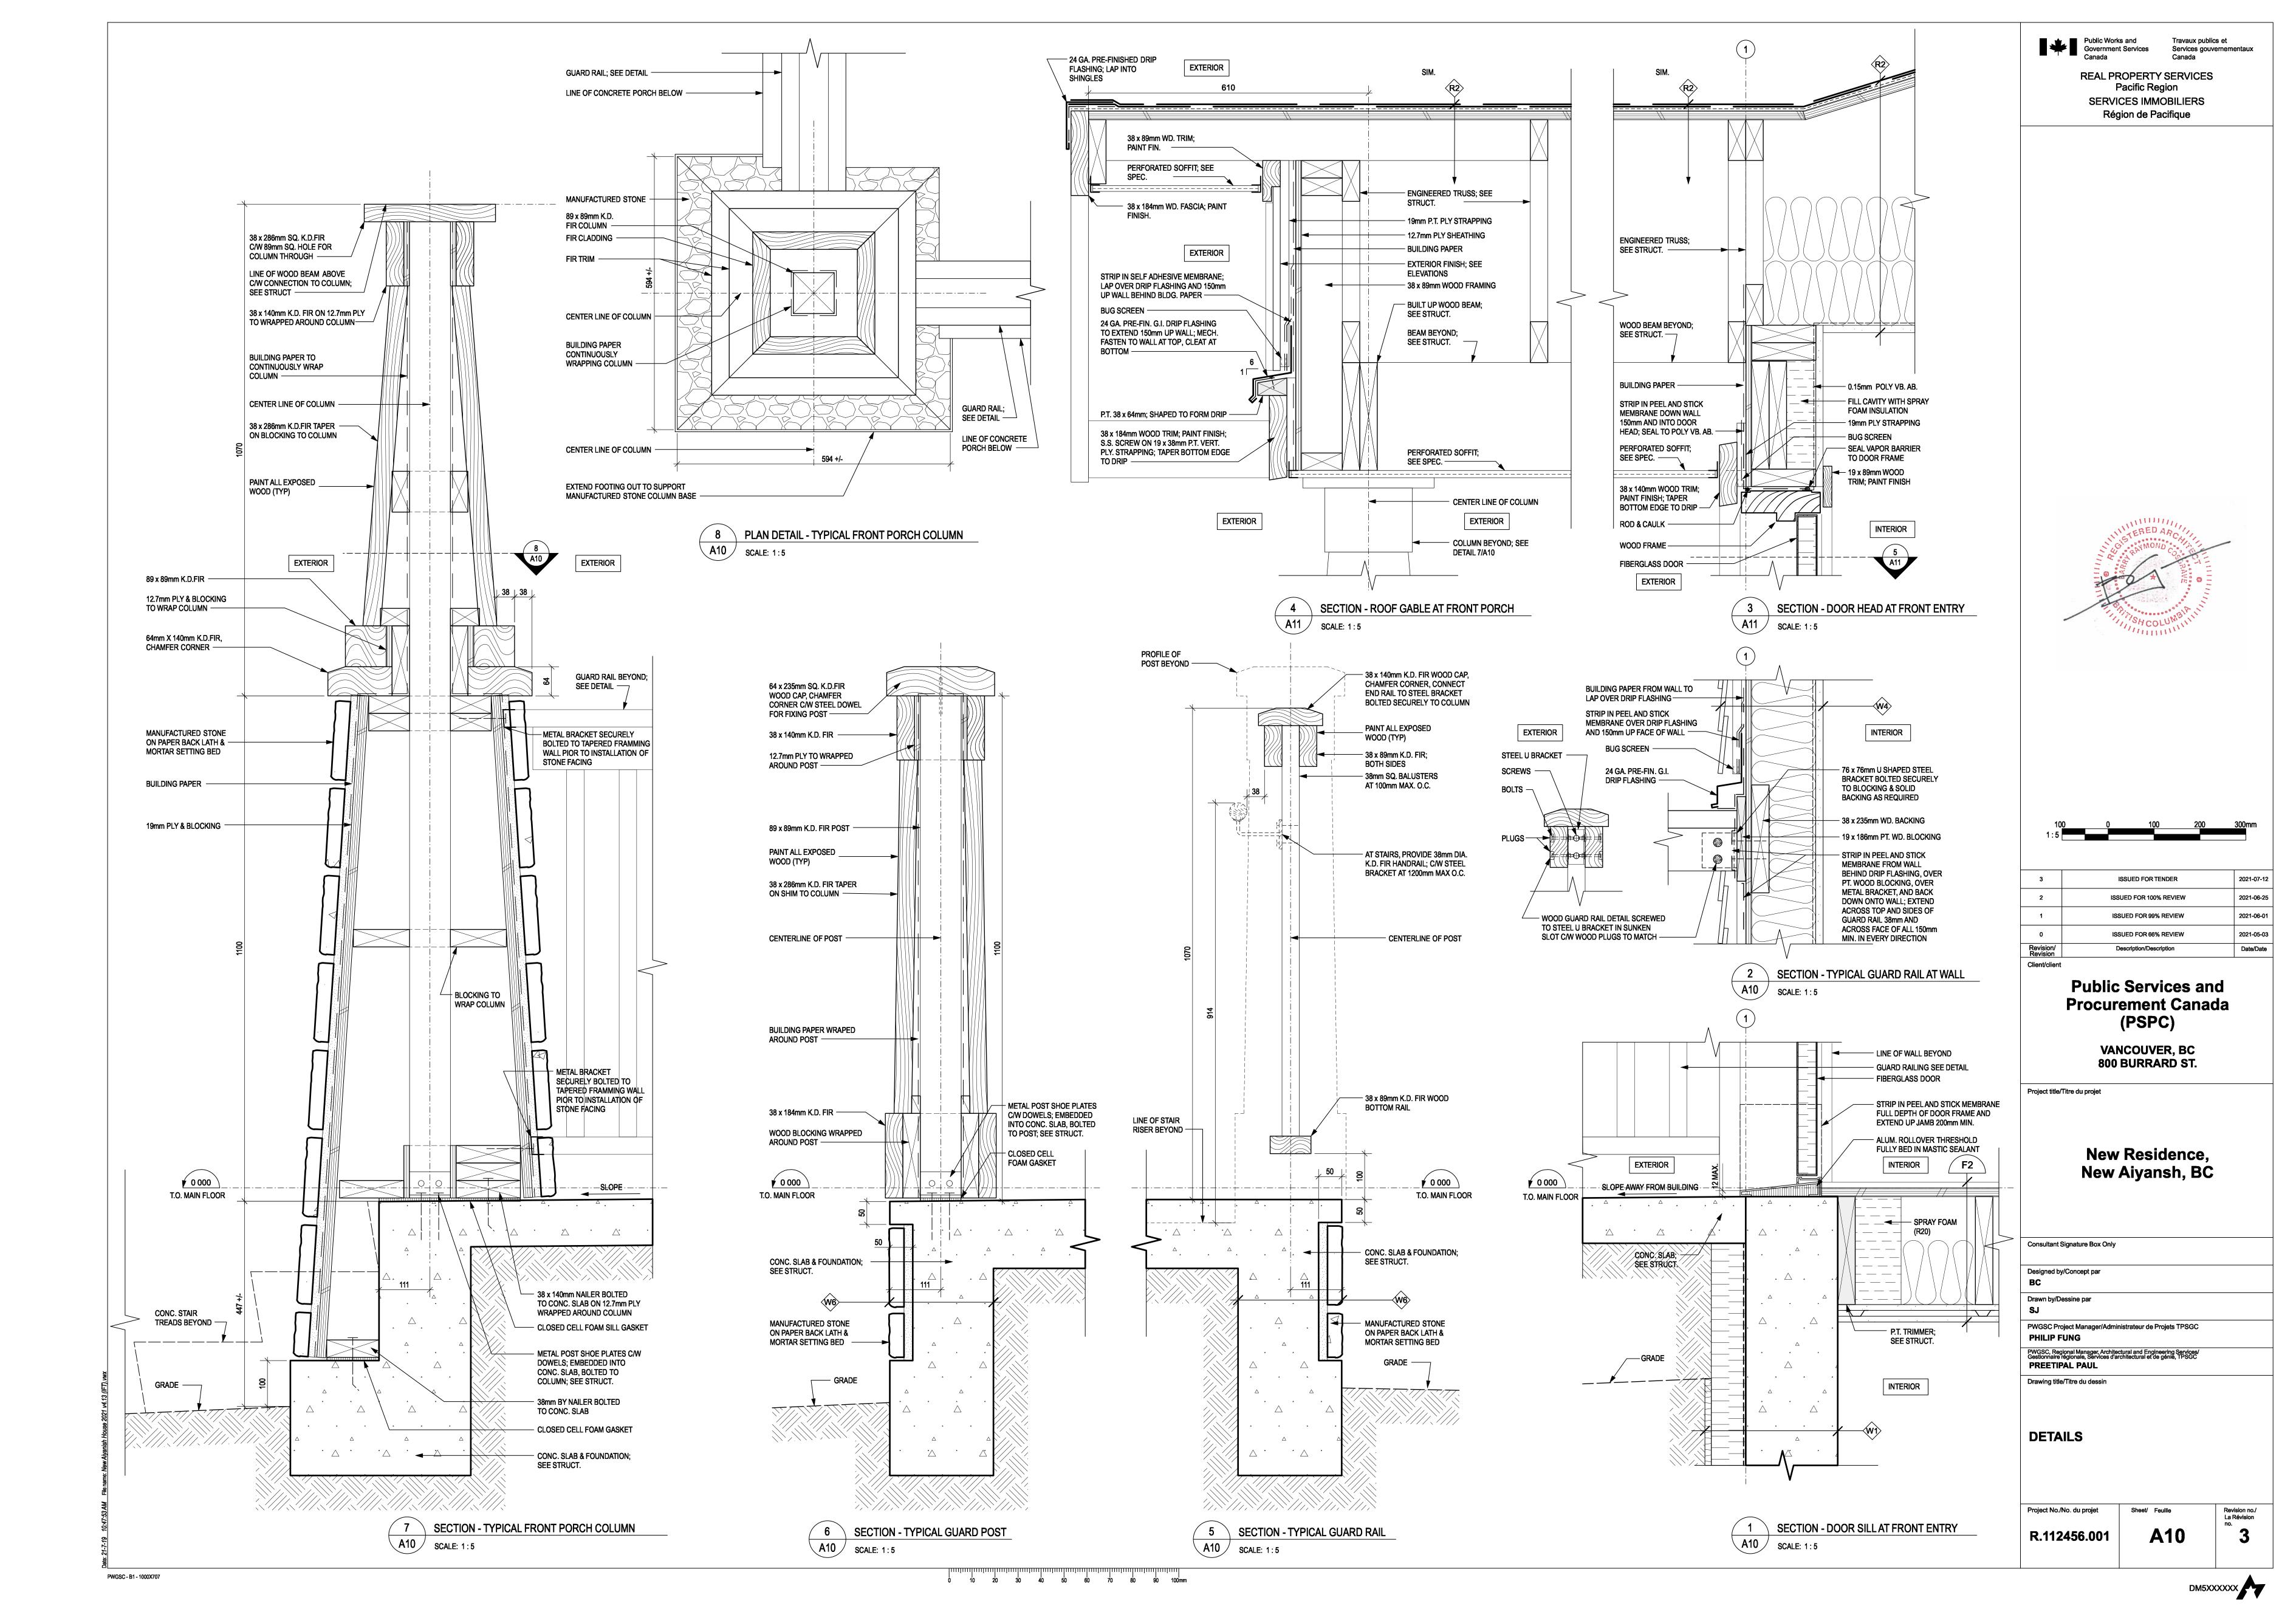


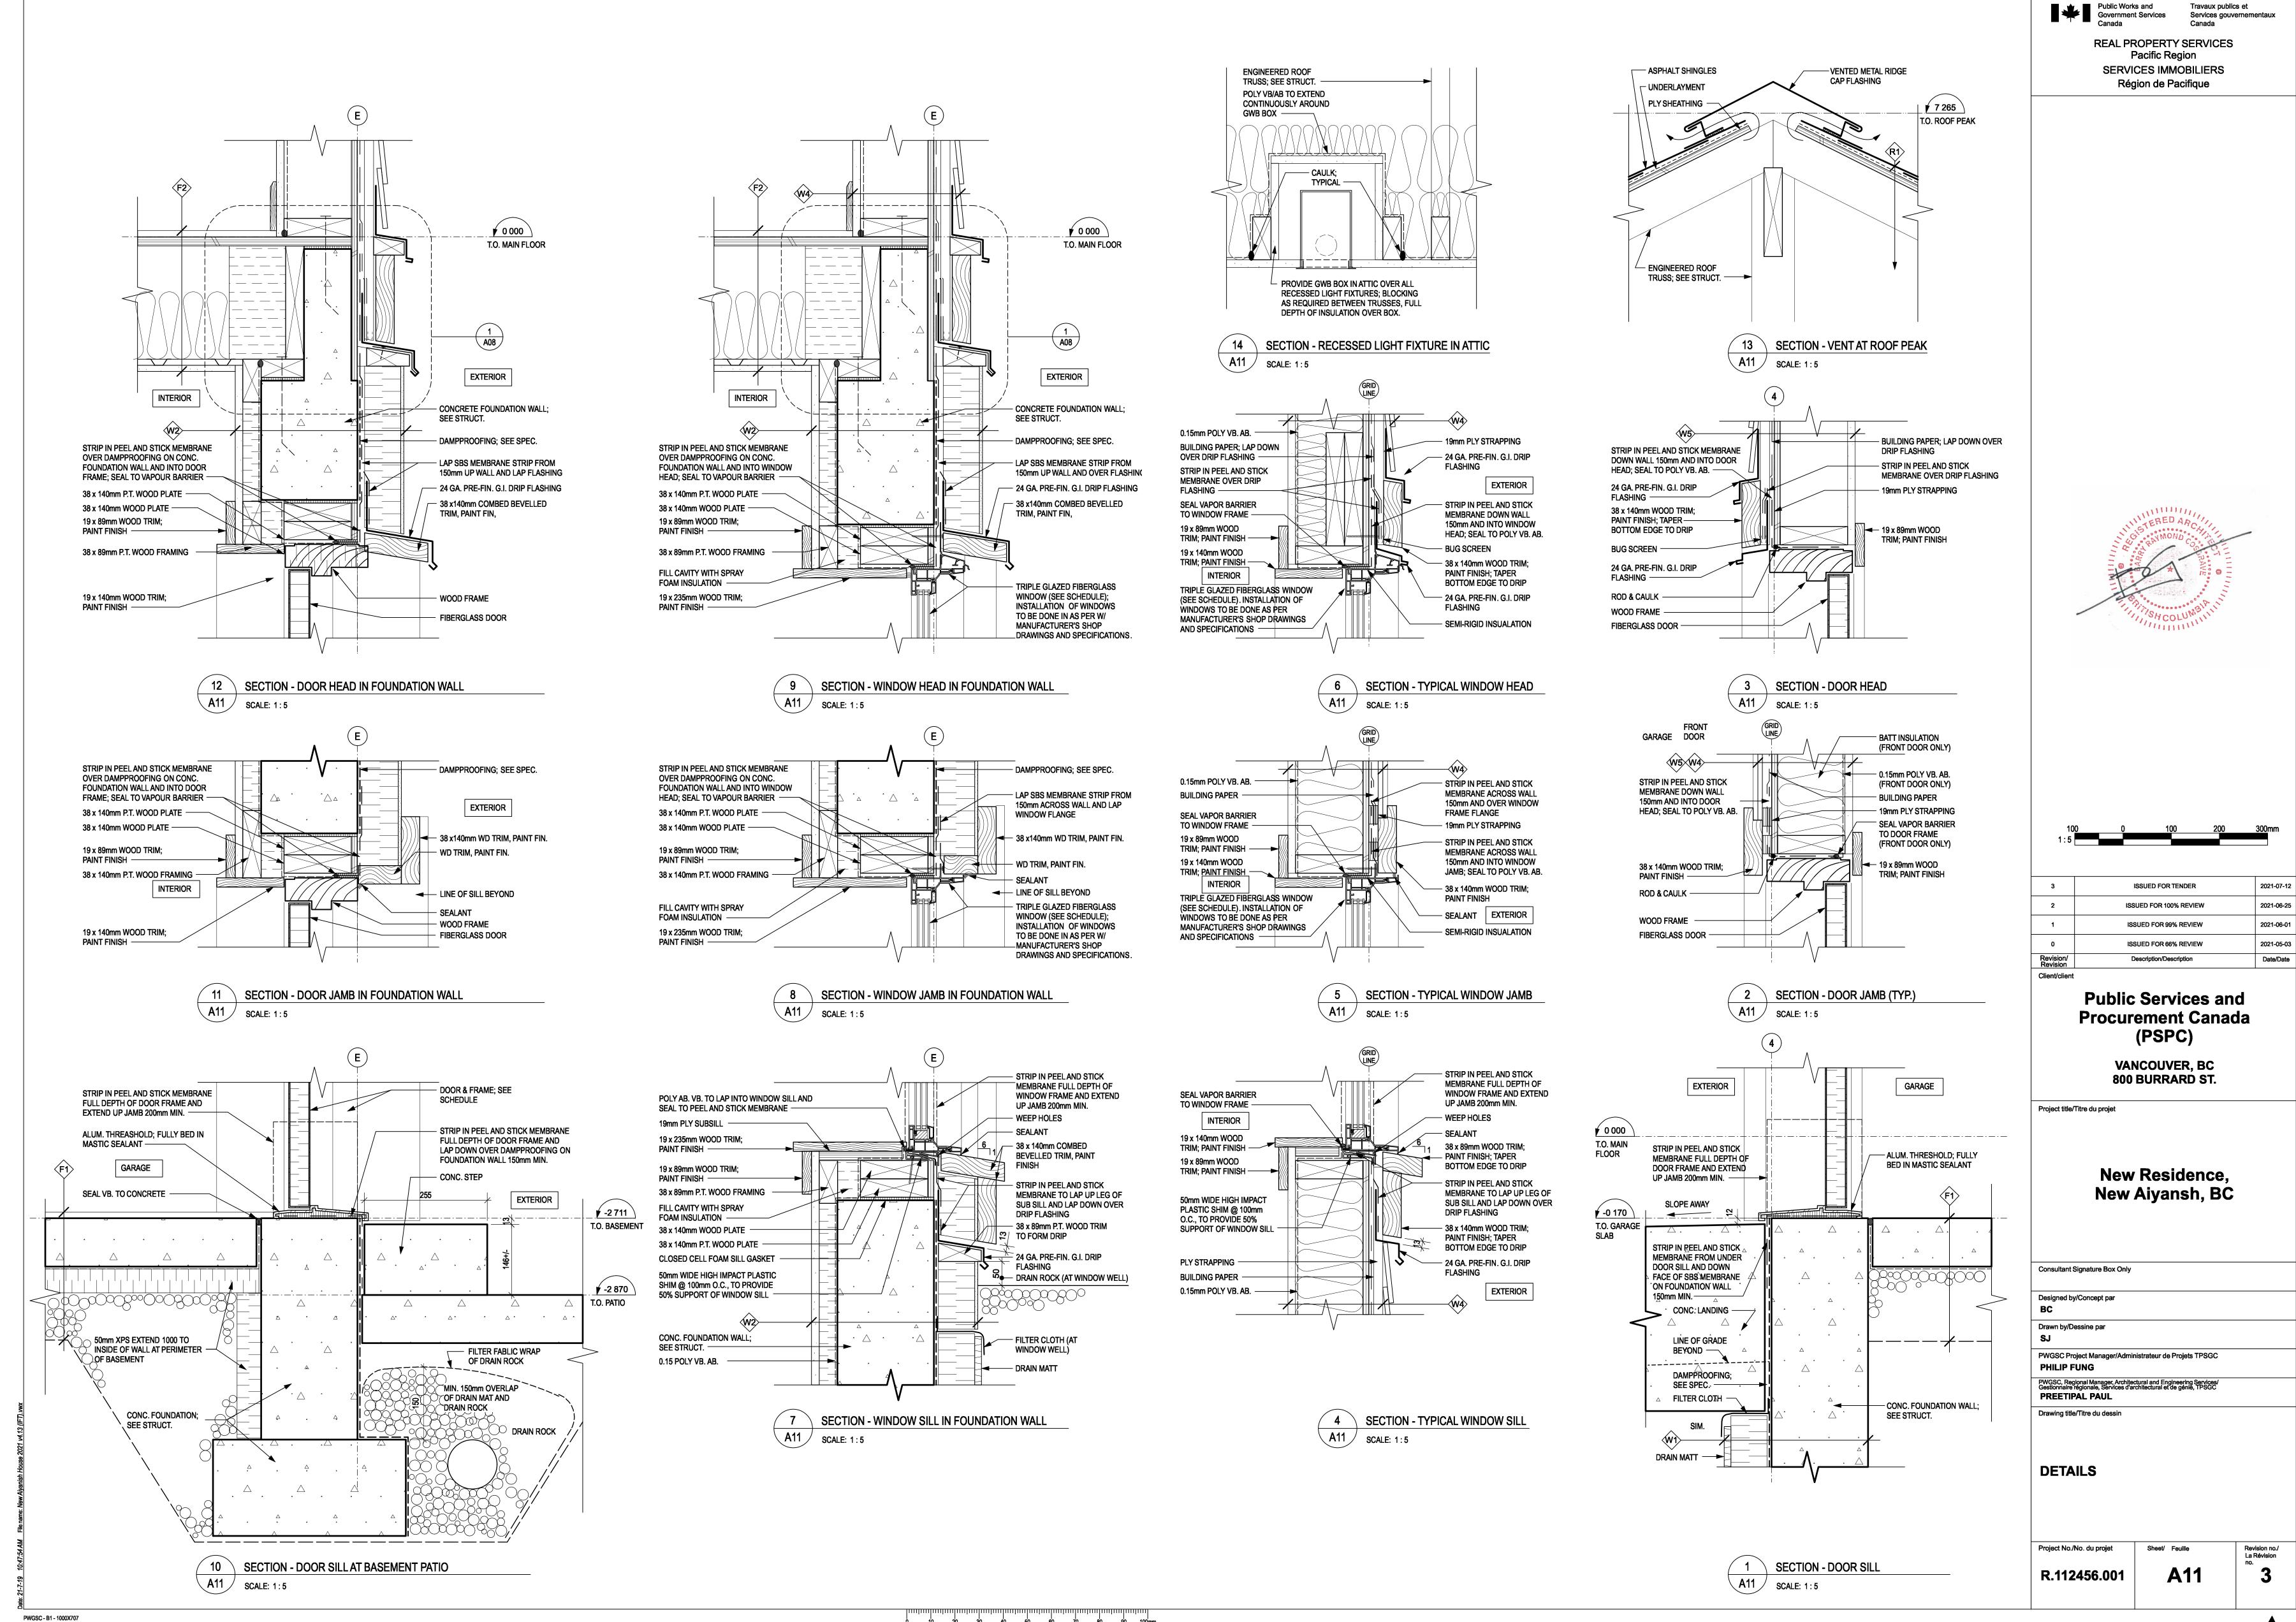

DOOR TYPES:

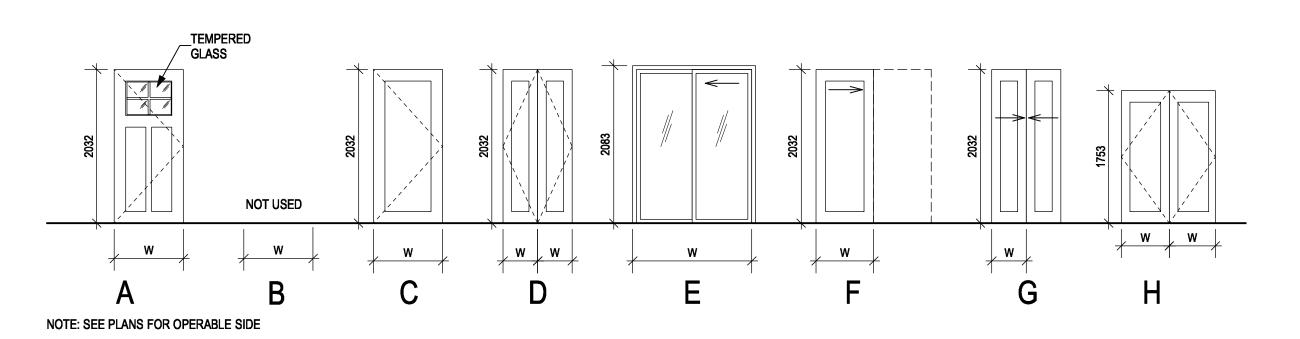

FRAME TYPES:

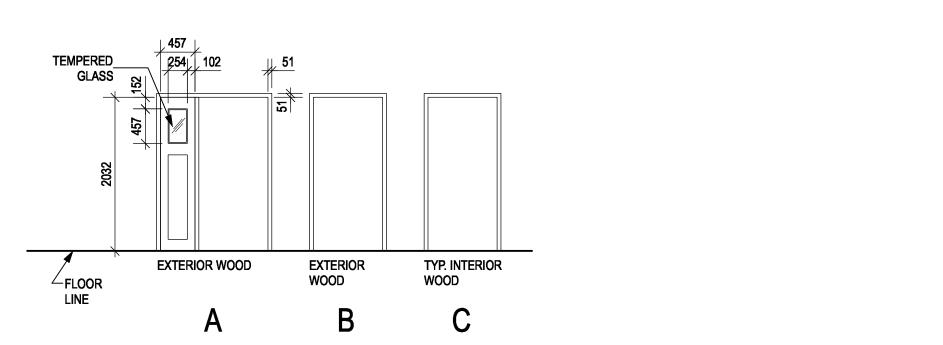

DOOI	R SCHEDULE													
							_				FRA	ME		
NUMBER	SIZE (W x H x THICK)	FROM	то	F.R.R.	H.W. CODE	TYPE	MAT'L	CORE	FINISH	GLAZ.	MAT'L	TYPE	FINISH	REMARKS
01	914 x 2032 x 45	EXTERIOR	LIVING		1	Α	F.G.	INSUL.	FAC.	T.G. SAFETY	WOOD	A	F.G	F.G. =FIBERGLASS. COLOR TO BE SELECTED
02a	2-483 x 2032 x 45	LIVING	CLOSET		12	G	WOOD	HOLLOW	PAINT		WOOD	С	PAINT	
02b	2-330 x 1753 x 45	HALL	CLOSET	_	13	Н	WOOD	HOLLOW	PAINT		WOOD	С	PAINT	
03a	762 x 2032 x 45	HALL	BEDROOM	_	9	С	WOOD	HOLLOW	PAINT		WOOD	С	PAINT	
03b	660 x 2032 x 45	BEDROOM	UTILITY	_	11	С	WOOD	HOLLOW	PAINT		WOOD	С	PAINT	
03c	2-940 x 2032 x 45	BEDROOM	CLOSET		12	G	WOOD	HOLLOW	PAINT		WOOD	С	PAINT	
04	762 x 2032 x 45	HALL	BATH	_	2	С	WOOD	HOLLOW	PAINT		WOOD	С	PAINT	
10a	2743 x 2438 x 45	GARAGE	EXTERIOR		8	_	METAL	INSUL.	FAC.		WOOD	_	PAINT	OVERHEAD DOOR; SEE SPEC.; STAIN TO MATCH FRONT DOOR
10b	914 x 2032 x 45	GARAGE	EXTERIOR		2	С	F.G.	INSUL.	FAC.		WOOD	В	PAINT	F.G. =FIBERGLASS. COLOR TO BE SELECTED
11a	914 x 2032 x 45	EXTERIOR	ENTRY		1	Α	F.G.	INSUL.	FAC.	T.G. SAFETY	WOOD	A	PAINT	F.G. =FIBERGLASS. COLOR TO BE SELECTED
11b	2-534 x 2032 x 45	CLOSET	ENTRY		4	D	WOOD	HOLLOW	PAINT	T.G. SAFETY	WOOD	С	PAINT	
11c	2-534 x 2032 x 45	CLOSET	ENTRY		4	D	WOOD	HOLLOW	PAINT		WOOD	С	PAINT	
12	762 x 2032 x 45	ENTRY	POWDER R.M.		10	F	WOOD	SOLID	PAINT		WOOD	С	PAINT	POCKET DOOR
13a	914 x 2032 x 45	LAUNDRY	GARAGE	45	2	С	F.G.	INSUL.	FAC.		WOOD	В	PAINT	FULLY WHEATHER STRIP C/W CLOSER GASKET THRESHOLD; SEE SPEC.
13b	813 x 2032 x 45	DINING	LAUNDRY	_	5	D	WOOD	HOLLOW	PAINT		WOOD	С	PAINT	
15	1524 x 2032 x 45	DINING	EXTERIOR		6	Е	F.G.	INSUL.			F.G.	_		SLIDING GLASS DOOR F.G. =FIBERGLASS. COLOR TO BE SELECTED
16	813 x 2032 x 45	DINING	STAIR	_	2	С	WOOD	HOLLOW	PAINT		WOOD	С	PAINT	
21	2-610 x 2032 x 45	LINEN	HALL		12	G	WOOD	HOLLOW	PAINT		WOOD	С	PAINT	
22a	914 x 2032 x 45	BEDROOM 1	HALL	_	9	С	WOOD	HOLLOW	PAINT		WOOD	С	PAINT	
22b	2-508 x 2032 x 45	CLOSET	BEDROOM 1	_	12	G	WOOD	HOLLOW	PAINT		WOOD	С	PAINT	
22c	2-508 x 2032 x 45	CLOSET	BEDROOM 1		12	G	WOOD	HOLLOW	PAINT		WOOD	С	PAINT	
23a	914 x 2032 x 45	BEDROOM 2	HALL		9	С	WOOD	HOLLOW	PAINT		WOOD	С	PAINT	
23b	2-610 x 2032 x 45	CLOSET	BEDROOM 2		12	G	WOOD	HOLLOW	PAINT		WOOD	С	PAINT	
24a	914 x 2032 x 45	BEDROOM 3	HALL		9	С	WOOD	HOLLOW	PAINT		WOOD	С	PAINT	
24b	2-610 x 2032 x 45	CLOSET	BEDROOM 3		12	G	WOOD	HOLLOW	PAINT		WOOD	С	PAINT	
24c	2-381 x 2032 x 45	CLOSET	BEDROOM 3	_	12	G	WOOD	HOLLOW	PAINT		WOOD	С	PAINT	
26a	914 x 2032 x 45	BATH	HALL	_	2	С	WOOD	SOLID	PAINT		WOOD	С	PAINT	
26b	559 x 2032 x 45	CLOSET	BATH	_	11	С	WOOD	HOLLOW	PAINT		WOOD	С	PAINT	

WINDOW SCHEDULE

01b 02

03

22

23a

26

1219 x 914

NUMBER UNIT SIZE (W x H) TYPE FRAME GLAZING

K FIBERGLASS T.G. LOWE E

J FIBERGLASS T.G. LOWE E

B FIBERGLASS T.G. LOWE E

H FIBERGLASS T.G. LOWE E

G FIBERGLASS T.G. LOWE E

A FIBERGLASS T.G. LOWE E

C FIBERGLASS T.G. LOWE E

F FIBERGLASS T.G. LOWE E

E FIBERGLASS T.G. LOWE E

E FIBERGLASS T.G. LOWE E

D FIBERGLASS T.G. LOWE E

ROOM

KITCH/DINING

BEDROOM

KITCHEN

BEDROOM 1

BEDROOM 2

BEDROOM 2

BEDROOM 3

REMARKS

CASEMENT

CASEMENT

CASEMENT

CASEMENT

CASEMENT

CASEMENT

CASEMENT

SLIDER, EGRESS WINDOW

CASEMENT, ROTO CRANK OPERATOR CASEMENT, 100mm OPENING RESTRICTOR


SLIDER

Public Works and Government Service Canada

Canada Canada

REAL PROPERTY SERVICES
Pacific Region

SERVICES IMMOBILIERS
Région de Pacifique

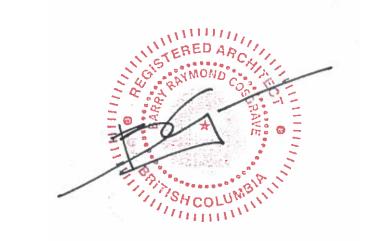

1 0 1 2 3m 1:50

3	ISSUED FOR TENDER	2021-07-12
2	ISSUED FOR 100% REVIEW	2021-06-25
1	ISSUED FOR 99% REVIEW	2021-06-01
0	ISSUED FOR 66% REVIEW	2021-05-03
Revision/ Revision	Description/Description	Date/Date
Client/client		

Public Services and Procurement Canada (PSPC)

VANCOUVER, BC 800 BURRARD ST.

Project title/Titre du projet

New Residence, New Aiyansh, BC

Consultant Signature Box Only
,

Drawn by/Dessine par

Designed by/Concept par

SJ

PWGSC Project Manager/Administrateur de Projets TPSGC PHILIP FUNG

PWGSC, Regional Manager, Architectural and Engineering Services/ Gestionnaire régionale, Services d'architectural et de génie, TPSGC PREETIPAL PAUL

Drawing title/Titre du dessin


SCHEDULES

Project No./No. du projet Sh

R.112456.001


A12

WINDOW TYPES:

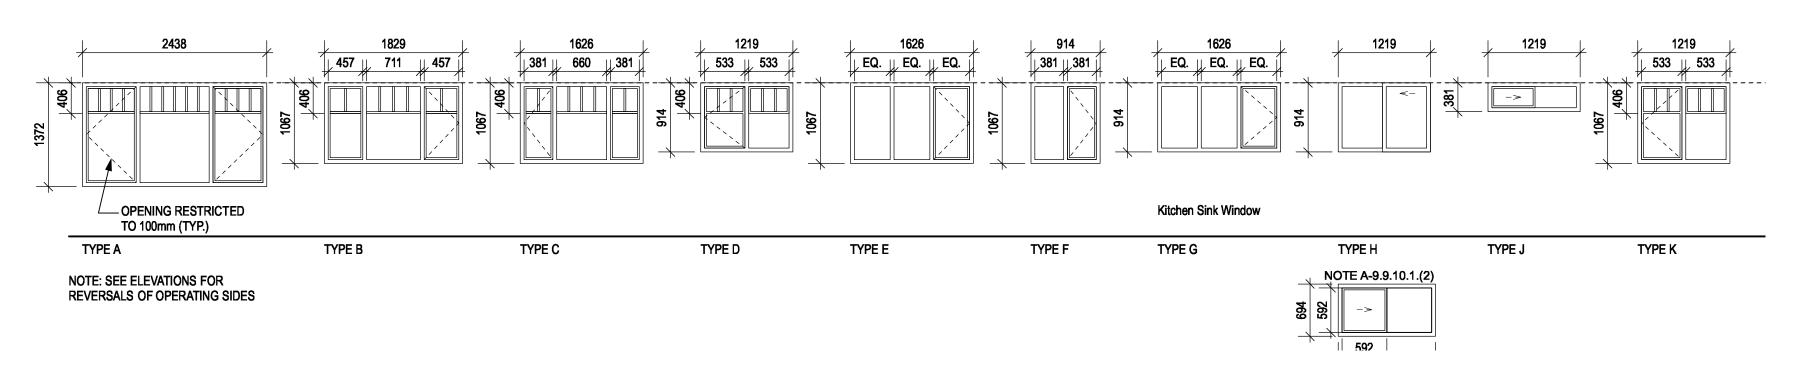

		FLOOR			CEILING			WEST WAL	L		NORTH WA	NLL		EAST WALL			SOUTH WA	LL		REMARKS
NUMBER	ROOM NAME	FINISH	COLOUR	BASE	MATERIAL	FINISH	COLOUR	MATERIAL	FINISH	COLOUR	MATERIAL	FINISH	COLOUR	MATERIAL	FINISH	COLOUR	MATERIAL	FINISH	COLOUR	
01	LIVING	VINYL PLANK		WOOD BASE	GWB	PAINT		GWB	PAINT		GWB	PAINT		GWB	PAINT		GWB	PAINT		
02	KITCH/DINING	VINYL PLANK		WOOD BASE	GWB	PAINT		GWB	PAINT		GWB	PAINT		GWB	PAINT		GWB	PAINT		
03	BEDROOM	VINYL PLANK		WOOD BASE	GWB	PAINT		GWB	PAINT		GWB	PAINT		GWB	PAINT		GWB	PAINT		
04	BATHROOM	SHEET VINYL		WOOD BASE	GWB	PAINT		GWB	PAINT		GWB	PAINT		GWB	PAINT		GWB	PAINT		
05	UTILITY	PAINTED CONC.		WOOD BASE	GWB	PAINT		CONC.	PAINT		CONC.	PAINT		GWB	PAINT		GWB	PAINT		PAINTED CONC. FLOOR
10	GARAGE	CONC.	†	WOOD BASE	GWB	PAINT	†	GWB	PAINT	1	GWB	PAINT	A	GWB	PAINT	†	GWB	PAINT	†	SEALED CONC. FLOOR
11	ENTRY	SHEET VINYL		WOOD BASE	GWB	PAINT		GWB	PAINT		GWB	PAINT		GWB	PAINT		GWB	PAINT		
12	POWDER R.M.	SHEET VINYL		WOOD BASE	GWB	PAINT		GWB	PAINT		GWB	PAINT		GWB	PAINT		GWB	PAINT		
13	LAUNDRY	VINYL PLANK	TBD	WOOD BASE	GWB	PAINT	TBD	GWB	PAINT	TBD	GWB	PAINT	TBD	GWB	PAINT	TBD	GWB	PAINT	TBD	
14	KITCHEN	SHEET VINYL		WOOD BASE	GWB	PAINT		GWB	PAINT		GWB	PAINT		GWB	PAINT		GWB	PAINT		
15	DINING	VINYL PLANK		WOOD BASE	GWB	PAINT		GWB	PAINT		GWB	PAINT		GWB	PAINT		GWB	PAINT		
16	LIVING	VINYL PLANK	V	WOOD BASE	GWB	PAINT	₩	GWB	PAINT	₩	GWB	PAINT	•	GWB	PAINT	\ \	GWB	PAINT	•	
21	HALL	VINYL PLANK		WOOD BASE	GWB	PAINT		GWB	PAINT		GWB	PAINT		GWB	PAINT		GWB	PAINT		
22	BEDROOM 1	VINYL PLANK		WOOD BASE	GWB	PAINT		GWB	PAINT		GWB	PAINT		GWB	PAINT		GWB	PAINT		
23	BEDROOM 2	VINYL PLANK		WOOD BASE	GWB	PAINT		GWB	PAINT		GWB	PAINT		GWB	PAINT		GWB	PAINT		
24	BEDROOM 3	VINYL PLANK		WOOD BASE	GWB	PAINT		GWB	PAINT		GWB	PAINT		GWB	PAINT		GWB	PAINT		
25	LINEN	VINYL PLANK		WOOD BASE	GWB	PAINT		GWB	PAINT		GWB	PAINT		GWB	PAINT		GWB	PAINT		
26	BATH	SHEET		WOOD BASE	GWB	PAINT		GWB	PAINT		GWB	PAINT		GWB	PAINT		GWB	PAINT		



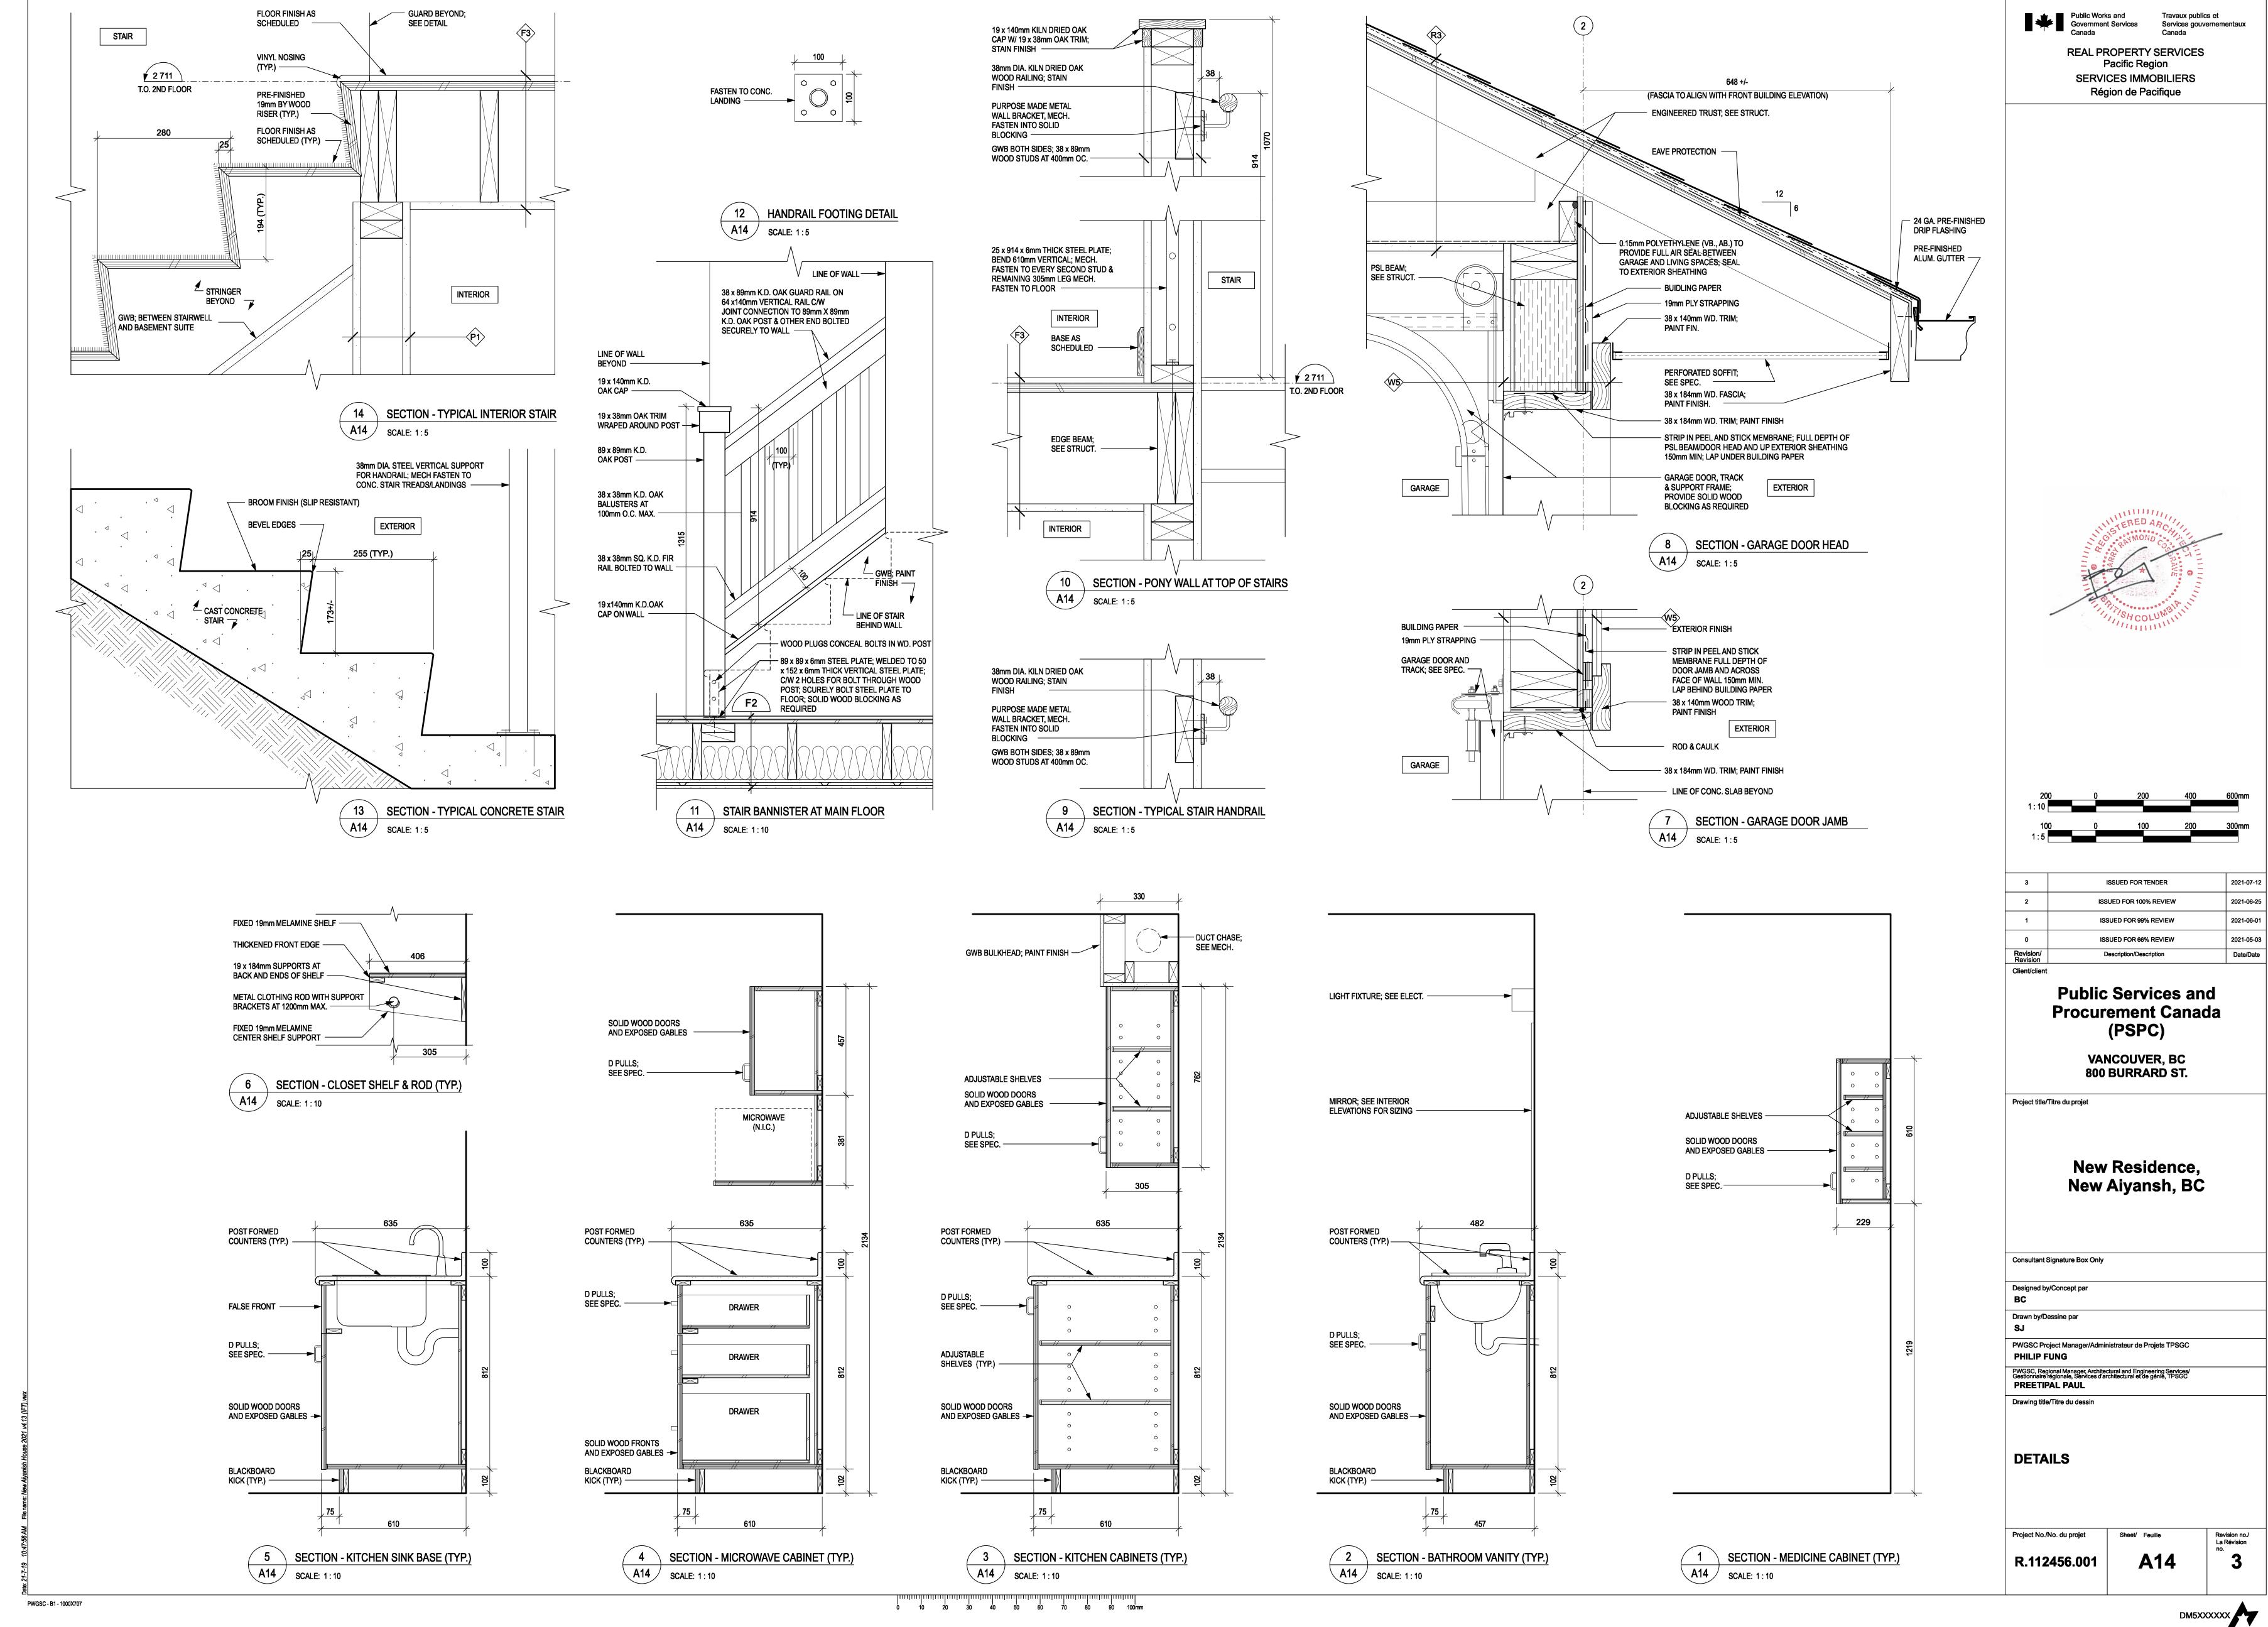

GENERAL

- THIS IS A METRIC PROJECT. UNLESS OTHERWISE NOTED, ALL DIMENSIONS ARE IN MILLIMETERS. PRIOR TO CONSTRUCTION, REVIEW STRUCTURAL DRAWINGS IN CONJUNCTION WITH DRAWINGS
- PROVIDED BY ALL OTHER CONSULTANTS, AND WITH EXISTING CONDITIONS. REPORT DISCREPANCIES TO THE DEPARTMENTAL REPRESENTATIVE BEFORE PROCEEDING WITH
- VERIFY EXISTING DIMENSIONS AND CONDITIONS ON SITE PRIOR TO CONSTRUCTION.
- DO NOT USE INFORMATION ON THESE DRAWINGS FOR ANY OTHER PROJECT OR WORKS.
- DO NOT SCALE THESE DRAWINGS.
- ALL SECTIONS, DETAILS, AND STATEMENTS NOTED AS "TYPICAL" APPLY TO LIKE/SIMILAR CONDITIONS IN THE STRUCTURE.
- SEE ARCHITECTURAL DRAWINGS FOR FIRE RATING AND FIREPROOFING REQUIREMENTS.
- DRAWINGS SHOW COMPLETED STRUCTURE ONLY. THEY DO NOT SHOW TEMPORARY WORKS FOR WHICH THE CONTRACTOR IS RESPONSIBLE AND WHICH MAY BE REQUIRED FOR EXECUTION OF THE PROJECT. THE CONTRACTOR TO ESTABLISH CONSTRUCTION PROCEDURE AND SEQUENCE TO ENSURE SAFETY OF THE WHOLE STRUCTURE AND ALL ITS COMPONENTS DURING ERECTION.
- MAKE ADEQUATE PROVISIONS FOR ALL LOADS ACTING ON THE STRUCTURE DURING ERECTION PROVIDE TEMPORARY SHORING AND BRACING TO KEEP THE STRUCTURE PLUMB AND IN TRUE ALIGNMENT DURING CONSTRUCTION.
- DESIGN OF ALL TEMPORARY WORKS TO BE CARRIED OUT BY A PROFESSIONAL ENGINEER RETAINED BY THE CONTRACTOR, LICENSED IN BRITISH COLUMBIA.
- DESIGN OF NON-STRUCTURAL AND SECONDARY STRUCTURAL ELEMENTS (SUCH AS MISCELLANEOUS 2. STEEL STAIRS, RAILINGS AND GUARDRAILS, PARTITIONS, CLADDING, BULKHEADS, ETC.) IS THE RESPONSIBILITY OF SPECIALTY PROFESSIONAL ENGINEERS ENGAGED BY THE CONTRACTOR OR THE SUPPLIERS; IT IS NOT WITHIN THE SCOPE OF SERVICES PROVIDED BY WSP-S AND WILL NOT BE REVIEWED BY WSP-S.
- CONSTRUCTION LOADS ON COMPLETED STRUCTURE NOT TO EXCEED DESIGN LOADS INDICATED ON DRAWINGS. FULL DESIGN LOADS MAY ONLY BE APPLIED AFTER THE CONCRETE REACHES ITS DESIGN STRENGTH.

DESIGN CRITERIA

- STRUCTURAL DESIGN IS IN ACCORDANCE WITH THE 2015 NATIONAL BUILDING CODE (NBC), SUPPLEMENTED BY THE 2015 NATIONAL BUILDING CODE OF CANADA STRUCTURAL COMMENTARY.
- ALL REFERENCED STANDARDS SHALL BE THE CURRENT EDITION UNLESS DIFFERENT EDITION IS REFERENCED BY THE APPLICABLE BUILDING CODE NOTED ABOVE.
- THE VALUES FOR CLIMATIC DATA USED IN THE DETERMINATION OF DESIGN LOADS HAVE BEEN OBTAINED FROM THE 2015 NBC FOR THE SPECIFIC LOCATION OF TERRACE.
- BASED ON THE USE AND OCCUPANCY, THE BUILDING IS DESIGNED TO THE REQUIREMENTS OF A NORMAL IMPORTANCE CATEGORY.
- SELF WEIGHT (SWT) IS DUE TO THE WEIGHT OF THE STRUCTURE ITSELF. IT VARIES WITH THE STRUCTURAL SYSTEM.
- SUPERIMPOSED DEAD LOADS (SDL) ARE NON-STRUCTURAL DEAD LOADS DUE TO NON-STRUCTURAL TOPPINGS, FINISHES, PARTITIONS, ROOFING MATERIALS, SUSPENDED EQUIPMENT, PAVERS, SOIL,
- 7. DEAD LOAD (DL) IS THE SELF WEIGHT OF THE STRUCTURE PLUS THE SUPERIMPOSED DEAD LOAD.
- UNLESS OTHERWISE NOTED, DESIGN LOADS SHOWN ON DRAWINGS ARE SPECIFIED (UNFACTORED) LOADS, TO BE USED FOR ULS DESIGN. FOR SLS DESIGN, THESE LOADS CAN BE REDUCED BY MULTIPLYING WITH THE RATIO OF APPROPRIATE IMPORTANCE FACTORS Ix(SLS) / Ix(ULS) GIVEN
- IF ONLY ONE VALUE IS GIVEN FOR A LOAD, CONSIDER IT LIVE LOAD.
- SNOW: Ss = 5.4 kPa; Sr = 0.6 kPa; Is (ULS) = 1.0; Is (SLS) = 0.9; Cb = 0.55 MINIMUM UNFACTORED SNOW LOAD = 3.57 kPa x Is
- LATERAL LOADS IN THIS STRUCTURE ARE RESISTED BY SHEAR WALLS AND ARE DETERMINED BASED ON THE WIND AND SEISMIC DATA BELOW. LATERAL DESIGN HAS BEEN BASED ON PRE-SCRIPTIVE MEASURES OF PART 9 LOW LOAD LOCATIONS IN ACCORDANCE WITH SENTENCE 9.23.13.1.(2) OF NBC 2015.
- 12. WIND: q50 = 0.36 kPa; Iw (ULS) = 1.0; Iw (SLS) = 0.75
- TERRAIN TYPE: OPEN INTERNAL PRESSURE CATEGORY: 2

SEISMIC:

Sa (0.2) = 0.138 Rd = 3.0Sa(0.5) = 0.133Ro = 1.7

Sa(1.0) = 0.111le = 1.0Sa(2.0) = 0.080SITE CLASSIFICATION = D PGA = 0.068

SEISMIC FORCE RESISTING SYSTEM (SFRS): NAILED SHEARWALLS - WOOD-BASED PANEL

leFaSa(0.2) = 0.171

FIELD REVIEW

- DEPARTMENTAL REPRESENTATIVE WILL PROVIDE PERIODIC FIELD REVIEW OF A REPRESENTATIVE SAMPLE OF THE STRUCTURAL WORKS DETAILED ON THESE DRAWINGS FOR GENERAL CONFORMANCE WITH CONTRACT DOCUMENTS. THESE REVIEWS DO NOT REPLACE THE CONTRACTOR'S RESPONSIBILITY TO IMPLEMENT AND MAINTAIN A QUALITY CONTROL PROGRAM, AND DO NOT MAKE DEPARTMENTAL REPRESENTATIVE A GUARANTOR OF THE CONTRACTOR'S WORK.
- ASSIST THE DEPARTMENTAL REPRESENTATIVE DOING FIELD REVIEW, AND PROVIDE SAFE ACCESS TO WORK AREAS AS REQUIRED.
- CHECK THE WORK PRIOR TO FIELD REVIEW TO CONFIRM IT IS COMPLETED AND IN ACCORDANCE WITH CONTRACT DOCUMENTS.
- NOTIFY THE DEPARTMENTAL REPRESENTATIVE 12 BUSINESS DAYS PRIOR TO CONCRETE POURS, BACKFILLING, AND COVERING UP THE STRUCTURE WITH FINISHES.

FOUNDATIONS

PWGSC - B1 - 1000X707

- STRUCTURAL DESIGN IS BASED ON THE GEOTECHNICAL REPORT PREPARED BY WOOD ENVIRONMENT AND INFRASTRUCTURE SOLUTIONS; REPORT NUMBER KA21195; DATED OCTOBER 13, 2020 AND SUPPLEMENTAL MEMO REGARDING LATERAL EARTH PRESSURES DATED MARCH 16, 2021. REFER TO GEOTECHNICAL REPORT FOR ADDITIONAL FOUNDATION AND EARTHWORK INFORMATION.
- SET FOUNDATIONS ON HORIZONTAL UNDISTURBED SOIL CAPABLE OF SUPPORTING BEARING PRESSURE OF 200 kPa AT ULS AND 150 kPa AT SLS.
- PRIOR TO PLACING FOOTINGS, BEARING CAPACITY OF EACH FOOTING TO BE CONFIRMED IN WRITTEN REPORTS BY THE GEOTECHNICAL ENGINEER RETAINED BY THE DEPARTMENTAL REPRESENTATIVE. SUBMIT EACH REPORT IMMEDIATELY TO THE DEPATMENTAL REPRESENTATIVE.
- FOR FROST PROTECTION, MINIMUM DISTANCE FROM FINISHED GRADE TO UNDERSIDE OF FOUNDATIONS TO BE NOT LESS THAN 1000mm OR PROVIDE EQUIVALENT INSULATION. WHERE UNDERSIDES OF WALLS, GRADE BEAMS, OR PILE CAPS ARE NOT BELOW THE FROST PROTECTION DEPTH, PROVIDE FROST CUSHION BETWEEN SOIL AND STRUCTURE WHERE FROST ACTION MAY CAUSE UPLIFT.
- UNLESS OTHERWISE NOTED, CENTRE FOOTINGS, PIERS, PILES, AND PILE CAPS UNDER CENTROID OF COLUMNS. WHERE THERE ARE NO COLUMNS ABOVE, CENTRE UNDER WALLS OR GRADE BEAMS.
- LOCATE ALL EXISTING UNDERGROUND SERVICES PRIOR TO EXCAVATION.
- THE LINE OF SLOPE BETWEEN ADJACENT EXCAVATIONS FOR FOOTINGS OR TRENCHES NOT TO EXCEED A RISE OF 1 IN A RUN OF 3/4.
- PROTECT FOOTINGS, PIERS, PILE TOPS, PILE CAPS, GRADE BEAMS, FOUNDATION WALLS, SLABS-ON-GRADE AND ADJACENT SOIL AGAINST FREEZING AND FROST ACTION AT ALL TIMES DURING CONSTRUCTION. DO NOT POUR CONCRETE AGAINST FROZEN EARTH.
- DO NOT PLACE CONCRETE IN WATER OR ON FROZEN SOIL.
- UNLESS NOTED OTHERWISE, PROVIDE DRAINAGE WITH WEEPING TILES TIED INTO MECHANICAL DRAINAGE SYSTEM AT ALL WALLS RETAINING EARTH. IF WEEPING TILE IS NOT LOCATED ON THE SIDE OF THE WALL RETAINING EARTH, PROVIDE MIN. 50 (2") DIA. WEEPERS AT MAX 2000 (6'-8") O/C THROUGH THE WALL. LOCATE JUST ABOVE TOP OF FOOTING.
- IF A RETAINING WALL DOES NOT HAVE A WEEPING TILE BEHIND IT, PROVIDE MIN. 50 (2") DIA. WEEPERS AT MAX 2000 (6'-8") O/C THROUGH THE WALL LOCATE 200 (8") ABOVE THE LOWER GRADE
- 12. DO NOT BACKFILL AGAINST WALLS RETAINING EARTH UNTIL ELEMENTS PROVIDING LATERAL SUPPORT, INCLUDING SLABS ON GRADE AND SUSPENDED LEVELS, ARE COMPLETED AND CONCRETE HAS REACHED 75% OF ITS DESIGN STRENGTH.
- WHERE SLAB ON GRADE IS USED TO TIE THE TOP OF A WALL RETAINING EARTH, PROVIDE TEMPORARY SHORING OF THE WALL FROM START OF BACKFILLING UNTIL THE SLAB ON GRADE REACHES 75% OF ITS DESIGN STRENGTH.
- FOR ELEMENTS THAT ARE TO BE BACKFILLED ON BOTH SIDES. PLACE BACKFILL SIMULTANEOUSLY ON BOTH SIDES SUCH THAT HEIGHTS DO NOT VARY BY MORE THAN 600 (2') FROM ONE SIDE TO THE

CONCRETE

- REFER TO SPECIFICATIONS FOR CONCRETE REQUIREMENTS.
- CONCRETE TO BE IN ACCORDANCE WITH THE FOLLOWING MIX TYPES:

MIX TYPE 1:

- EXPOSURE CLASS: N
- MINIMUM COMPRESSIVE STRENGTH AT 28 DAYS: 25 MPa. INTENDED APPLICATION: INTERIOR LOCATIONS, BASEMENT SLAB ON GRADE.
- NOMINAL SIZE OF COARSE AGGREGATE: 20 (3/4")

MIX TYPE 2:


- EXPOSURE CLASS: F-2 MINIMUM COMPRESSIVE STRENGTH AT 28 DAYS: 25 MPa INTENDED APPLICATION: FOOTINGS, BASEMENT WALLS, AND FOUNDATION WALLS AND PIERS.
- NOMINAL SIZE OF COARSE AGGREGATE: 20 (3/4")


- EXPOSURE CLASS: C-2 MINIMUM COMPRESSIVE STRENGTH AT 28 DAYS: 32 MPa
- INTENDED APPLICATION: GARAGE SLAB ON GRADE, EXTERIOR SLABS ON GRADE, RAMPS, AND
- NOMINAL SIZE OF COARSE AGGREGATE: 20 (3/4")


CONCRETE REINFORCEMENT

- ALL REINFORCING BAR SIZES ARE METRIC; "M" IS NOT NECESSARILY MARKED AFTER A BAR SIZE. FOR EXAMPLE, 10-15B NOTED ON PLAN INDICATES 10 BARS OF 15M DIAMETER, PLACED AT BOTTOM.
- ALL REBAR HOOKS TO BE STANDARD LENGTH 90° OR 180° HOOKS. REBAR LENGTHS LISTED ON DRAWINGS DO NOT INCLUDE THE HOOK LENGTH.
- FOR LAP LENGTHS AND DEVELOPMENT LENGTHS, REFER TO TABLES BELOW. FOR 32 MPa CONCRETE USE LAP LENGTHS FOR 30 MPa.
- UNLESS OTHERWISE NOTED, LAP ALL HORIZONTAL REINFORCING WITH CLASS B LAPS. PROVIDE CORNER BARS AT CORNERS TO MATCH HORIZONTAL REINFORCING.
- WHERE CONCRETE IS CAST AGAINST AND PERMANENTLY EXPOSED TO EARTH, MINIMUM CONCRETE COVER TO REINFORCING BARS CLOSEST TO THE CONCRETE SURFACE TO BE 75 (3").
- UNLESS OTHERWISE NOTED, MINIMUM CONCRETE COVER TO REINFORCING BARS CLOSEST TO THE CONCRETE SURFACE TO BE 40 (11/2") FOR BEAMS AND COLUMNS AND 25 (1") FOR SLABS AND WALLS
- FOR CLASS F-1 AND F-2 CONCRETE, MINIMUM COVER TO BE 40 (1 1/2").
- INCREASE COVER WHERE REQUIRED TO MAINTAIN MINIMUM RATIO OF COVER TO NOMINAL BAR DIAMETER OF 1 FOR CLASS N, 1.5 FOR CLASSES F1 AND C1 (FOR MEMBRANE PROTECTED SLABS ONLY), AND 2 FOR CLASS C1 (ALL OTHER STRUCTURES).

BAR	f'c =	= 25	f'c :	= 30	f'c = 35		
SIZE	BOT	TOP	ВОТ	TOP	ВОТ	TOF	
10M	300	380	300	350	300	320	
15M	440	570	400	520	370	480	
20M	580	750	530	690	490	640	
25M	900	1170	830	1070	770	990	
				,	ENGTH		
BAR		= 25	f'c :	= 30	f'c =	= 35	
BAR SIZE	f'c =	= 25				= 35	
			f'c :	= 30	f'c =	= 35	
SIZE	ВОТ	TOP	f'c =	= 30	f'c =	= 35 TOF	
SIZE 10M	BOT 390	TOP 490	f'c = BOT 390	= 30 TOP 450	f'c = BOT 390	= 35 TOF 420 620	
10M 15M	BOT 390 570	TOP 490 740	fc = BOT 390 520	= 30 TOP 450 670	fc = BOT 390 480		

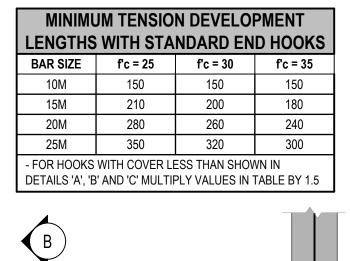

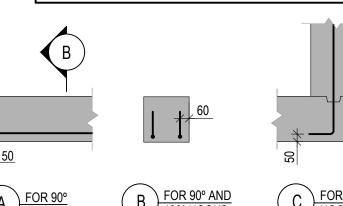

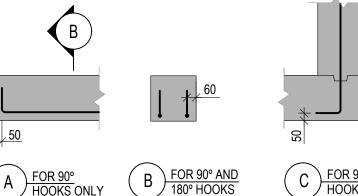

POST-INSTALLED ANCHORS AND DOWELS

- REFER TO SPECIFICATION SECTION 03 30 00 FOR POST-INSTALLED ANCHOR AND DOWEL REQUIREMENTS.
 - DCA DRILLED CONCRETE ANCHORS.
 - DCA DRILLED CONCRETE ANCHORS. ACA - ADHESIVE CONCRETE ANCHORS.

STRUCTURAL WOOD

- - LUMBER: TO CSA 141; KILN DRIED; SPF NO. 2 OR BETTER; MOISTURE CONTENT MAX 19%
 - PLYWOOD SHEATHING: TO CSA 0151 SOFTWOOD SPRUCE; OR CSA 0121 DOUGLAS FIR
 - OSB SHEATHING: TO CSA O325, O-1 GRADE OR O-2 GRADE - LAMINATED VENEER LUMBER (LVL): MINIMUM GRADE 2.0E, 2500Fb (Fb=31.9MPa) OR BETTER
- PARALLEL STRAND LUMBER (PSL): MINIMUM GRADE 2.0E, 2900Fb (Fb=37MPa) NAILS: COMMON ROUND STEEL WIRE NAILS
- WOOD BOLTS: ASTM A307 LAG SCREWS: ANSI/ASME B18.12.1 MACHINE THREADED
- WOOD CONNECTORS: REFER TO SPECIFICATION SECTION 06 10 00 FOR REQUIREMENTS
- UNLESS NOTED OTHERWISE, BUILT-UP TIMBER COLUMNS AND STUDS TO BE FASTENED AS PER TYPICAL DETAIL TW-FAST-01.
- UNLESS NOTED OTHERWISE ON PLAN, BUILT-UP BEAMS TO BE FASTENED AS PER TYPICAL DETAIL TW-FAST-02.

ABBREVIATIONS

BOTTOM BETWEEN BTWN -CCJ CRACK CONTROL JOINT CLR CLEAR CONCRETE MASONRY UNITS CMU COL COLUMN

CONC CONCRETE CONTINUOUS CONT COMPLETE WITH DEEP EXISTING EACH EACH END EACH FACE ELEVATION

EMBEDMENT EACH SIDE EACH WAY FOUNDATION FOOTING GALVANIZED

GRID LINE HORIZONTAL EACH FACE HORIZ HORIZONTAL H1E HOOK ONE END

H2E HOOK BOTH ENDS HOLD DOWN HDG HOT DIPPED GALVANIZED

LONG LLH LONG LEG HORIZONTAL LLV LONG LEG VERTICAL

NEW NTS NOT TO SCALE ON CENTER

OPP OPPOSITE OWSJ OPEN WEB STEEL JOIST PLATE

PRESSURE TREATED REINFORCEMENT REINF REQUIRED REINFORCE WITH SIMILAR

SLAB ON GRADE STAINLESS STEEL SST SIMPSON STRONG TIE

STAGGERED STD STANDARD STIFFENER T&B TOP AND BOTTOM

TYP TYPICAL UNLESS NOTED OTHERWISE U/S UNDERSIDE

VERT VERTICAL VERTICAL INSIDE FACE VERTICAL OUTSIDE FACE

VOF -WSP-S - WSP STRUCTURAL

T/O

Public Works and Government Services

Travaux publics et Services gouvernementaux

REAL PROPERTY SERVICES Pacific Region SERVICES IMMOBILIERS Région de Pacifique





JOB No. 211-02781-00



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0	ISSUED FOR 66% REVIEW	2021-05-03
Revision/	Description/Description	Date/Date

Services (PTS) **PACIFIC REGION**

VANCOUVER, BC

800 BURRARD ST.

Professional and Technical

Project title/Titre du projet

New Residence, New Aiyansh, BC

Consultant Signature Box Only

CHELSEA PATON, P.ENG Drawn by/Dessine par

Designed by/Concept par

GINA MAJOR PWGSC Project Manager/Administrateur de Projets TPSGC PHILIP FUNG

PWGSC, Regional Manager, Architectural and Engineering Services/ Gestionnaire régionale, Services d'architectural et de génie, TPSGC PREETIPAL PAUL

Drawing title/Titre du dessin **NEW EMPLOYEE HOUSING** SINGLE FAMILY HOUSE


GENERAL NOTES


Project No./No. du projet R.112456.001


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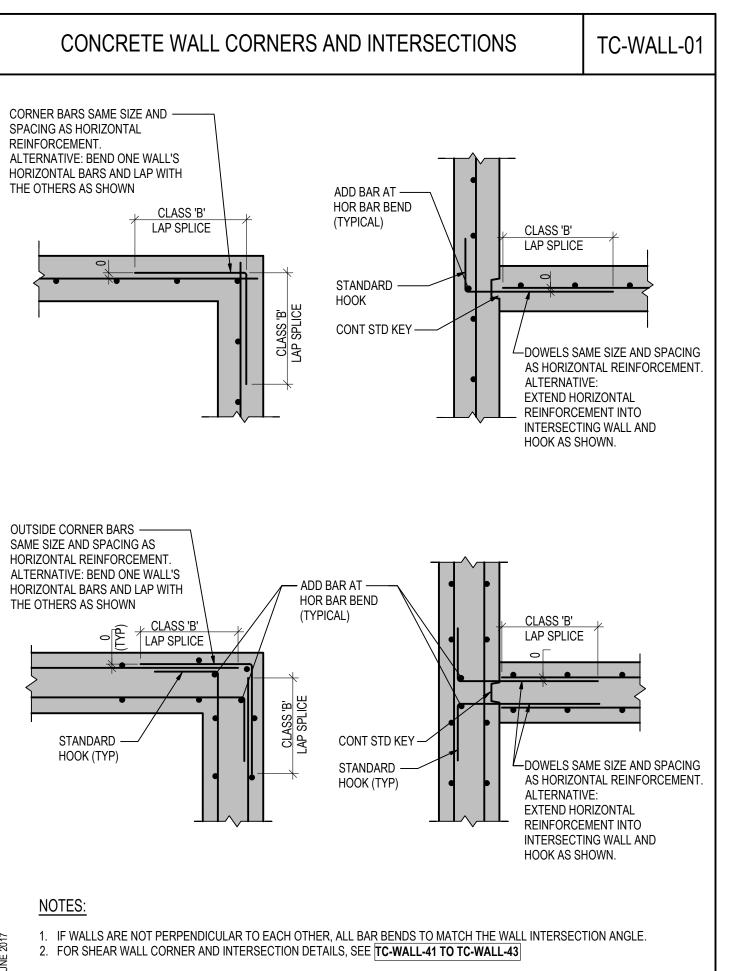



La Révision




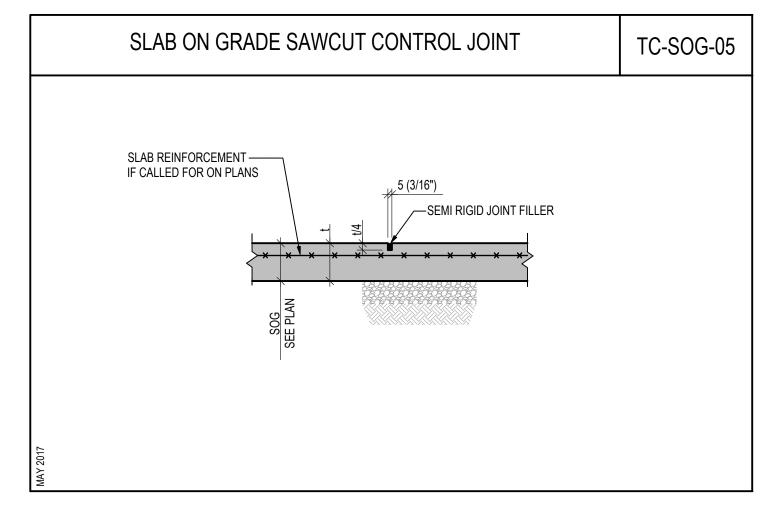

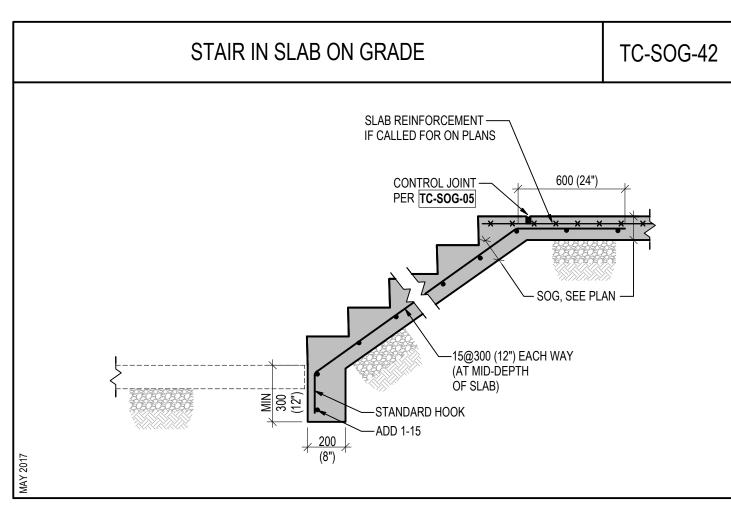

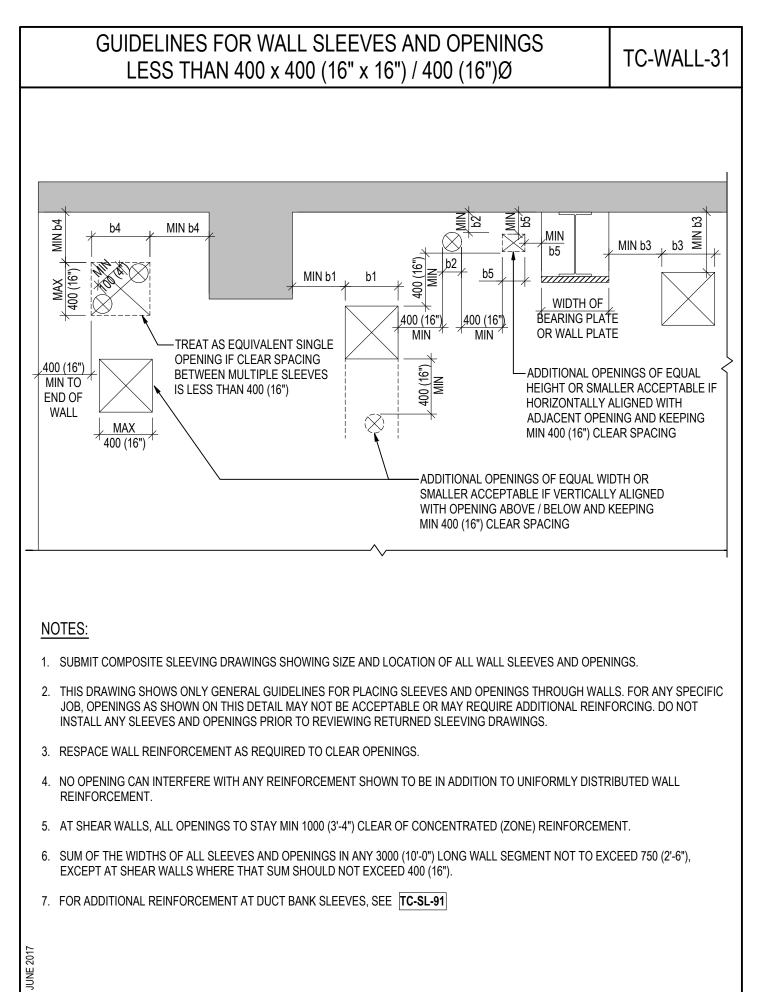

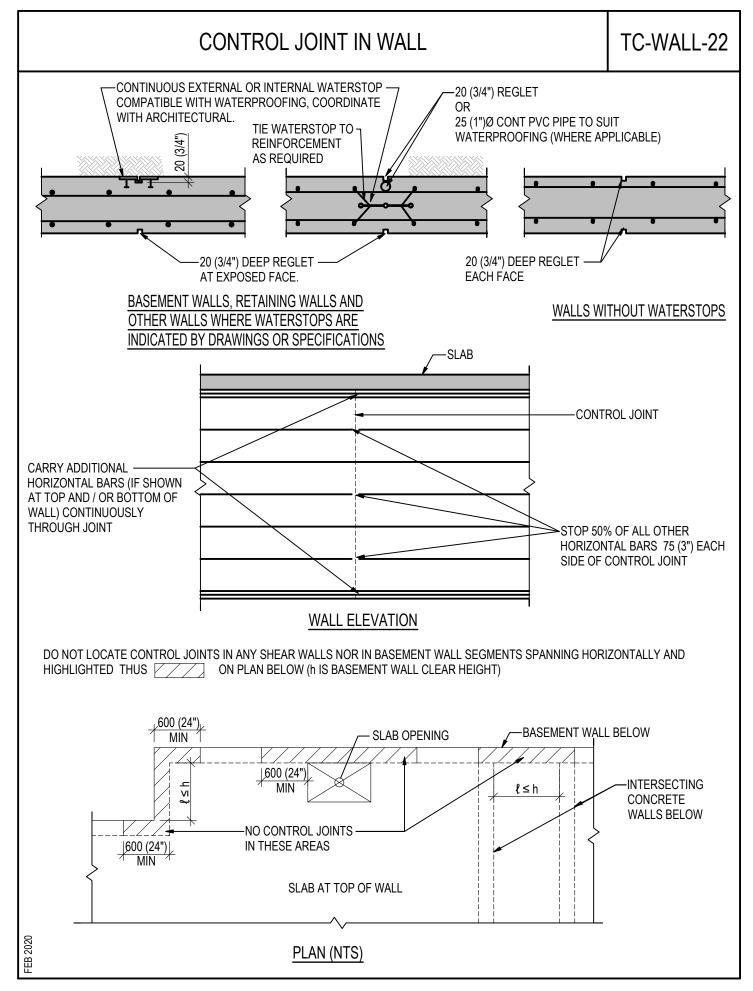

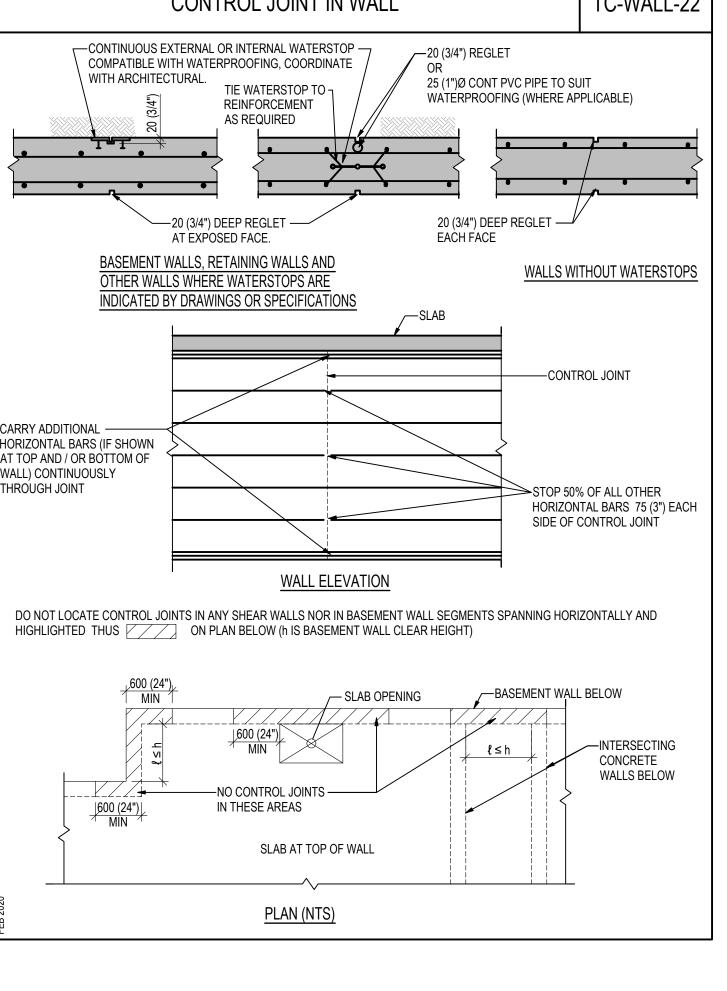



Public Works and Government Services

REAL PROPERTY SERVICES

Pacific Region

SERVICES IMMOBILIERS

Région de Pacifique

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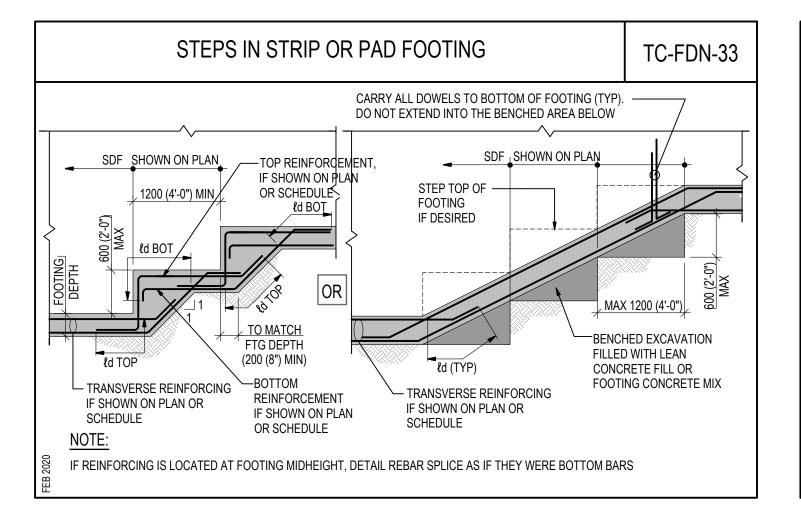
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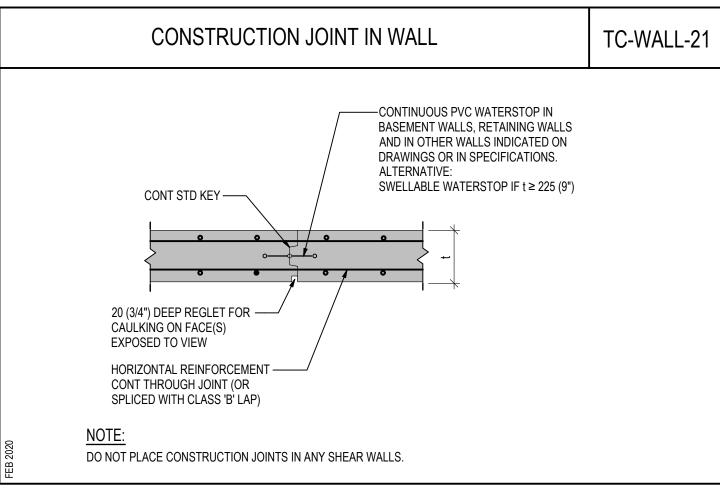
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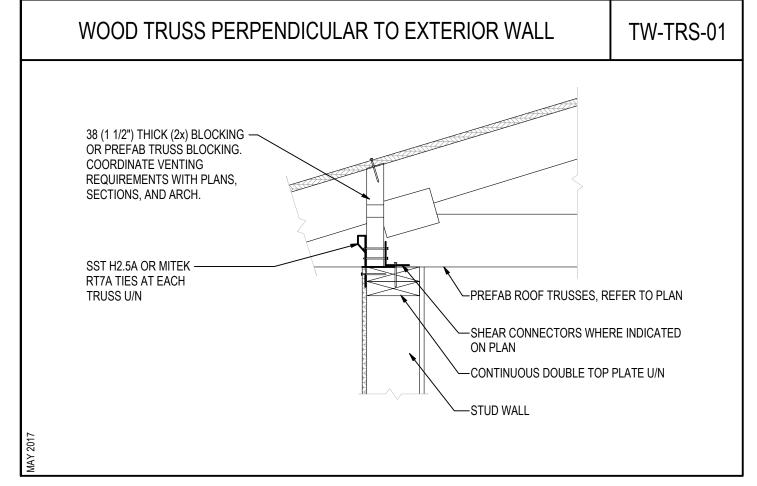
SINGLE FAMILY HOUSE


TYPICAL DETAILS


S-1.02 R.112456.001









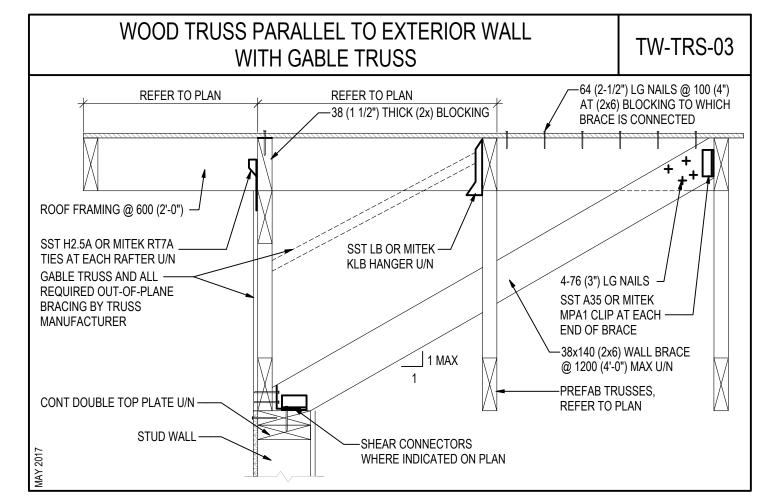

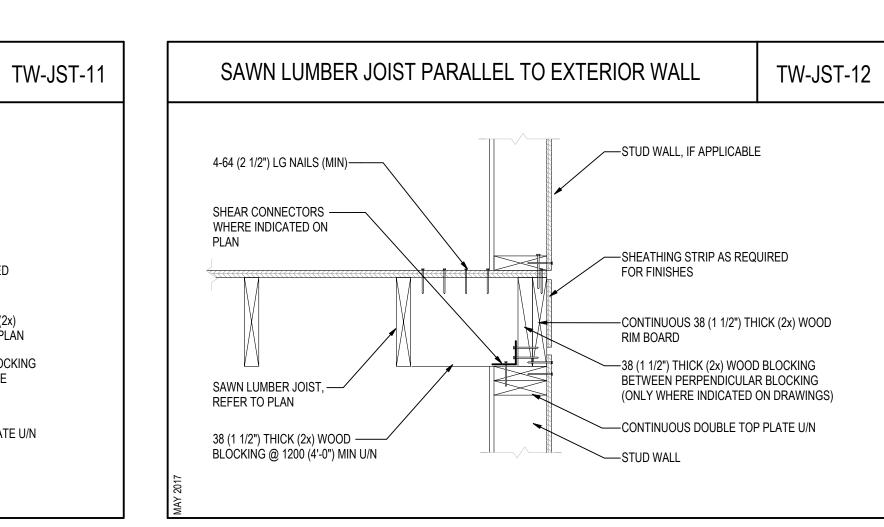

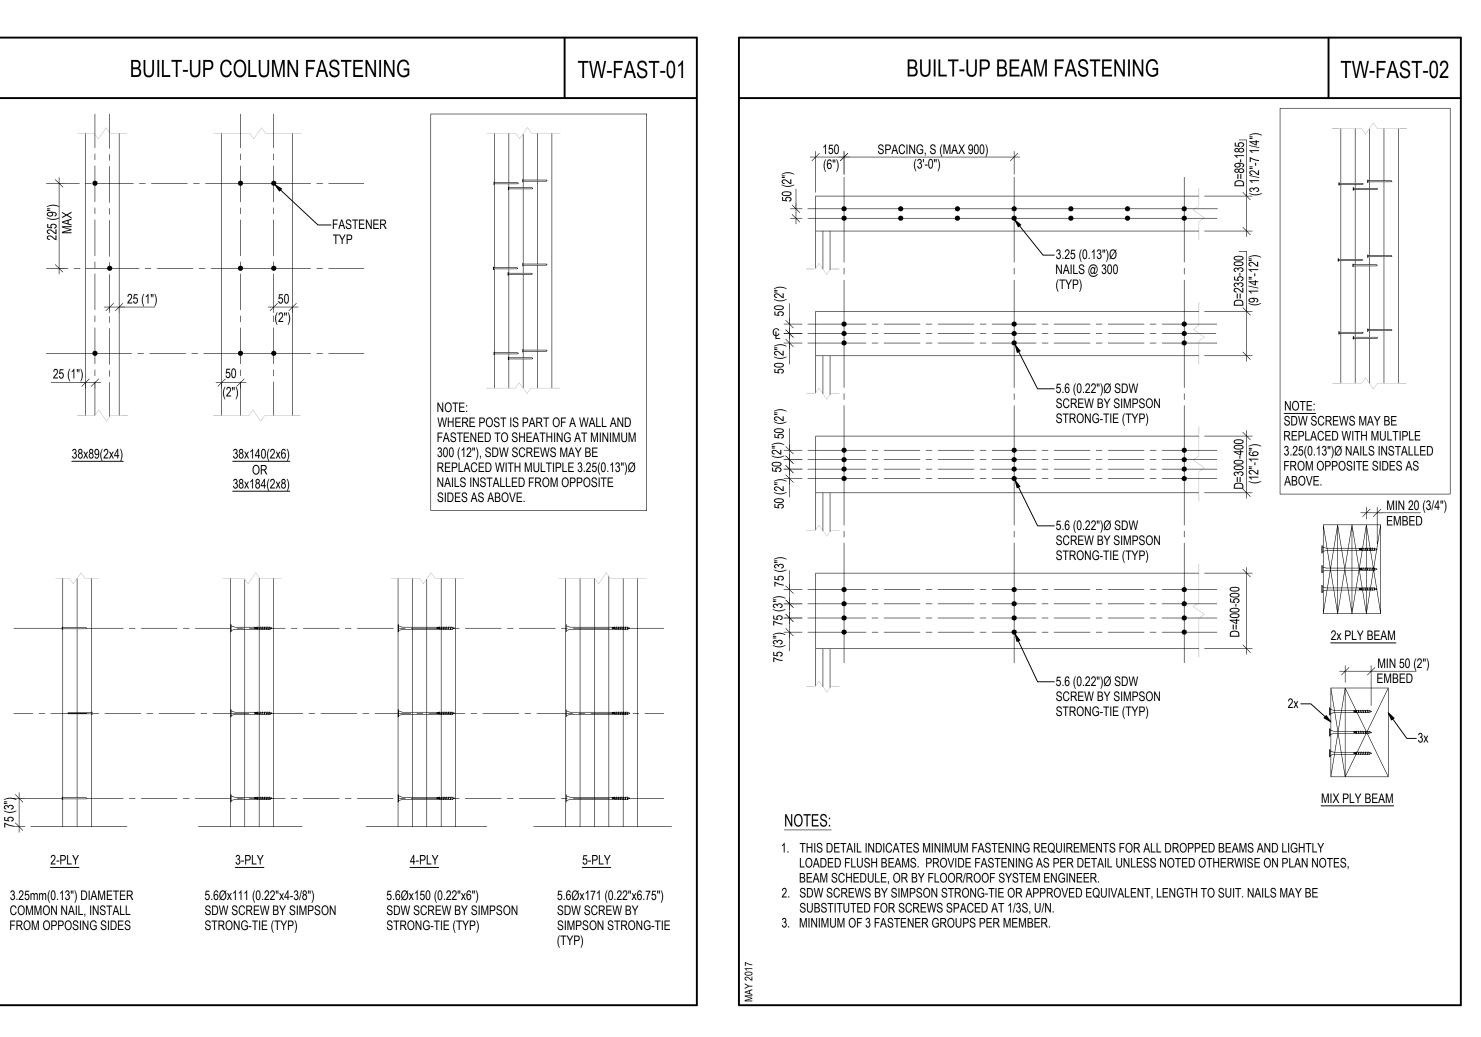

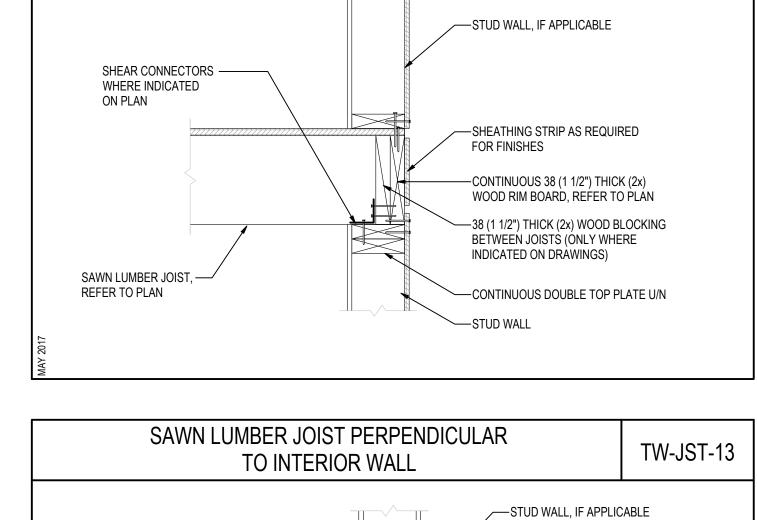

---38 (1 1/2") THICK (2x) WOOD

INDICATED ON PLAN


-STUD WALL


BLOCKING BETWEEN EVERY JOIST

— ADDITIONAL 38 (1 1/2") THICK (2x) WOOD BLOCKING WHERE

SAWN LUMBER JOIST PERPENDICULAR

TO EXTERIOR WALL

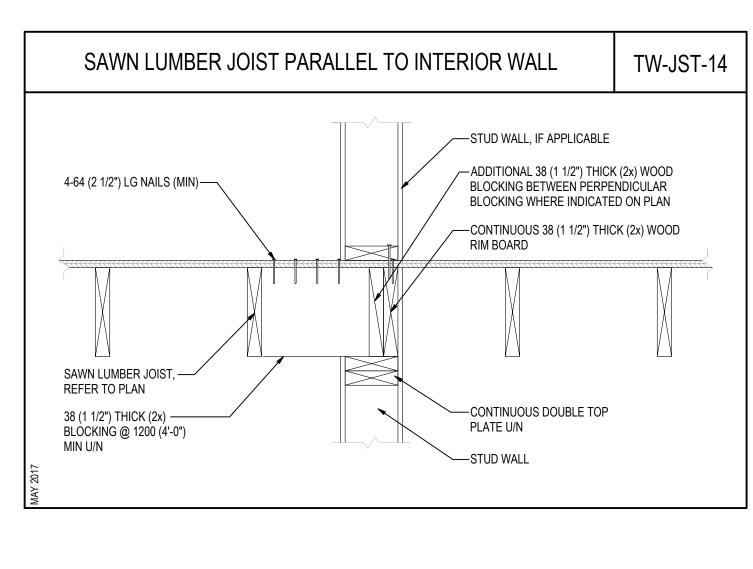

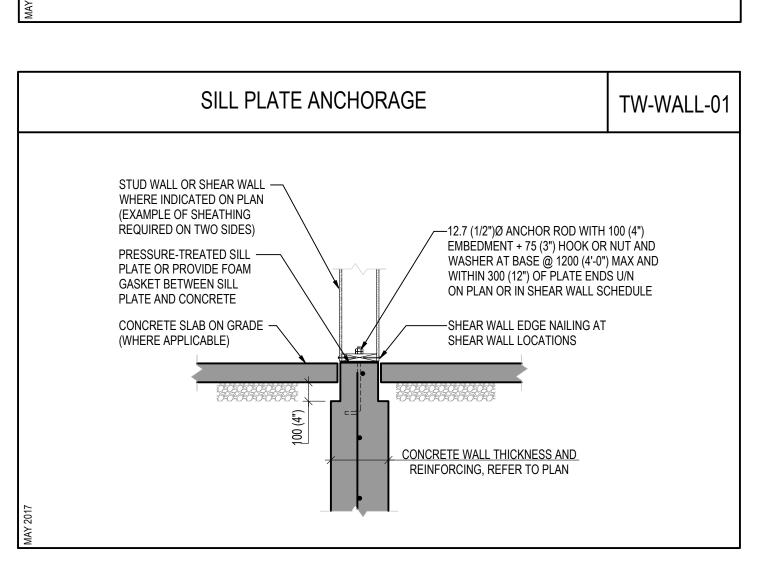


SAWN LUMBER JOIST,


64 (2 1/2") MIN BEARING U/N

CONTINUOUS DOUBLE TOP

REFER TO PLAN.

PLATE U/N

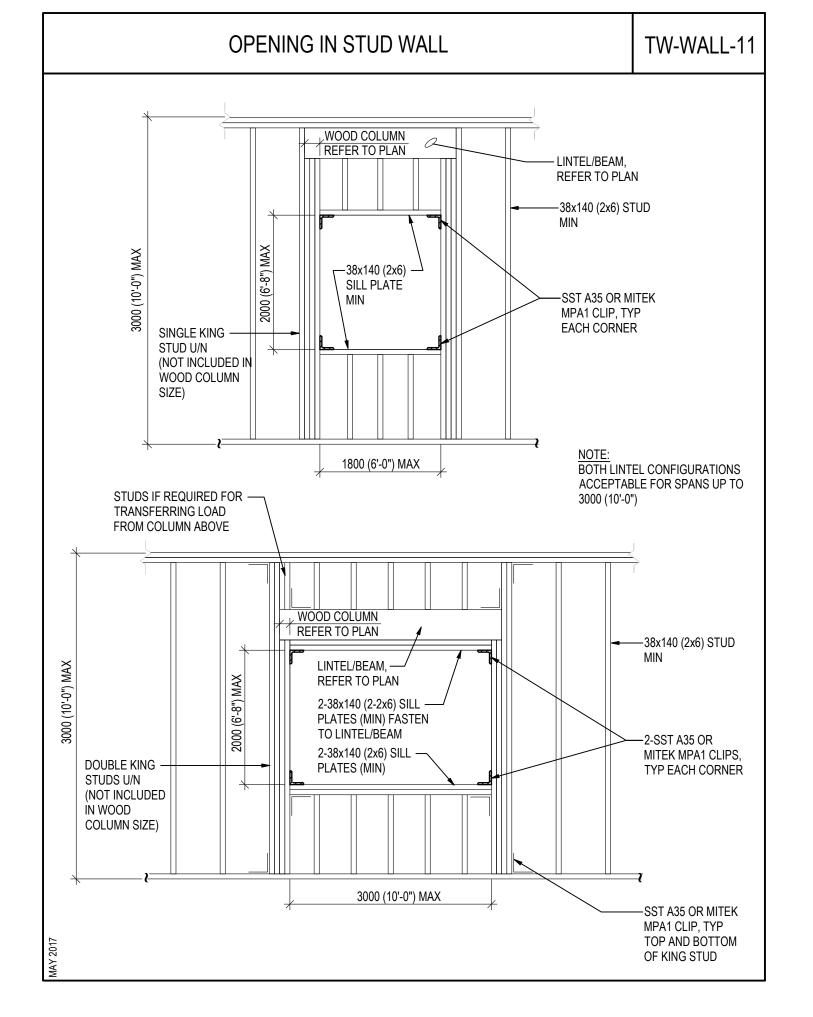

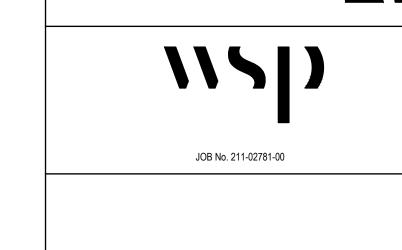

number TEN architectural group

Public Works and
Government Services

REAL PROPERTY SERVICES Pacific Region

SERVICES IMMOBILIERS

Région de Pacifique

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Drawn by/Dessine par

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PHILIP FUNG

PWGSC, Regional Manager, Architectural and Engineering Services/ Gestionnaire régionale, Services d'architectural et de génie, TPSGC PREETIPAL PAUL

Drawing title/Titre du dessin

NEW EMPLOYEE HOUSING

SINGLE FAMILY HOUSE

TYPICAL DETAILS

S-1.03 R.112456.001










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Drawing title/Titre du dessin

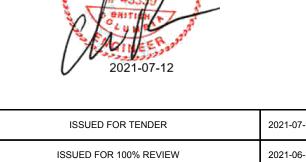NEW EMPLOYEE HOUSING SINGLE FAMILY HOUSE

FOUNDATION PLAN AND MAIN FLOOR FRAMING PLAN

S-2.01 R.112456.001

450x250DP STRIP FOOTING R/W 2-15M CONT, TYP 150DP SLAB ON GRADE R/W 10M @ 250 EW AT MID-DEPTH OF SLAB C/W CRACK CONTROL JOINTS @ 3750 OC MAX - BEAM POCKET SIM TO 9/S4.01 GUARDRAIL ALONG TOP OF WALL (BY OTHERS) DOUBLE JOIST ----(FLUSH) — 140x140 POSTS, TYP AT ENTRY H2, TYP AT JOISTS TO BEAM FOR BEAM POCKET SEE 9/S4.01 SST PB66 OR MITEK WE66 POST BASE - 140x140 SPF POST (PT), TYP 150DP SLAB ON GRADE R/W 10M @ 250 EW AT MID-DEPTH OF SLAB - 38x235 FLOOR JOISTS @ 400 OC MAX, TYP — 38x184 SPF CONT OVER SUPPORTS C/W 38x235 RIM BOARD (PT) 100DP SLAB ON GRADE H6, TYP AT PLYWOOD FLOOR SIM TO PATIO SLAB JOISTS TO SHEATHING FOUNDATION -38x184 SPF JOISTS @ 400 OC MAX (PT) - 38x184 SPF LEDGER (PT) GUARDRAIL ALONG TOP OF ALL NAILS USED IN PRESERVATIVE WALL (BY OTHERS) ____ TREATED (PT) WOOD TO BE STAINLESS STEEL, ALL BOLTS TO BE HDG 192x192 D.FIR #1 CANOPY POST (PT, NOT INCISED), TYP SST CBGT88 POST BASE OR APPROVED EQUIVALENT, TYP ALL NAILS USED IN PRESERVATIVE TREATED (PT) WOOD TO BE STAINLESS STEEL, ALL BOLTS TO BE HDG

> BASEMENT PLAN SHOWING MAIN FLOOR FRAMING OVER S-2.01 SCALE: 1:50

1352

WOOD FRAMING LEGEND **————** WOOD BEAM A = NO. OF PLYS IN BUILT-UP COL B = NOMINAL STUD DEPTH (6 = 2x6)

REFER TO TC-SOG-42

FOR STAIR ON GRADE

SC = SINGLE CRIPPLE DC = DOUBLE CRIPPLE TC = TRIPLE CRIPPLE _ WOOD FLOOR JOISTS

CONCRETE RETAINING WALL SCHEDULE FOOTING REINFORCING WALL REINFORCING 15M@200 VOF 20M@200 VIF 15M@400 BOT H1E 25M@200 TOP H2E 10M@400 HEF 15M@400 BOT H1E 20M@250 TOP H2E 15M@300 VEF 10M@400 HEF 15M@400 VERT 15M@400 BOT H1E 15M@400 TOP H2E 10M@400 HORIZ PROVIDE VERTICAL HOOKED DOWELS INTO FOOTING AT ALL VERTICAL WALL REINFORCING SEE PLAN FOR FOOTING DIMENSIONS AND SEE SECTION FOR FURTHER DETAIL

WALL CRACK

CONTROL JOINT

WITH WATERSTOP

AS PER TC-WALL-22

250x250 PIER R/W

10M TIES @ 200 —

SLAB CRACK

UN-REINFORCED 100DP SLAB ON GRADE C/W CRACK CONTROL JOINTS

@ 2500 OC MAX ON MIN 100 GRANULAR

BASE COMPACTED TO 95% MODIFIED

FOUNDATION / BASEMENT PLAN

PROCTOR (BROOM FINISH)

350x350 PILASTER, SEE 11/S4.01 ——— CONTROL JOINT AS

PER TC-SOG-05, TYP

4-10M VERTS +

100DP SLAB ON GRADE

MID-DEPTH OF SLAB

CONC STEP R/W 2-10M, SEE ARCH

FOR DIMENSIONS

S-2.01 SCALE: 1:50

- 900x900x300DP PAD FOOTING R/W

4-15M EW BOT

600x600x300DP

3-15M EW BOT

BELOW GRADE)

250x250 PIER R/W4-10M VERTS +

10M TIES @ 200

- STEPPED

FOOTING

1500

PAD FOOTING R/W

(U/S FTG MIN 1000

200 WIDE CONCRETE

450x250DP STRIP

CONCRETE LEDGE,

REFER TO 7/S-4.01 —

250DP RETAINING

WALL FOOTING, TYP

SEE SCHEDULE -

FOOTING R/W 2-15M

CONT, TYP UNO ----

FOUNDATION WALL, TYP —

	HANGER SCHEDULE								
MARK	HANGER	REMARKS							
H1	SST LUS28-2 OR MITEK JUS28-2	6-16d NAILS TO SUPPORT 4-16d NAILS TO BEAM / JOIST							
H2	SST HU610 OR	16-16d NAILS TO SUPPORT 8-10d NAILS TO BEAM / JOIST							
П	MITEK HD610	20-16d NAILS TO SUPPORT 10-16d NAILS TO BEAM / JOIST							
Н3	SST U210 OR MITEK SUH210	10-10d NAILS TO SUPPORT 6-10dx38LG NAILS TO BEAM / JOIST							
H4	SST LUS28-2	10d NAILS							
Π4	MITEK JUS28-2	16d NAILS							
H5	SST LUS26 OR MITEK JUS26	10dx38LG NAILS TO SUPPORTING MEMBER							
Н6	SST JB210A OR MITEK HL210	4-10dx38LG NAILS TO NAILER							

ALL STEEL OUTSIDE THE BUILDING ENVELOPE TO BE

HOT-DIPPED GALVANIZED

A = NO. OF KING STUDS B = NOMINAL STUD DEPTH (6 = 2x6)XX = NO. OF CRIPPLES:

PRE-ENGINEERED WOOD TRUSSES

PWGSC - B1 - 1000X707









JOB No. 211-02781-00

SCALE 1:50 SCALE IN MILLIMETRES

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Dovision/	December 19 and	D + 1D +

Professional and Technical Services (PTS) PACIFIC REGION

VANCOUVER, BC 800 BURRARD ST.

Project title/Titre du projet

New Residence, New Aiyansh, BC

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Designed by/Concept par CHELSEA PATON, P.ENG

Drawn by/Dessine par **GINA MAJOR**

PWGSC Project Manager/Administrateur de Projets TPSGC PHILIP FUNG

PWGSC, Regional Manager, Architectural and Engineering Services/ Gestionnaire régionale, Services d'architectural et de génie, TPSGC


PREETIPAL PAUL


Drawing title/Titre du dessin

NEW EMPLOYEE HOUSING SINGLE FAMILY HOUSE

UPPER FLOOR AND ROOF FRAMING PLANS

S-2.02 R.112456.001

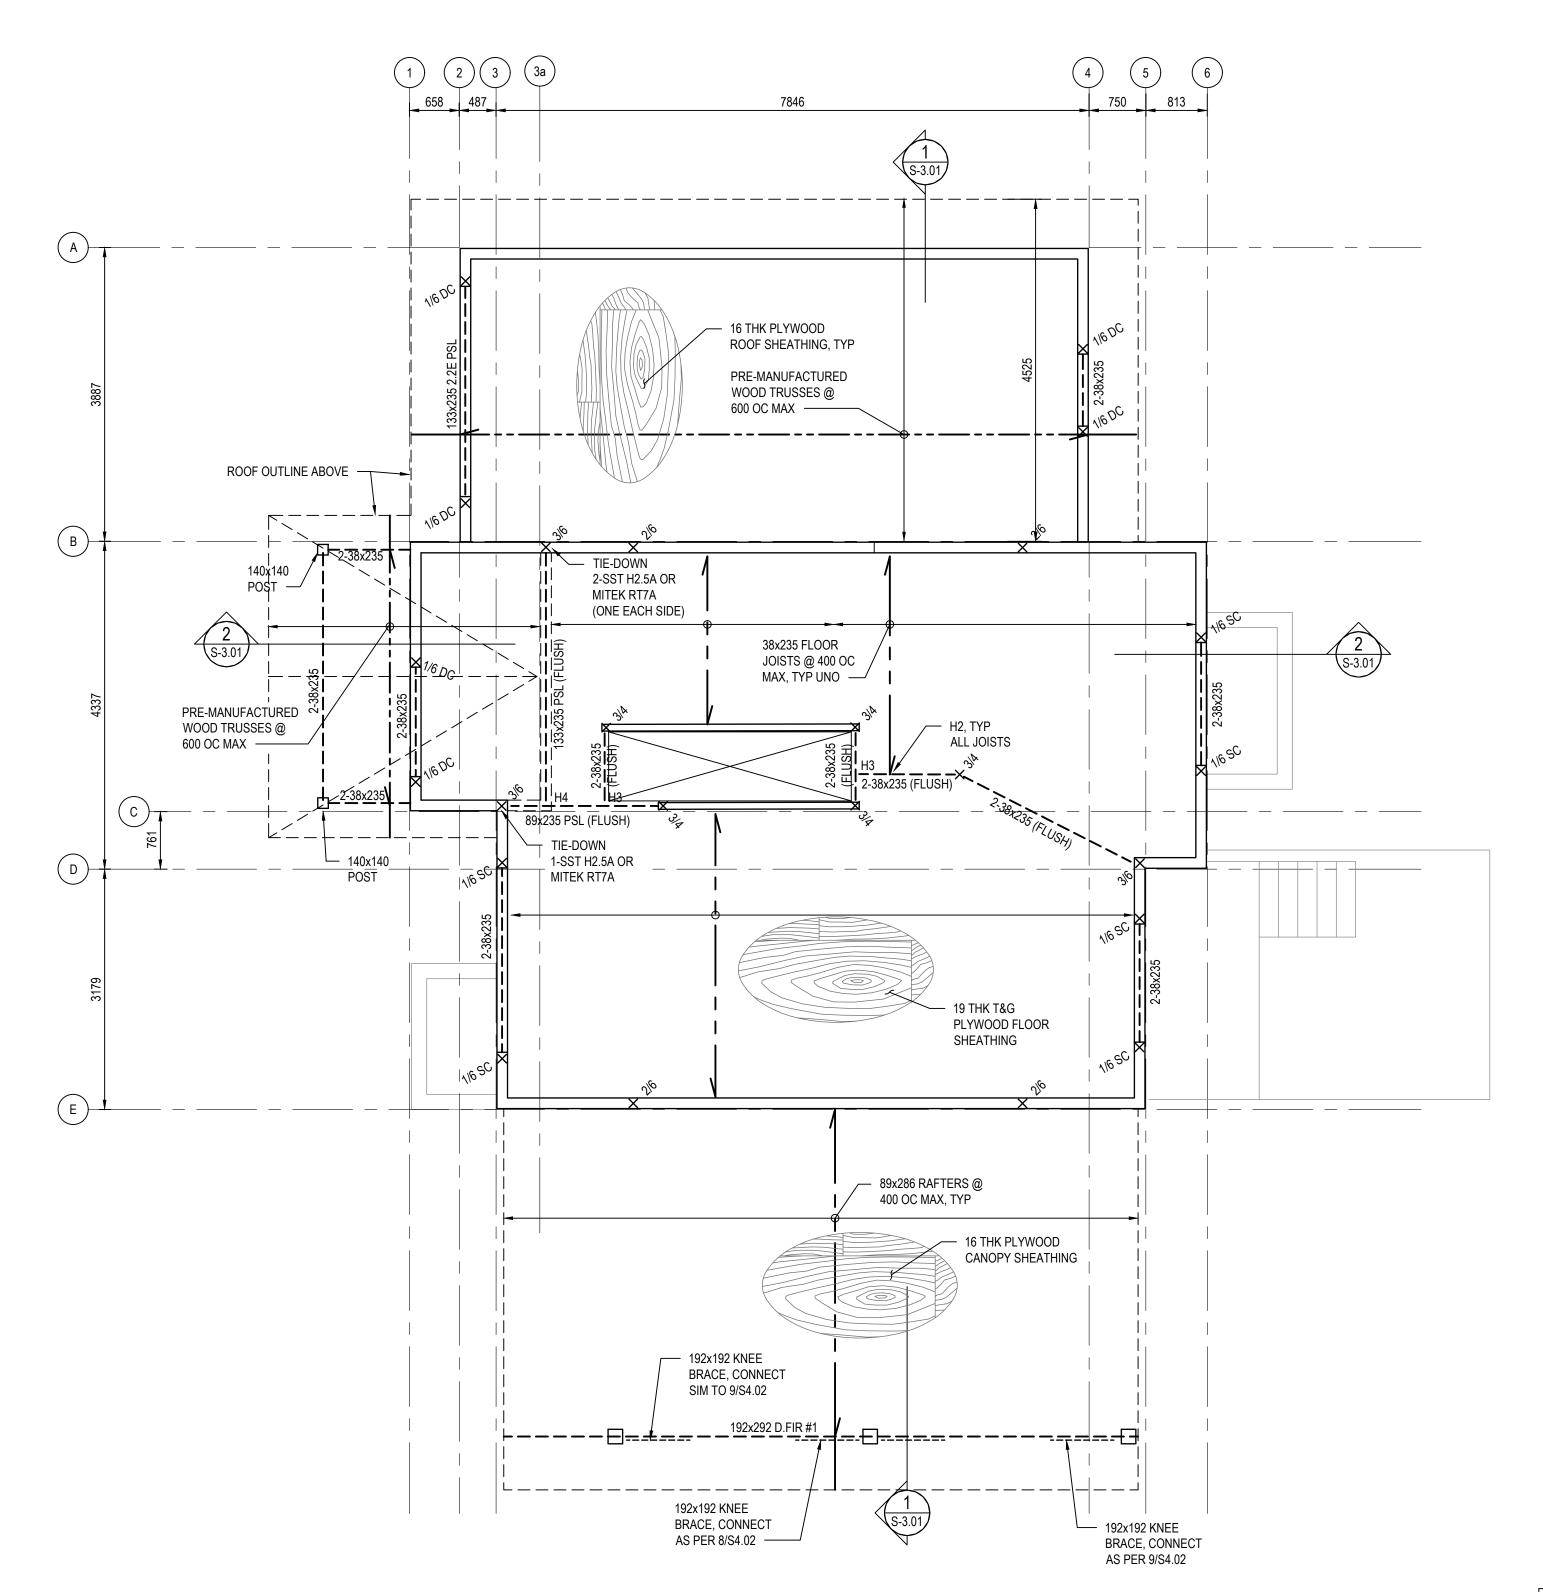

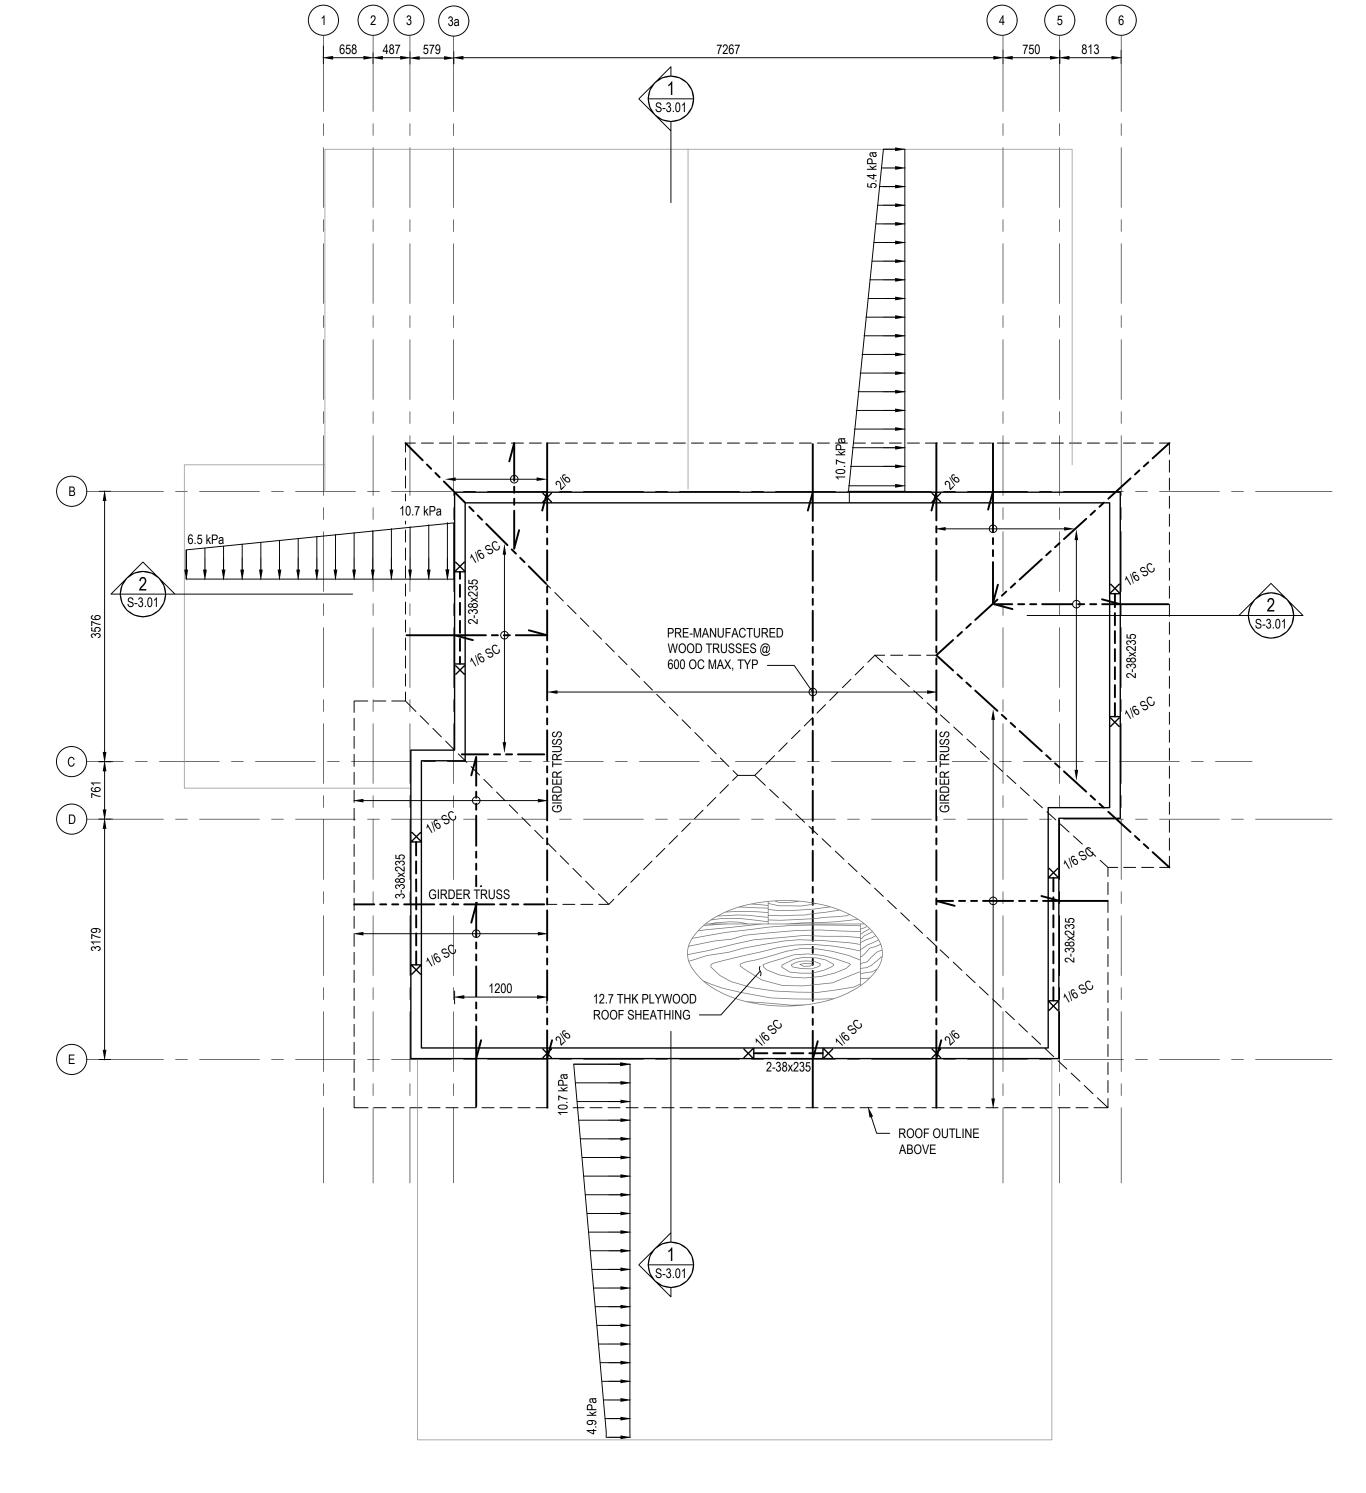

ALL STEEL OUTSIDE THE BUILDING ENVELOPE TO BE HOT-DIPPED GALVANIZED

UPPER FLOOR SHOWING ROOF FRAMING OVER S-2.02 SCALE: 1:50

WOOD FRAMING LEGEND

PWGSC - B1 - 1000X707

WOOD BEAM A = NO. OF PLYS IN BUILT-UP COL B = NOMINAL STUD DEPTH (6 = 2x6) A = NO. OF KING STUDS B = NOMINAL STUD DEPTH (6 = 2x6) XX = NO. OF CRIPPLES: SC = SINGLE CRIPPLE DC = DOUBLE CRIPPLE TC = TRIPLE CRIPPLE _

WOOD FLOOR JOISTS PRE-ENGINEERED WOOD TRUSSES

STUD WALLS

MARK HANGER REMARKS 6-16d NAILS TO SUPPORT SST LUS28-2 OR H1 MITEK JUS28-2 4-16d NAILS TO BEAM / JOIST 16-16d NAILS TO SUPPORT SST HU610 OR 8-10d NAILS TO BEAM / JOIST H2 20-16d NAILS TO SUPPORT 10-16d NAILS TO BEAM / JOIST MITEK HD610 SST U210 OR MITEK SUH210 10-10d NAILS TO SUPPORT 6-10dx38LG NAILS TO BEAM / JOIST SST LUS28-2 10d NAILS MITEK JUS28-2 16d NAILS 10dx38LG NAILS TO SST LUS26 OR SUPPORTING MEMBER MITEK JUS26 SST JB210A OR MITEK HL210 4-10dx38LG NAILS TO NAILER

HANGER SCHEDULE

S-2.02 SCALE: 1:50


MAIN FLOOR SHOWING UPPER FLOOR FRAMING OVER








JOB No. 211-02781-00

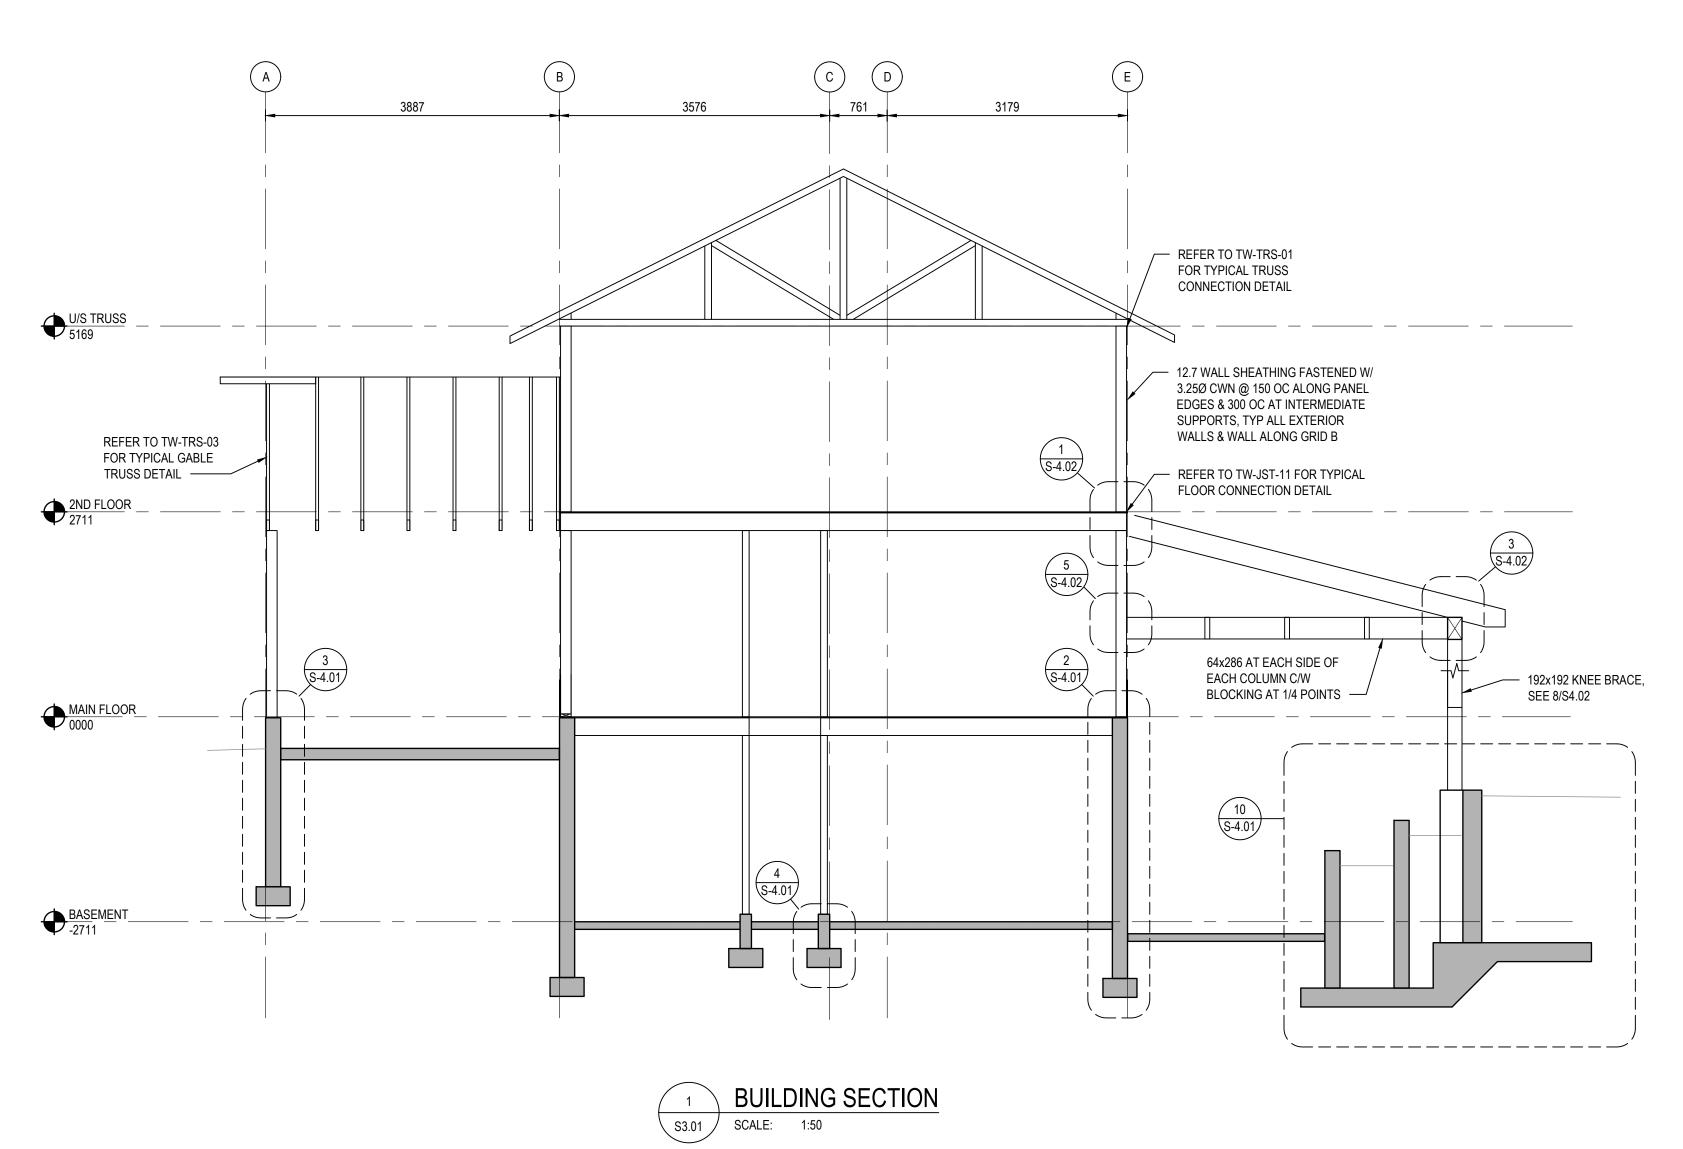

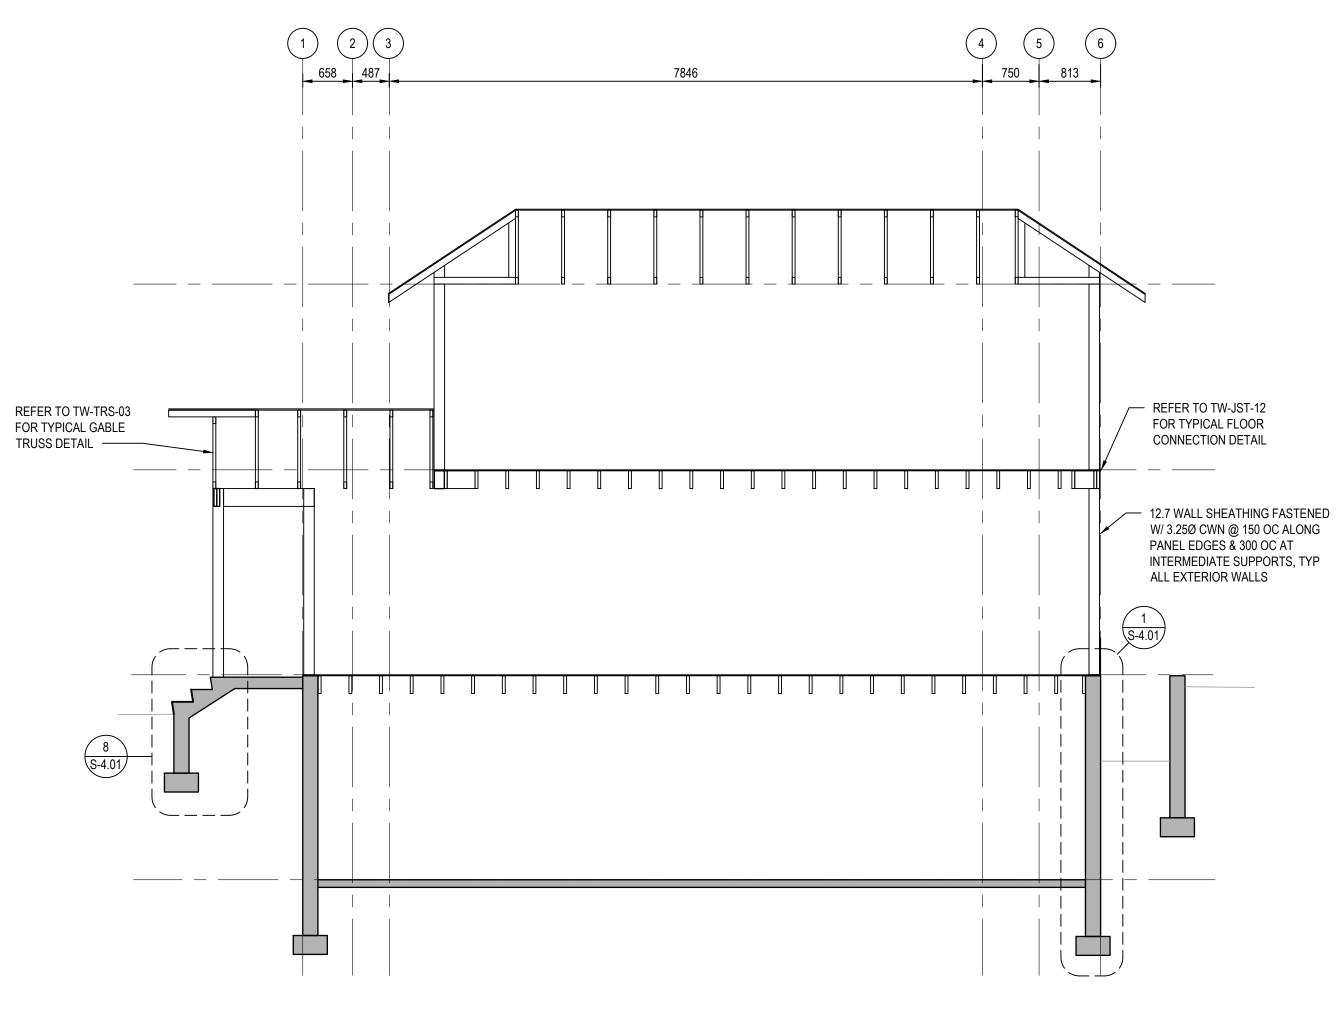



	0	500	1000
500	alección es	SCALE IN MILL	IMETRES
	C.	21-07-12	

SCALE 1:20

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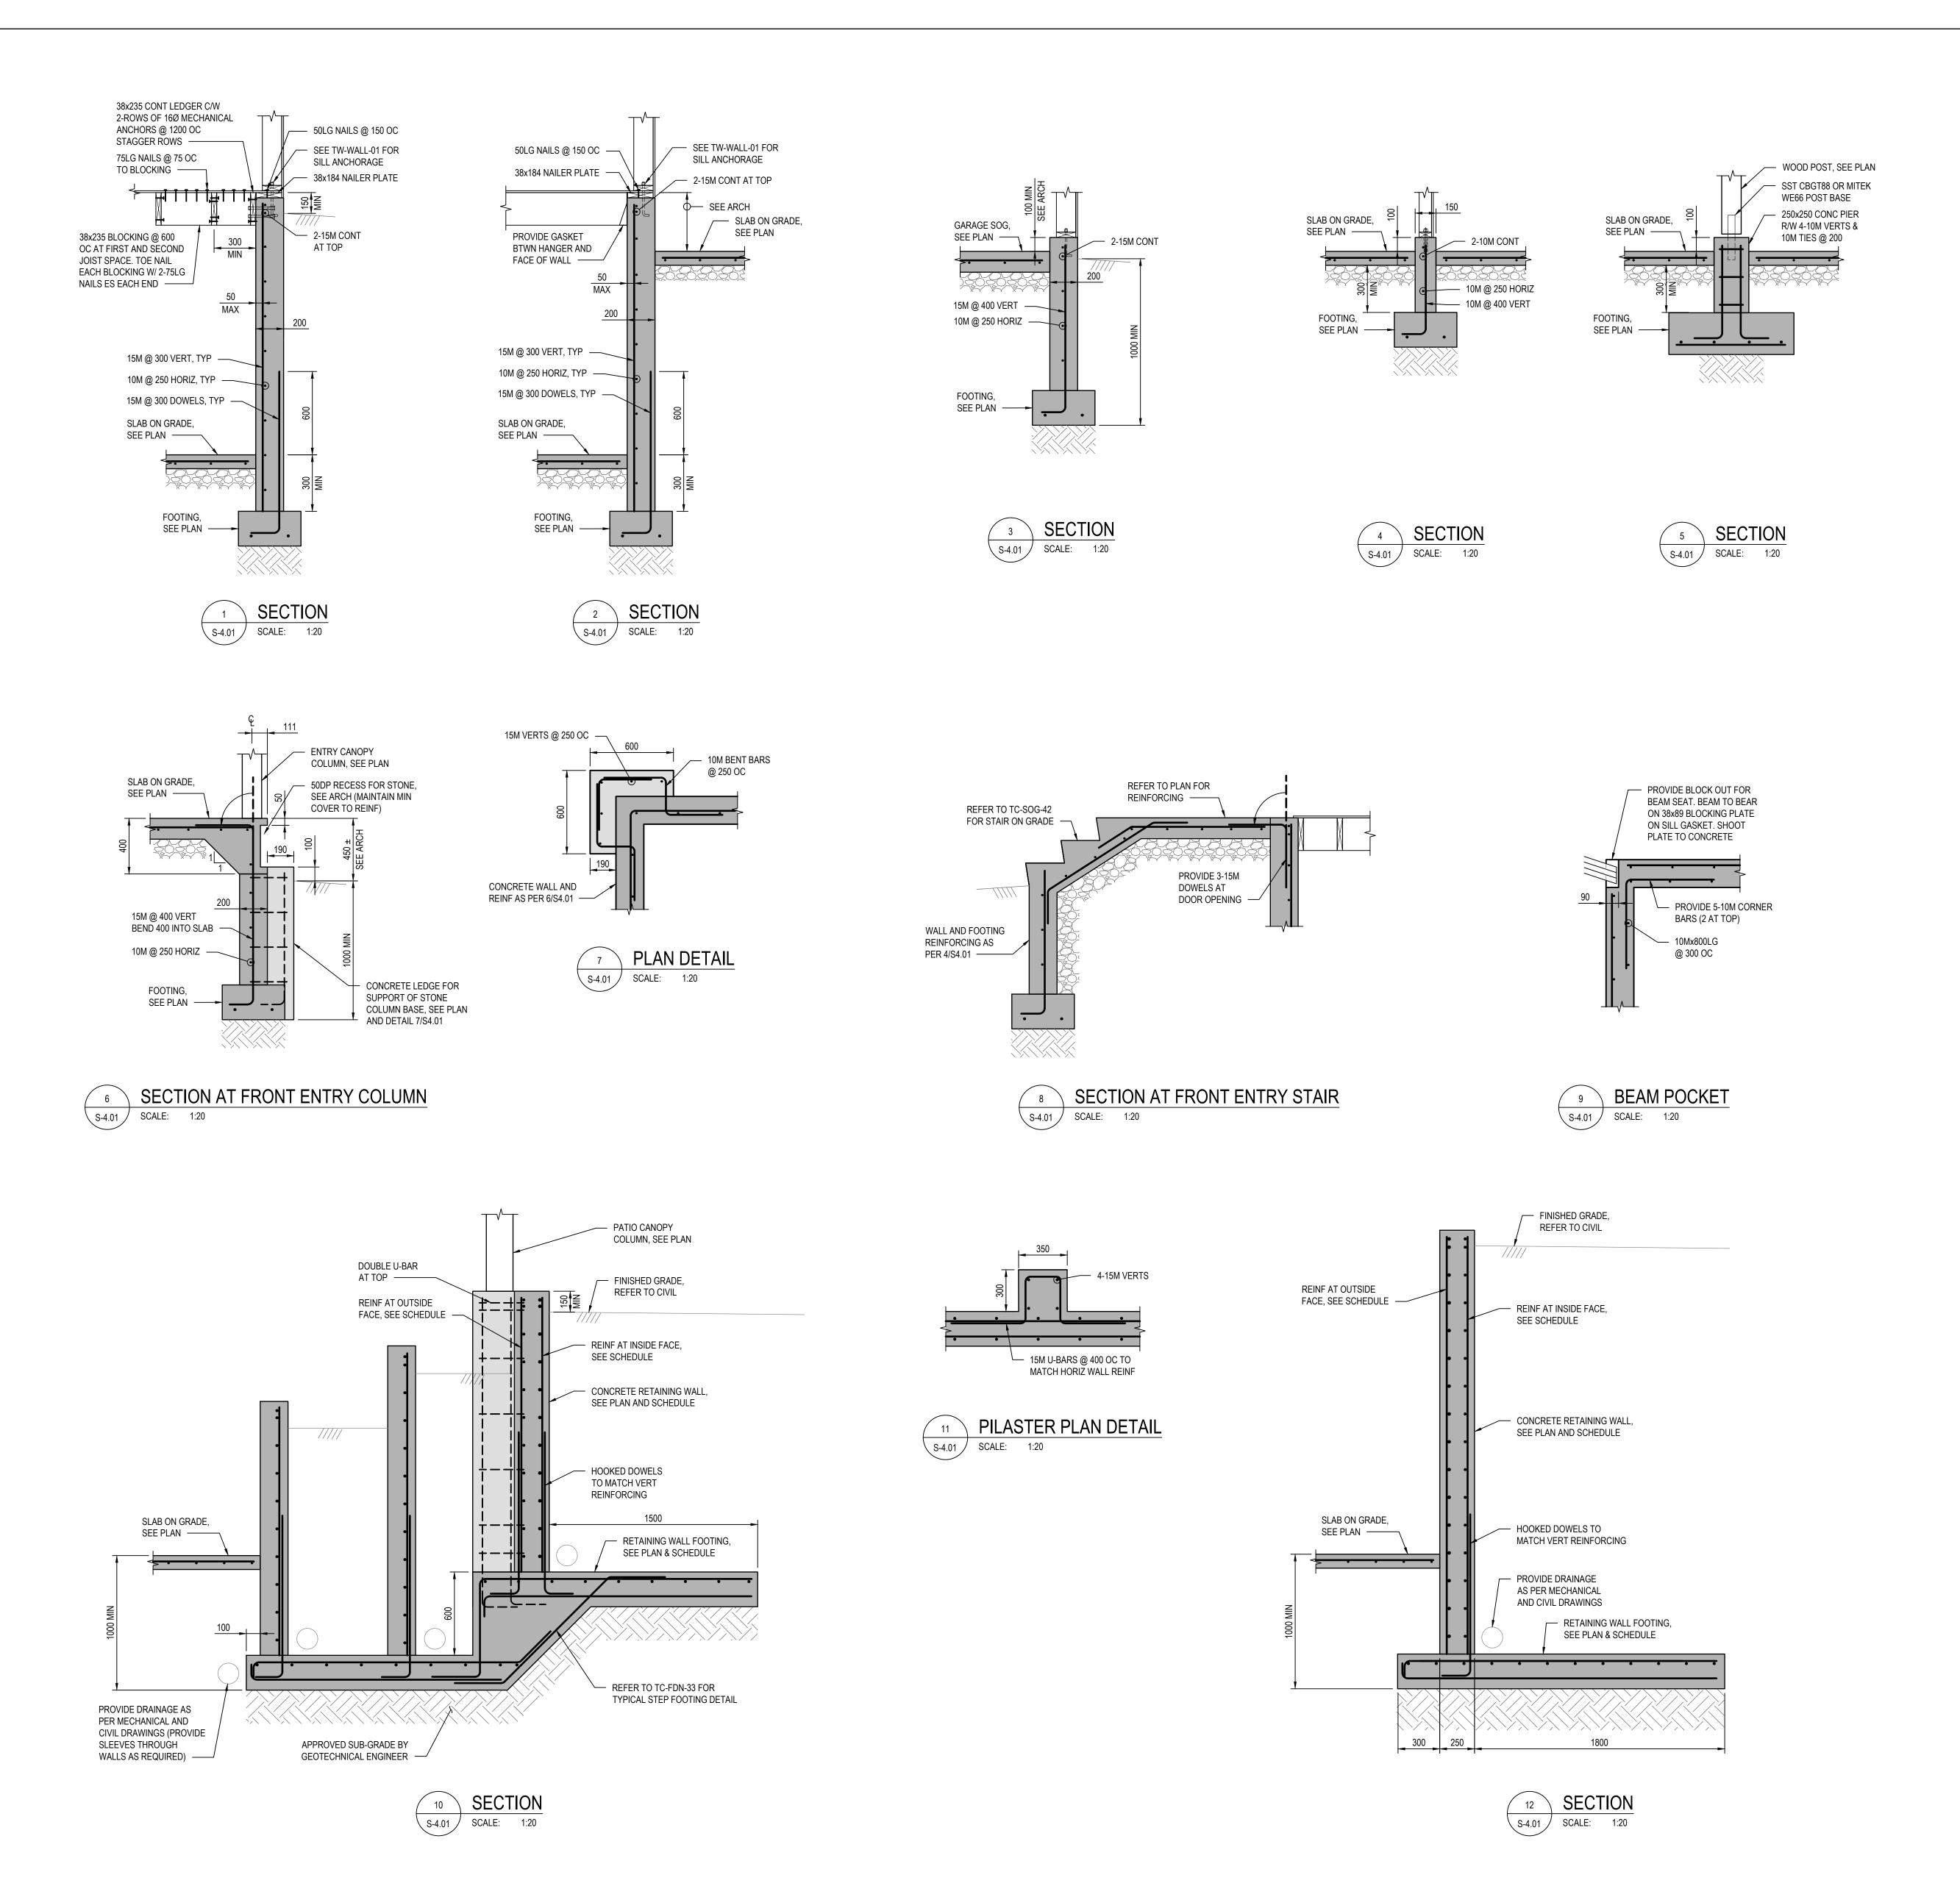
Drawing title/Titre du dessin

NEW EMPLOYEE HOUSING SINGLE FAMILY HOUSE

BUILDING SECTION

R.112456.001

S-3.01






Travaux publics et Services gouvernementaux

REAL PROPERTY SERVICES
Pacific Region
SERVICES IMMOBILIERS
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Client/c

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PHILIP FUNG

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PREETIPAL PAUL

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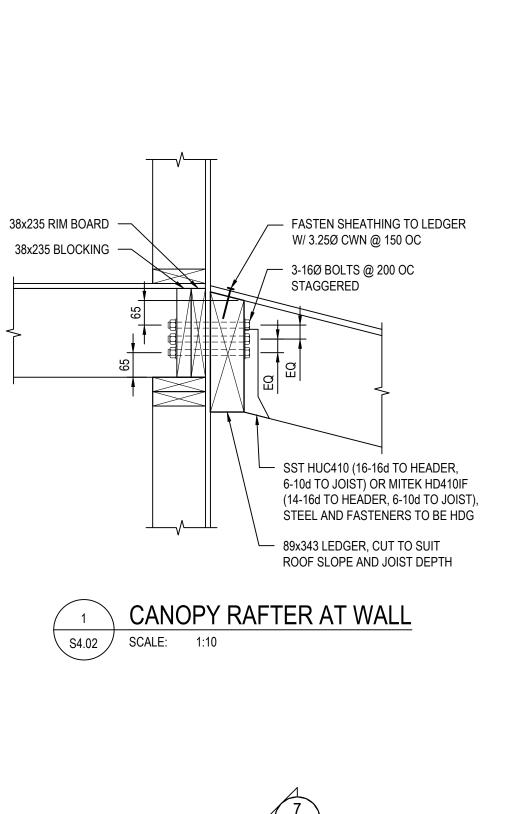
FOUNDATION SECTIONS

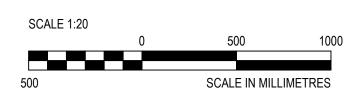
R.112456.001

S-4.01


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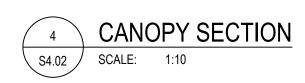
Revision no./ La Révision




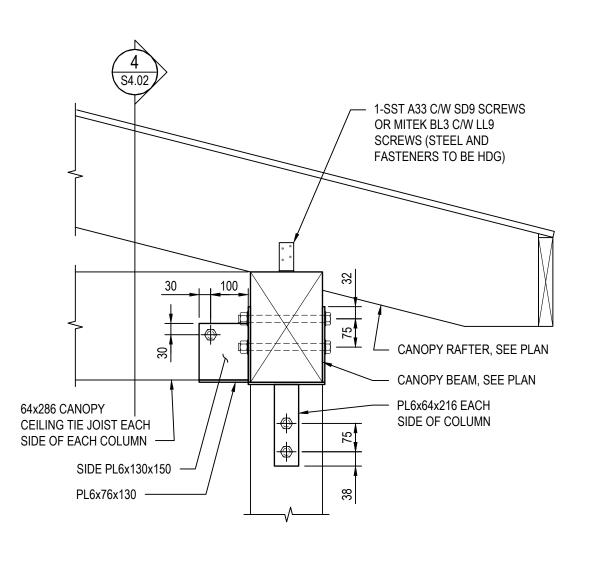


CANOPY SECTION AT COLUMN




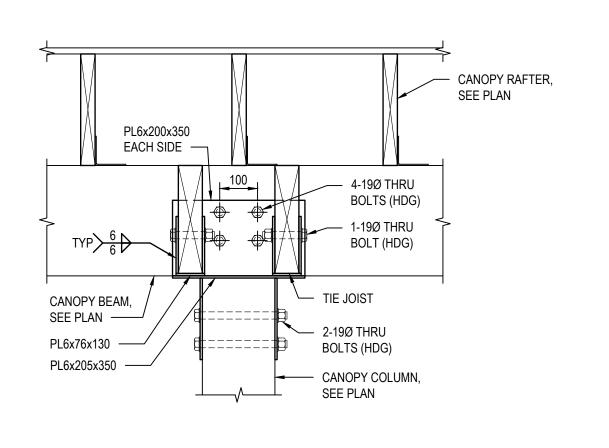

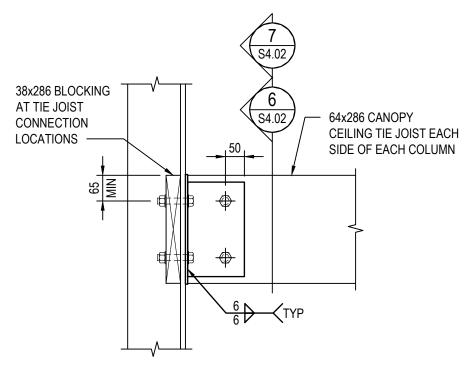

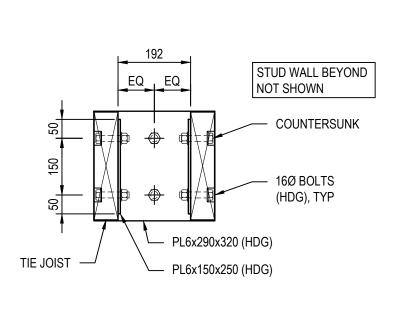



S4.02 SCALE: 1:10

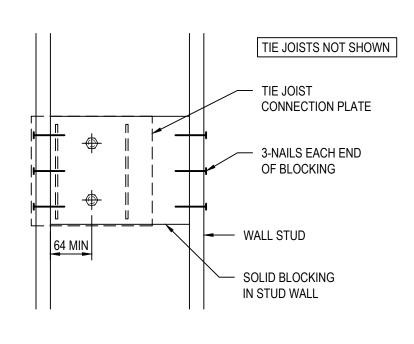




CANOPY TIE JOIST S4.02 SCALE: 1:10

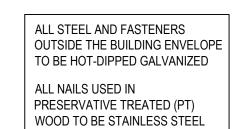

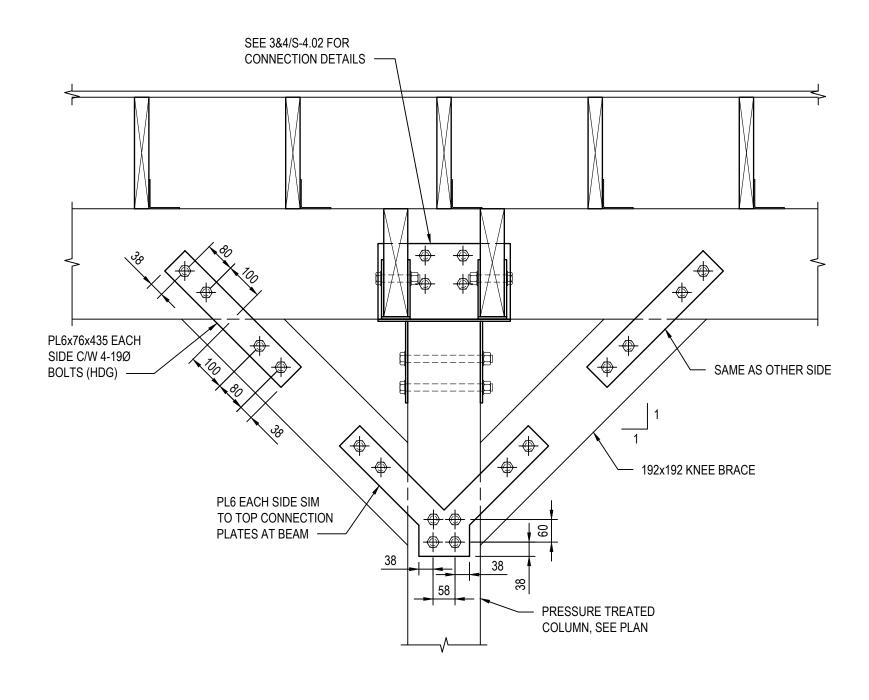

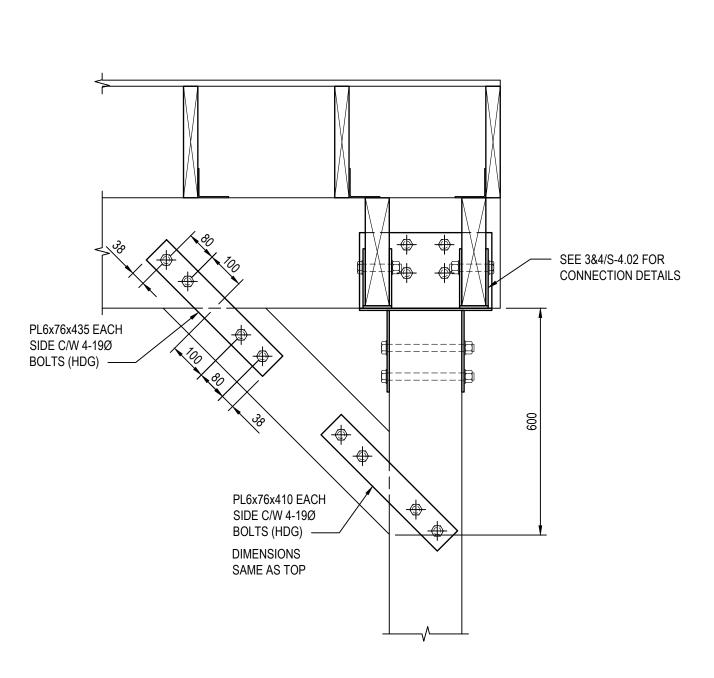

\ KNEE BRACE CONNECTION S4.02 SCALE: 1:10

KNEE BRACE CONNECTION S4.02 SCALE: 1:10

Public Works and Travaux publics et
Government Services Services gouvernementaux
Canada


Canada

REAL PROPERTY SERVICES
Pacific Region SERVICES IMMOBILIERS Région de Pacifique





JOB No. 211-02781-00

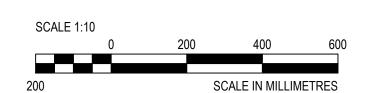



3	3 ISSUED FOR TENDER 2		l
2	ISSUED FOR 100% REVIEW	2021-06-30	
1	ISSUED FOR 99% REVIEW	2021-06-01	
0	ISSUED FOR 66% REVIEW	2021-05-03	
Revision/	Description/Description	Date/Date	l I

Professional and Technical Services (PTS) PACIFIC REGION

VANCOUVER, BC 800 BURRARD ST.

Project title/Titre du projet

New Residence, New Aiyansh, BC

Consultant Signature Box Only

Designed by/Concept par CHELSEA PATON, P.ENG

Drawn by/Dessine par **GINA MAJOR**

PWGSC Project Manager/Administrateur de Projets TPSGC PHILIP FUNG

PWGSC, Regional Manager, Architectural and Engineering Services/ Gestionnaire régionale, Services d'architectural et de génie, TPSGC PREETIPAL PAUL


Drawing title/Titre du dessin


NEW EMPLOYEE HOUSING SINGLE FAMILY HOUSE


WOOD FRAMING SECTIONS

R.112456.001

S-4.02

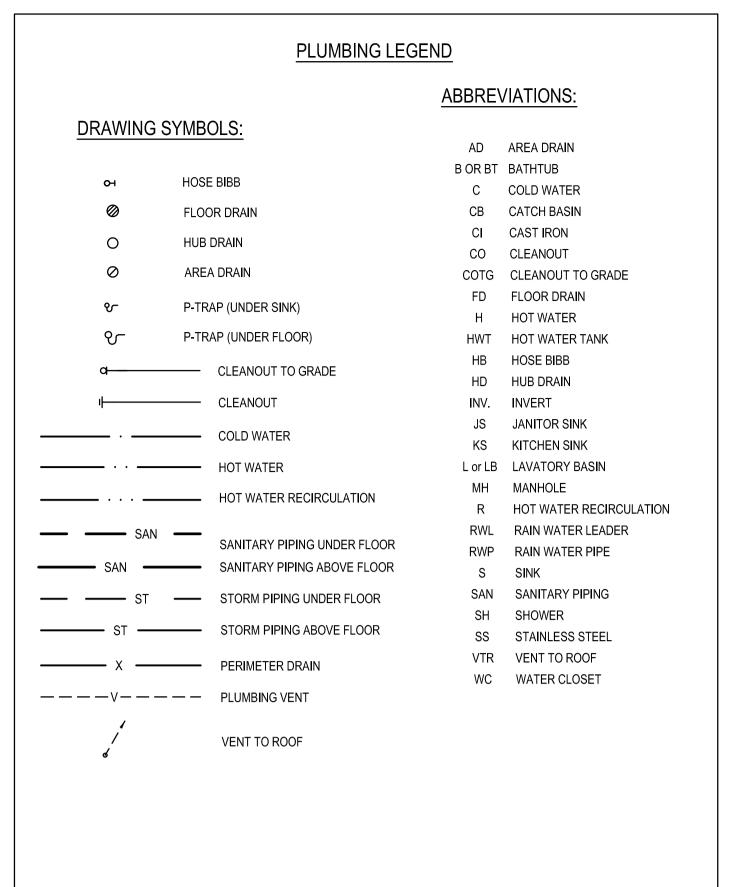

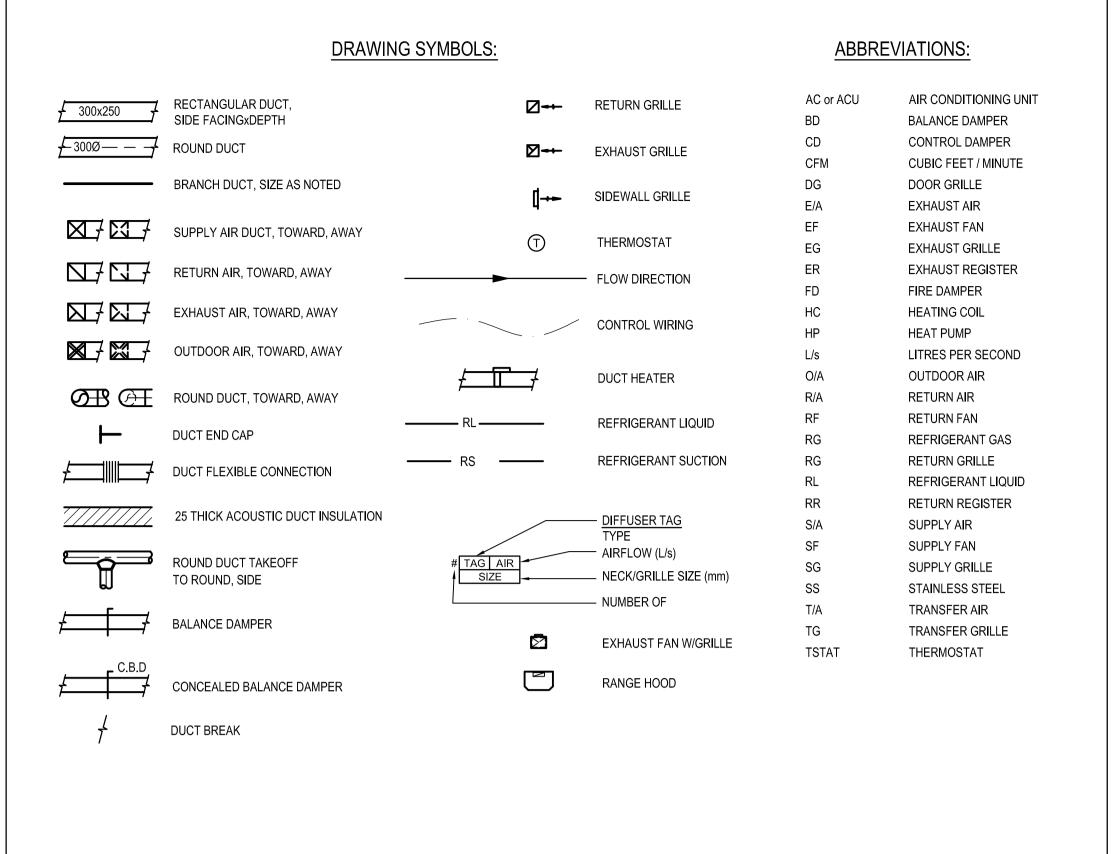

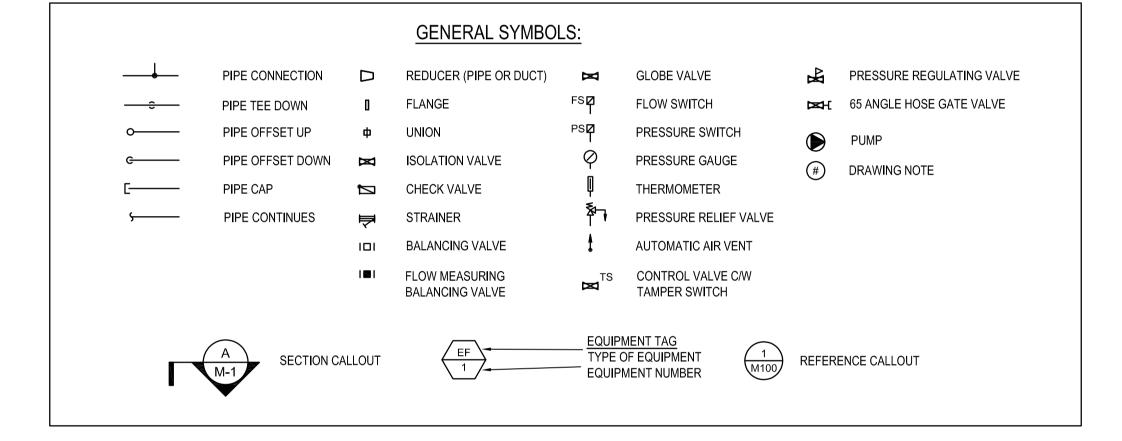

	<u>GENERALE AU</u>	BBREVIATION	<u></u>
AD	ACCESS DOOR	NTS	NOT TO SCALE
AP	ACCESS PANEL	Re	REMOVE EXISTING
AFF	ABOVE FINISHED FLOOR	R	RELOCATED ITEM
CTE	CONNECT TO EXISTING	ReRe	REMOVE AND RELOCATE
EX	EXISTING ITEM	T.R.	TO REMAIN
N	NEW ITEM	U.O.N.	UNLESS OTHERWISE NOTED
NIC	NOT IN CONTRACT		

	MECHANICAL DRAWING LIST	
DRAWING NO.	DRAWING NAME	SCALE
M0.1	LEGEND, DRAWING LIST & SCHEDULES	N/A
M1.1	MAIN AND BASEMENT FLOOR PLANS PLUMBING	1:50
M1.2	UPPER AND ROOF PLANS PLUMBING	1:50
M2.1	MAIN AND BASEMENT FLOOR PLANS HVAC	1:50
M2.2	UPPER AND ROOF PLANS HVAC	1:50
M3.0	DETAILS	AS NOTED



Public Works and Travaux publics et
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Canada Canada

REAL PROPERTY SERVICES Pacific Region SERVICES IMMOBILIERS Région de Pacifique





WSP PROJ # 211-02781-00



3	ISSUED FOR TENDER	2021-07-12
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Client/client		

Public Services and Procurement Canada (PSPC)

VANCOUVER, BC 800 BURRARD ST.

Project title/Titre du projet


New Residence, New Aiyansh, BC

Consultant Signature Box Only Designed by/Concept par Drawn by/Dessine par HCP PWGSC Project Manager/Administrateur de Projets TPSGC PHILIP FUNG PWGSC, Regional Manager, Architectural and Engineering Services/ Gestionnaire régionale, Services d'architectural et de génie, TPSGC PREETIPAL PAUL Drawing title/Titre du dessin LEGEND, DRAWING LIST & SCHEDULES

Project No./No. du projet R.112456.001 # **M0.1**

PWGSC - B1 - 1000X707

Revision no./ La Révision

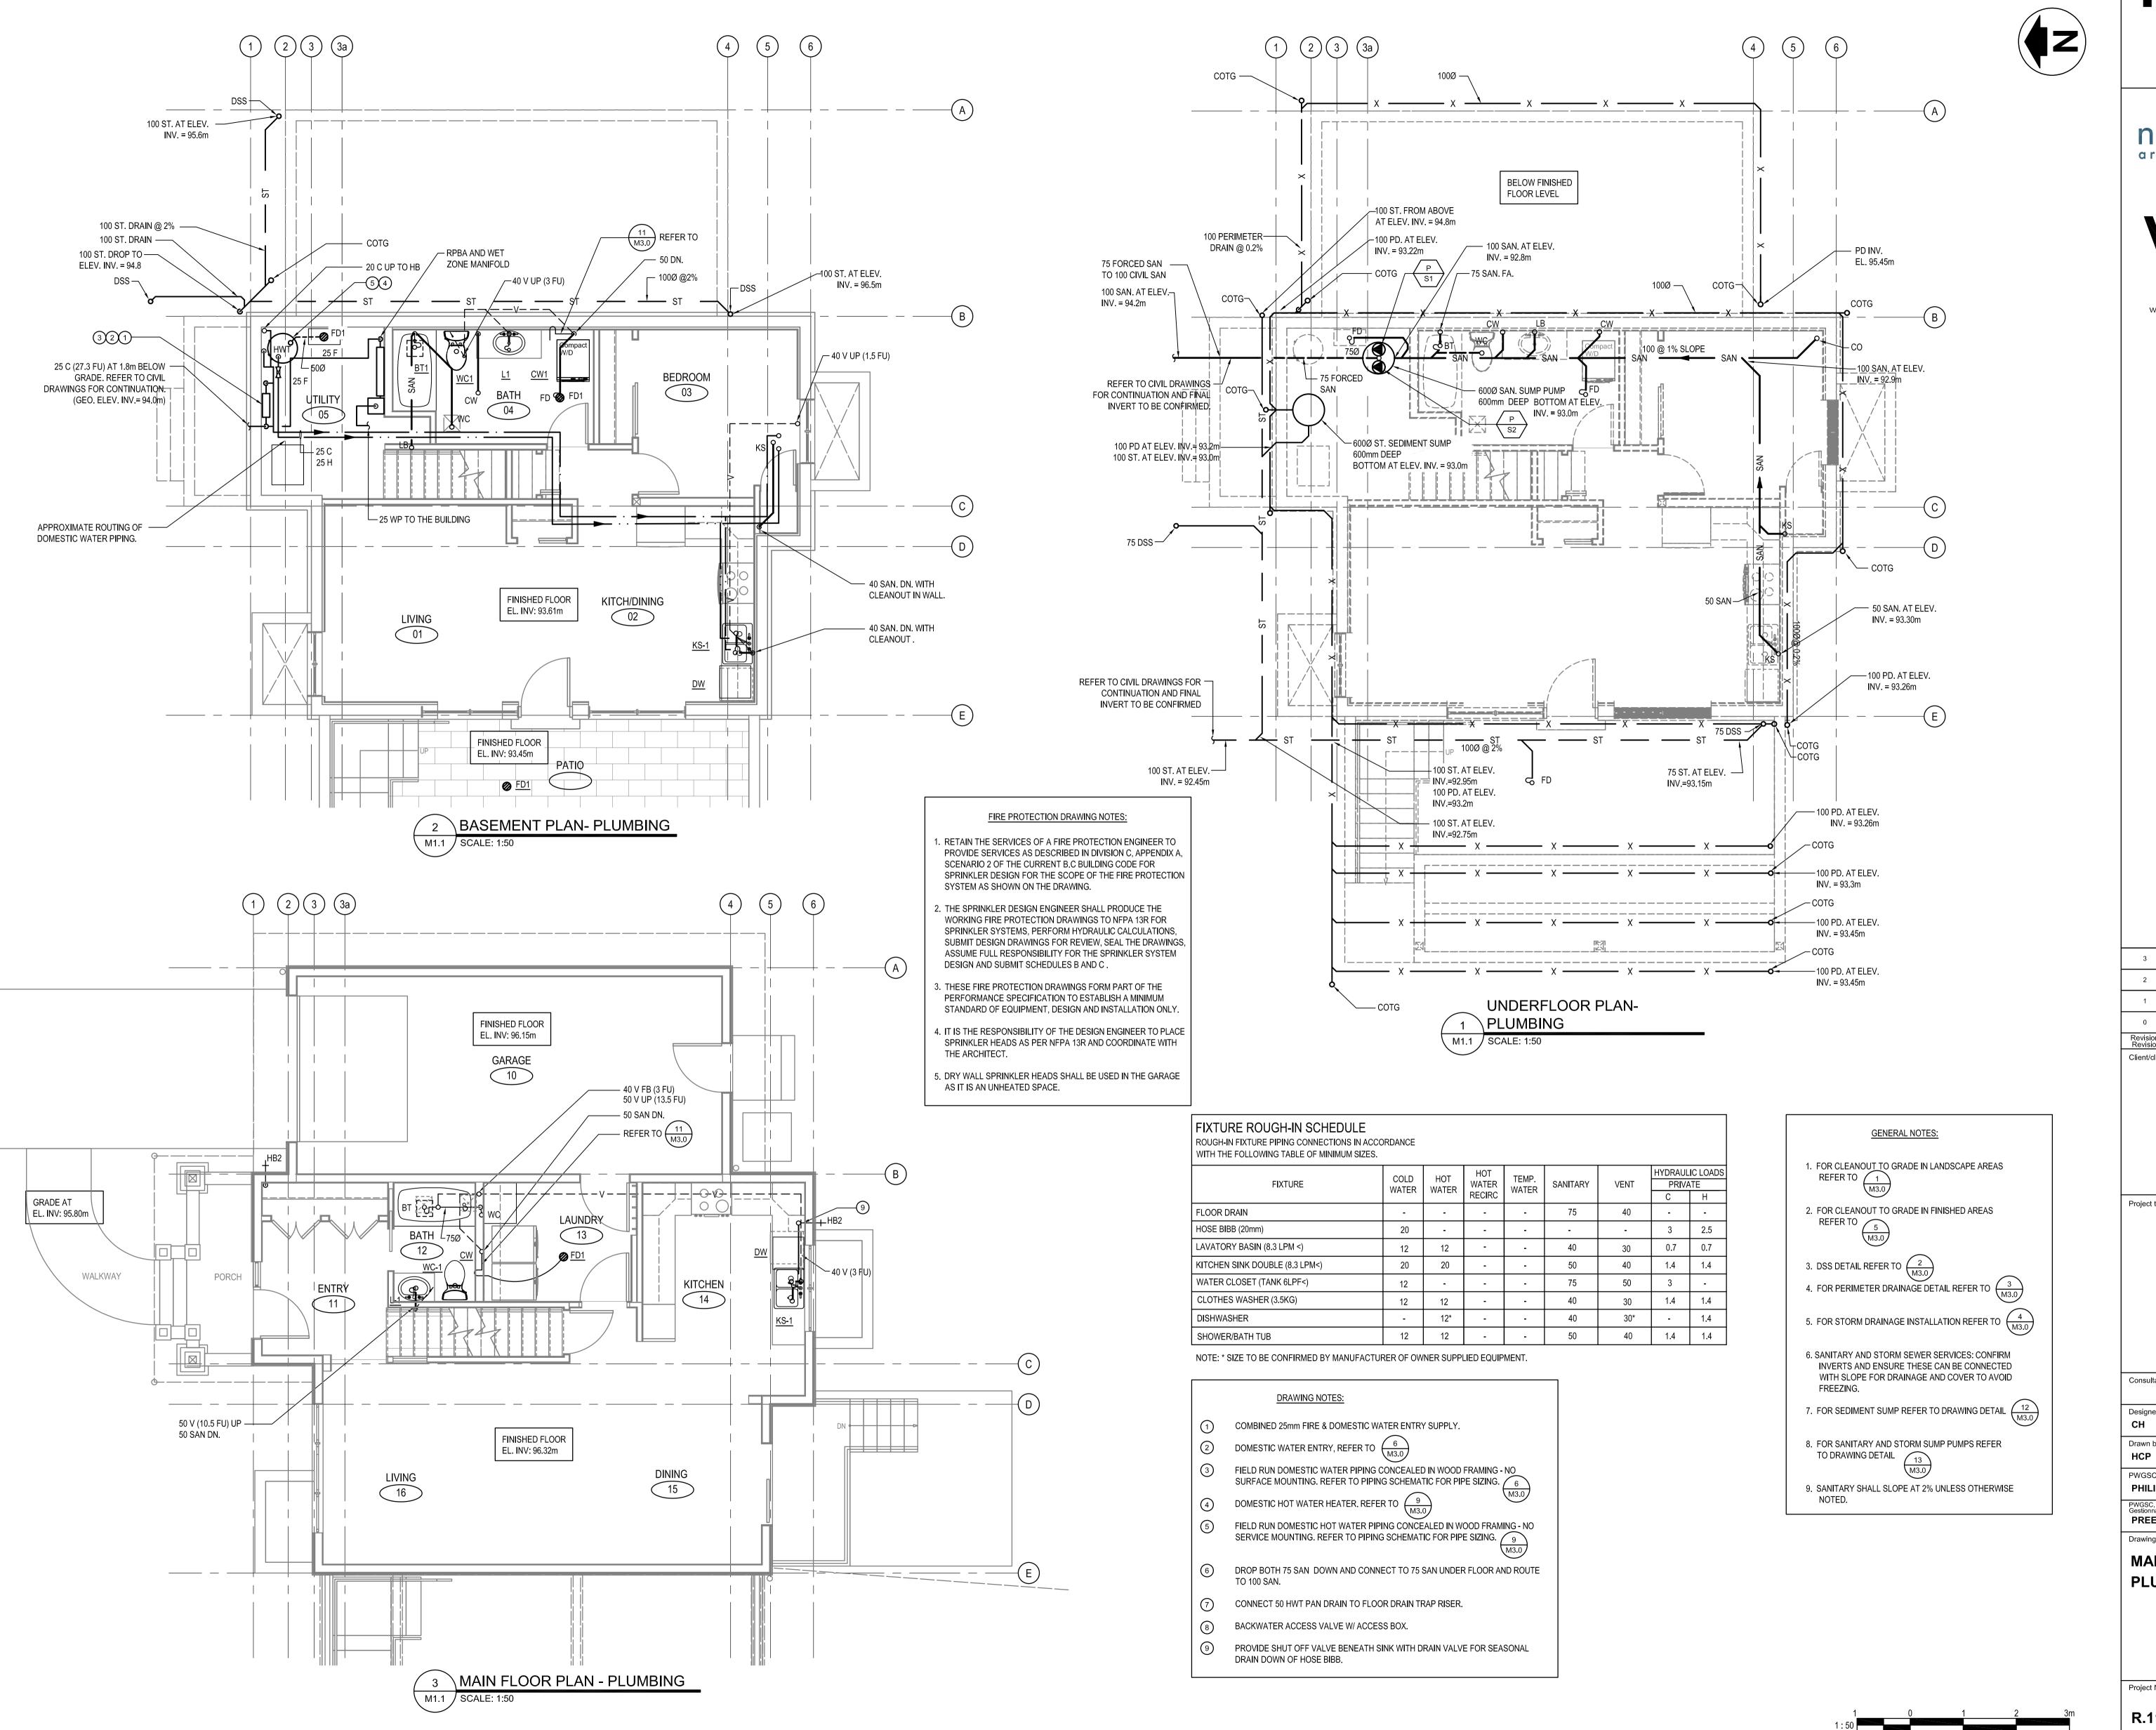

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REAL PROPERTY SERVICES Pacific Region



SERVICES IMMOBILIERS Région de Pacifique



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VANCOUVER, BC 800 BURRARD ST.

Project title/Titre du projet

New Residence, New Aiyansh, BC

Consultant Signature Box Only

Designed by/Concept par

Drawn by/Dessine par

HCP

PWGSC Project Manager/Administrateur de Projets TPSGC PHILIP FUNG

PWGSC, Regional Manager, Architectural and Engineering Services/ Gestionnaire régionale, Services d'architectural et de génie, TPSGC PREETIPAL PAUL

Drawing title/Titre du dessin

MAIN AND BASEMENT FLOOR PLANS **PLUMBING**

Project No./No. du projet La Révision M1.1 R.112456.001





Public Works and Travaux publics et
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Pacific Region

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WSP PROJ # 211-02781-00



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0	ISSUED FOR 66% REVIEW	2021-05-03
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Client/client	-	

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Designed by/Concept par Drawn by/Dessine par

HCP


PWGSC Project Manager/Administrateur de Projets TPSGC PHILIP FUNG

PWGSC, Regional Manager, Architectural and Engineering Services/ Gestionnaire régionale, Services d'architectural et de génie, TPSGC PREETIPAL PAUL


Drawing title/Titre du dessin

UPPER AND ROOF PLAN PLUMBING

Project No./No. du projet M1.2 R.112456.001

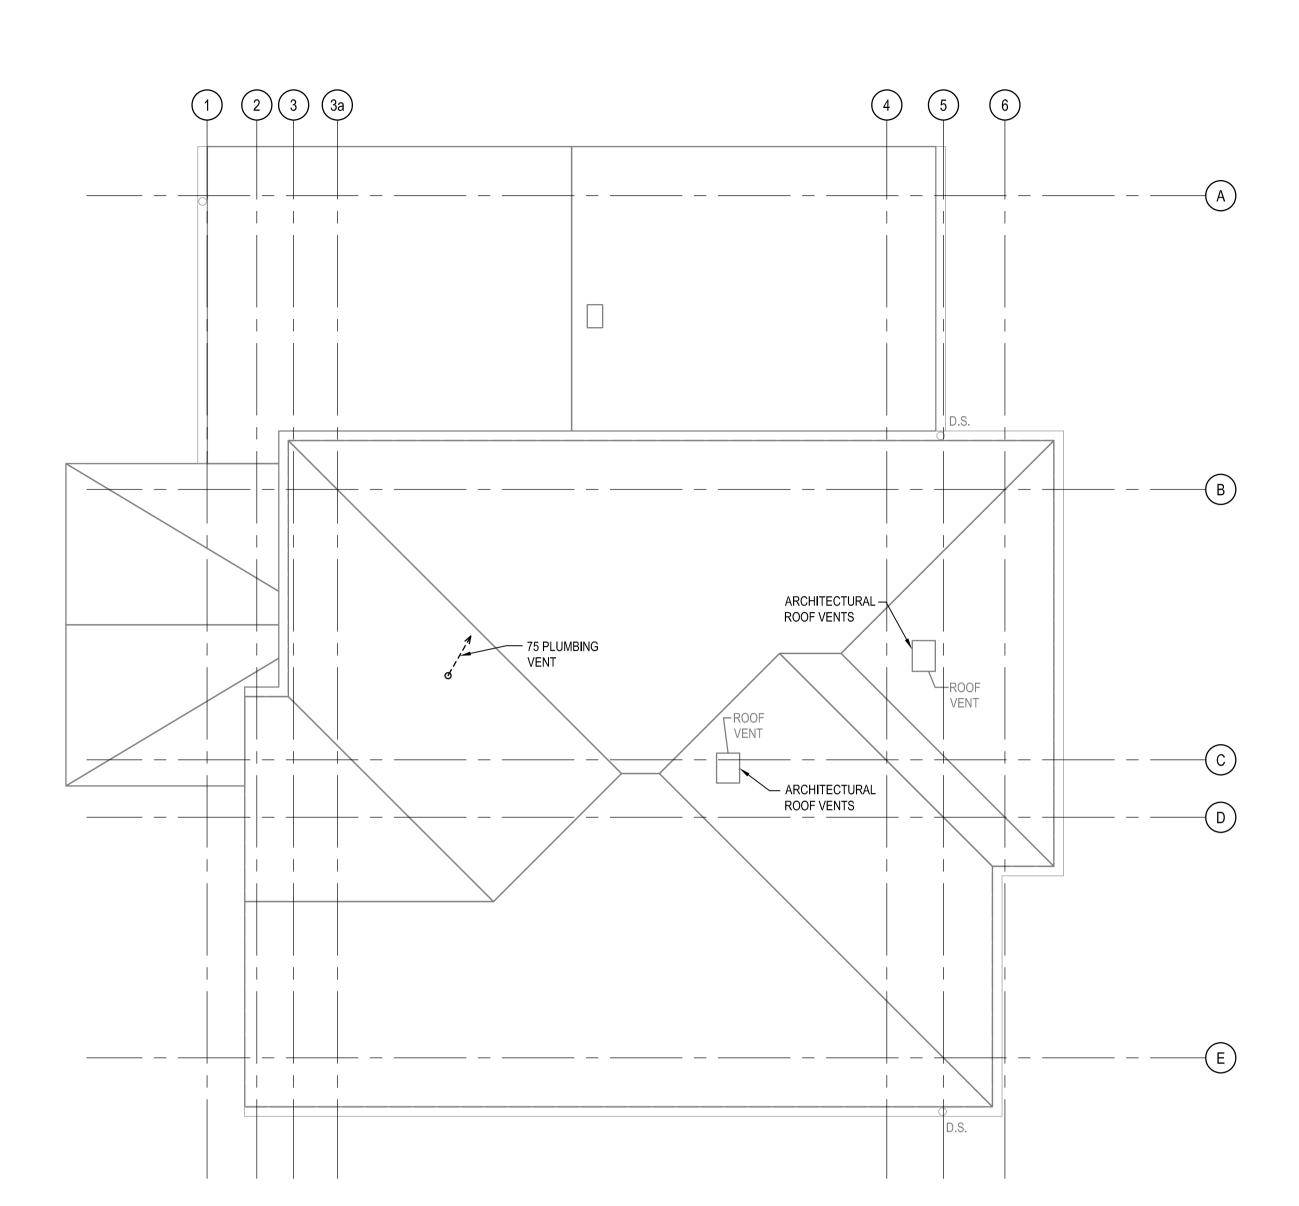




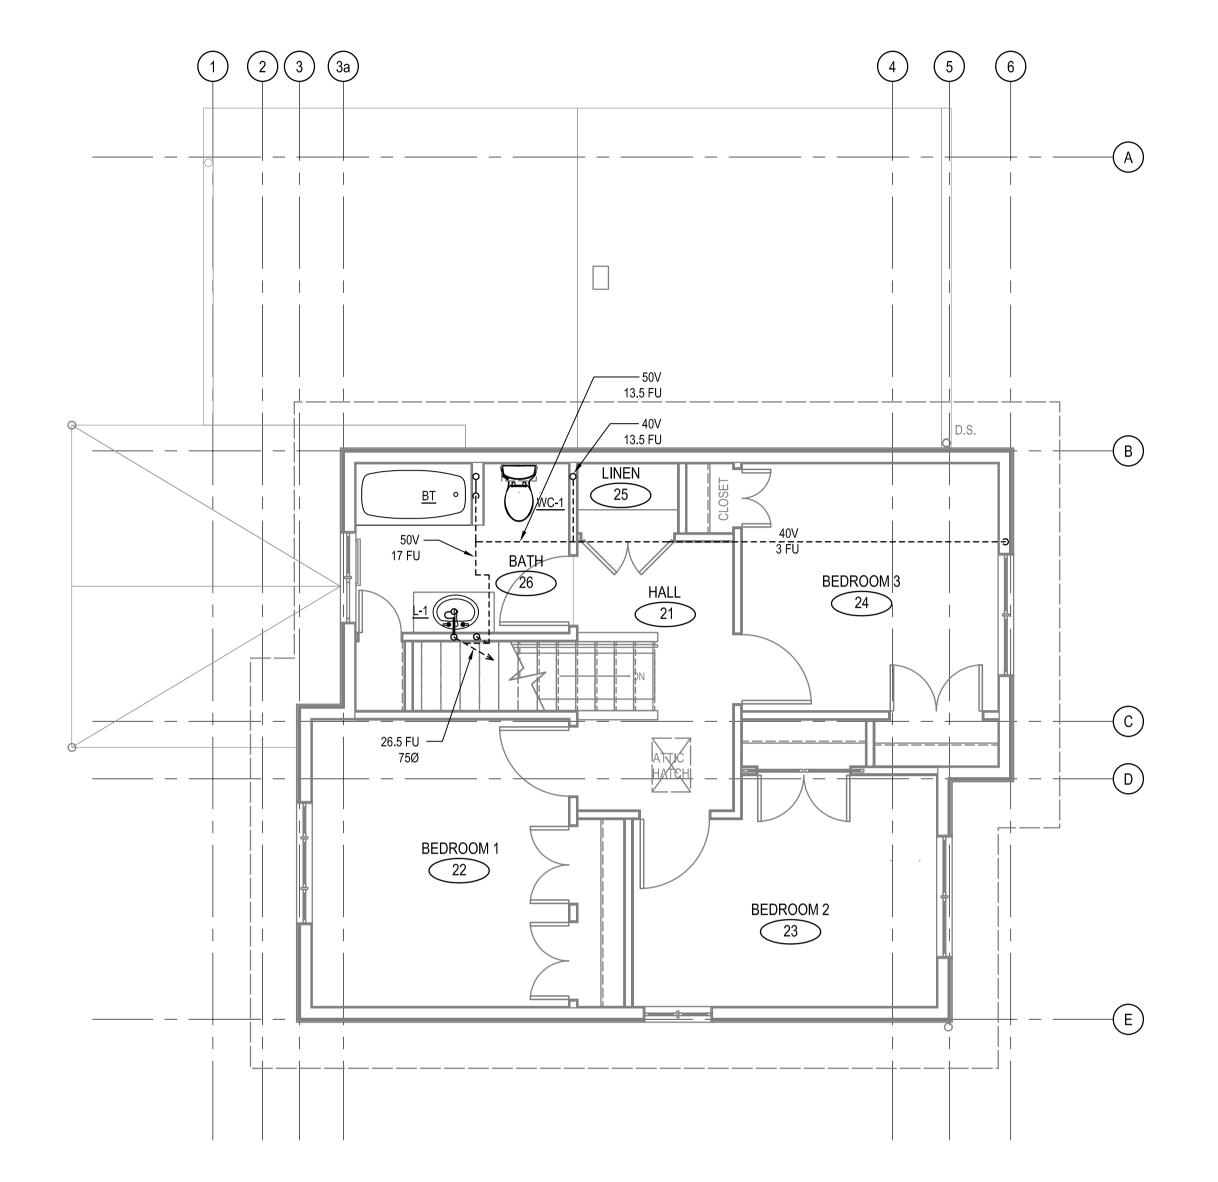



PWGSC - B1 - 1000X707

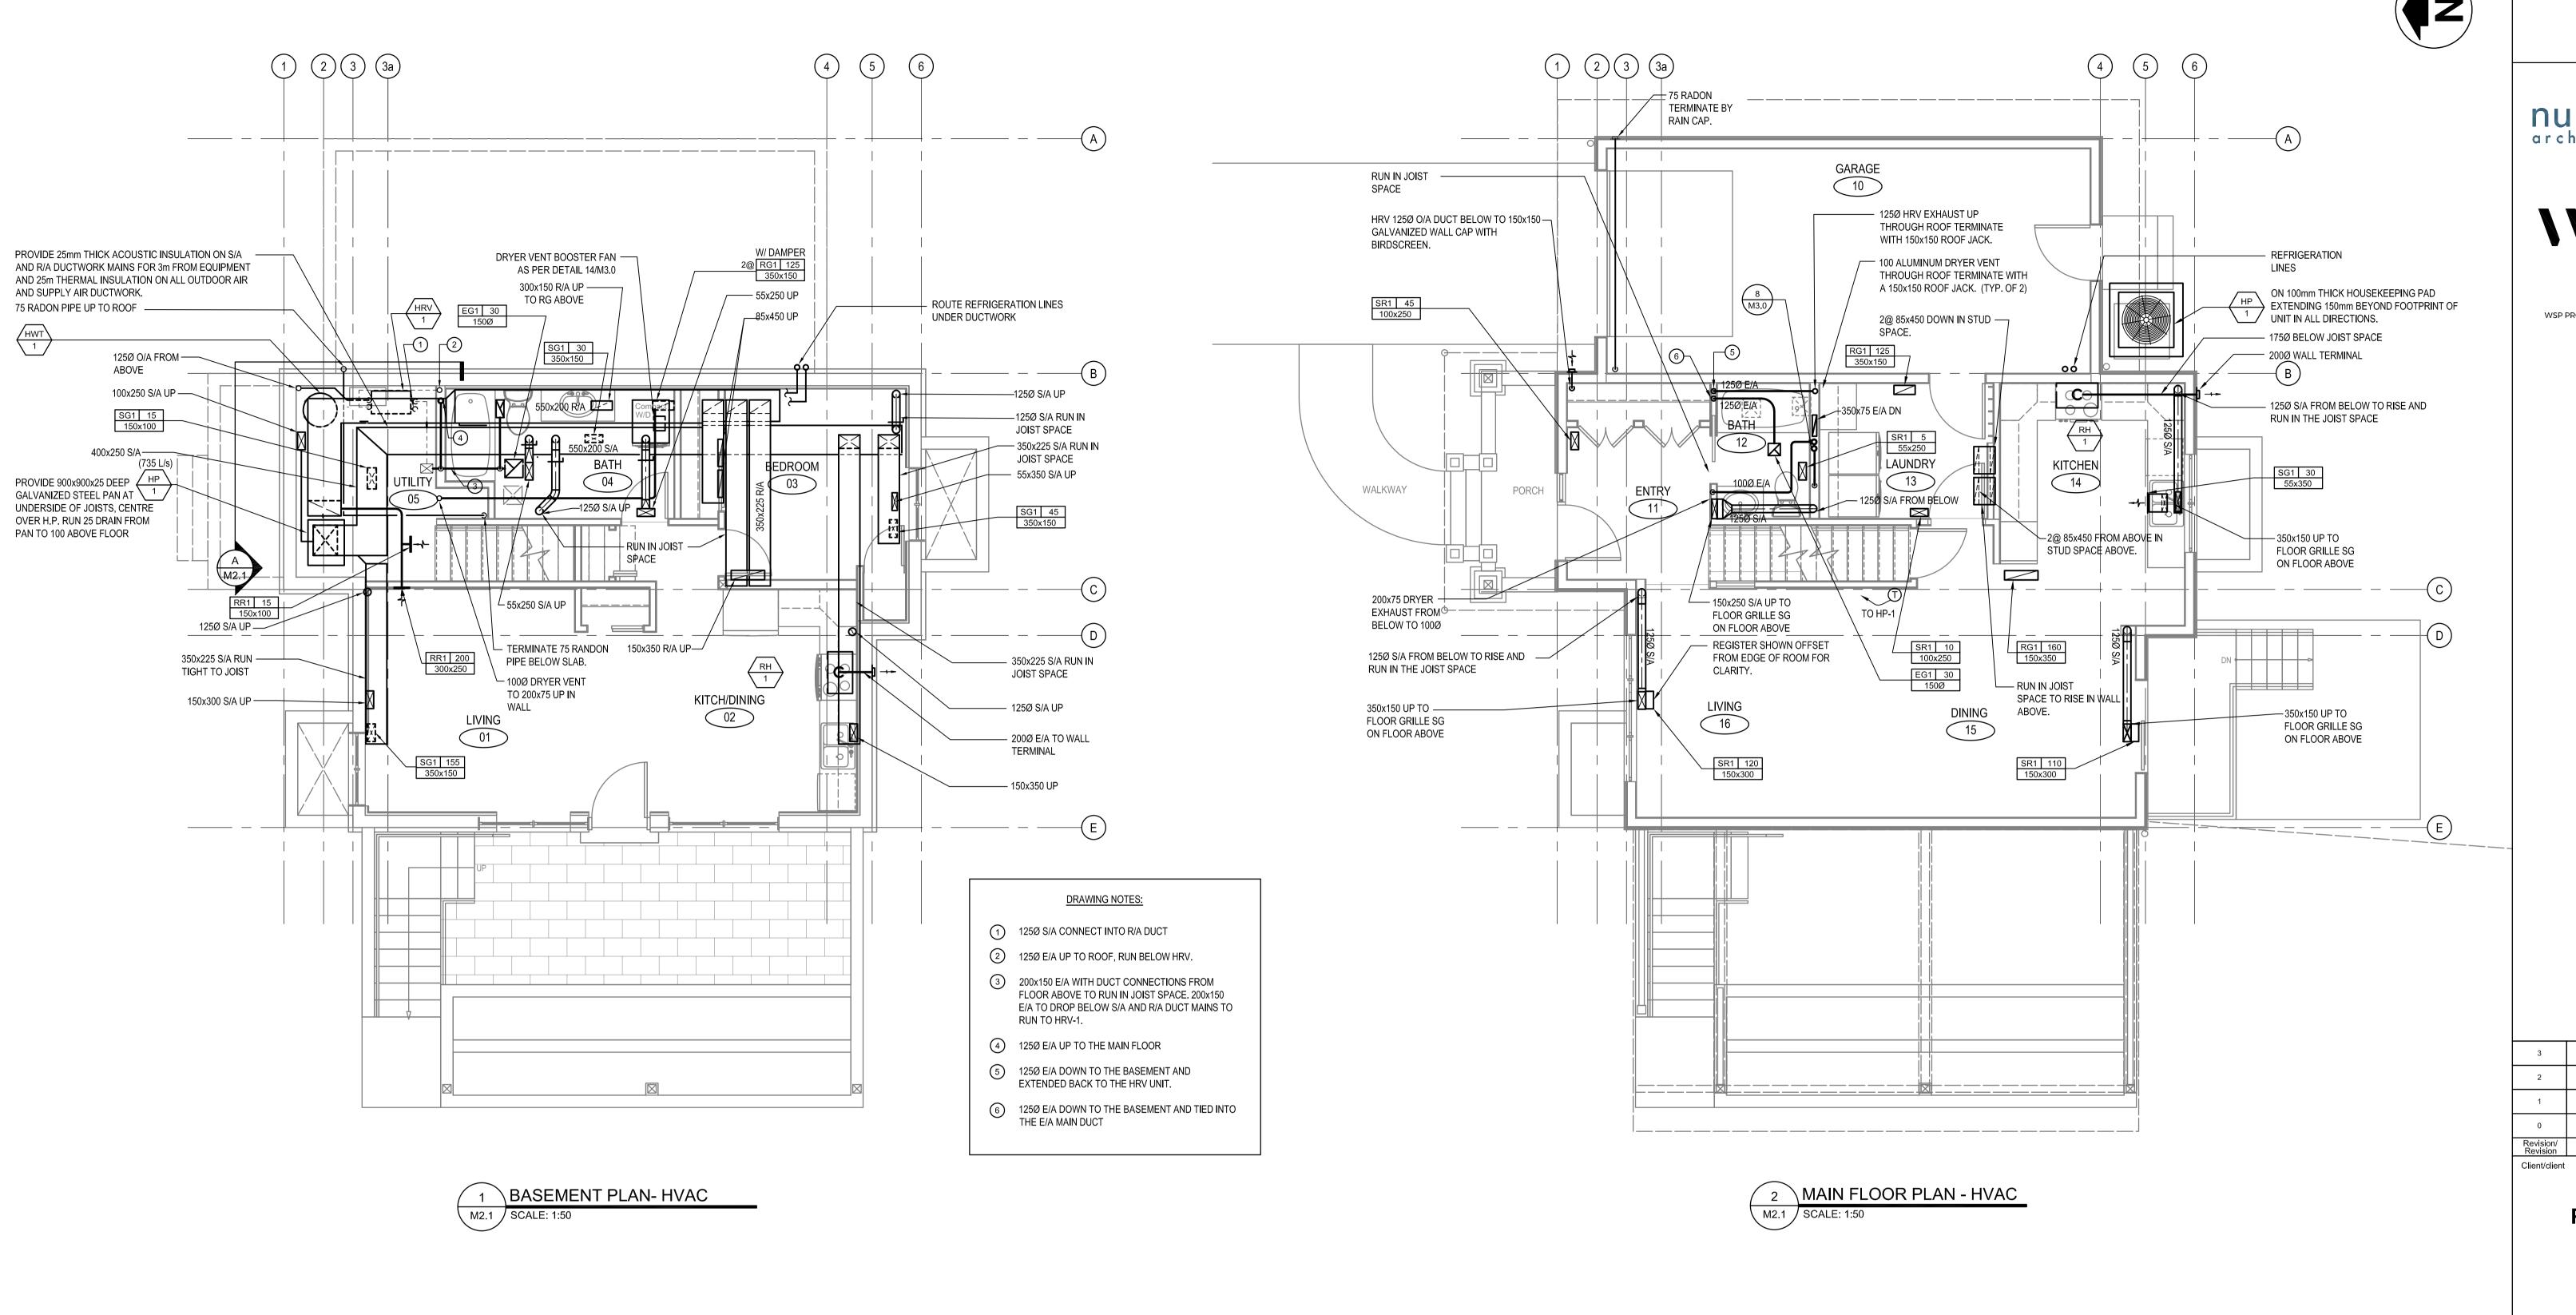







WSP PROJ # 211-02781-00



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Client/client		

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VANCOUVER, BC 800 BURRARD ST.

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New Residence, New Aiyansh, BC

Consultant Signature Box Only Designed by/Concept par СН Drawn by/Dessine par HCP PWGSC Project Manager/Administrateur de Projets TPSGC PHILIP FUNG PWGSC, Regional Manager, Architectural and Engineering Services/ Gestionnaire régionale, Services d'architectural et de génie, TPSGC PREETIPAL PAUL Drawing title/Titre du dessin

MAIN AND BASEMENT FLOOR PLANS **HVAC**

Project No./No. du projet **M2.1** R.112456.001

25mm THICK INSULATED DOMESTIC

- 350x225 S/A

300x600 R/A

∕-OUTSIDE WALL

PLENUM

WATER PIPES

— 650x650 S/A PLENUM

FAN COIL

UNIT

25mm THICK INSULATED

REFRIGERANT LINES

— 550x250 R/A

HWT

—— RL ——

R/A DUCT MAIN

__FLEX

DUCT

A SECTION

M2.1 SCALE: 1:25

125Ø EXHAUST AIR -

FROM BATHROOMS

BASEMENT CEILING

DUCT.

INTERIOR -

BASEMENT FLOOR

RESTRAIN

MOUNT UNIT ON UNI-STRUT FRAME & SEISMICALLY

WALL

75 SAN FROM WO

TO DROP BEHIND 250x550 R/A





-B







WSP PROJ # 211-02781-00



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Consultant Signature Box Only Designed by/Concept par Drawn by/Dessine par HCP


PWGSC Project Manager/Administrateur de Projets TPSGC PHILIP FUNG

PWGSC, Regional Manager, Architectural and Engineering Services/ Gestionnaire régionale, Services d'architectural et de génie, TPSGC PREETIPAL PAUL


Drawing title/Titre du dessin **UPPER AND ROOF PLANS**

HVAC

Project No./No. du projet **M2.2** R.112456.001

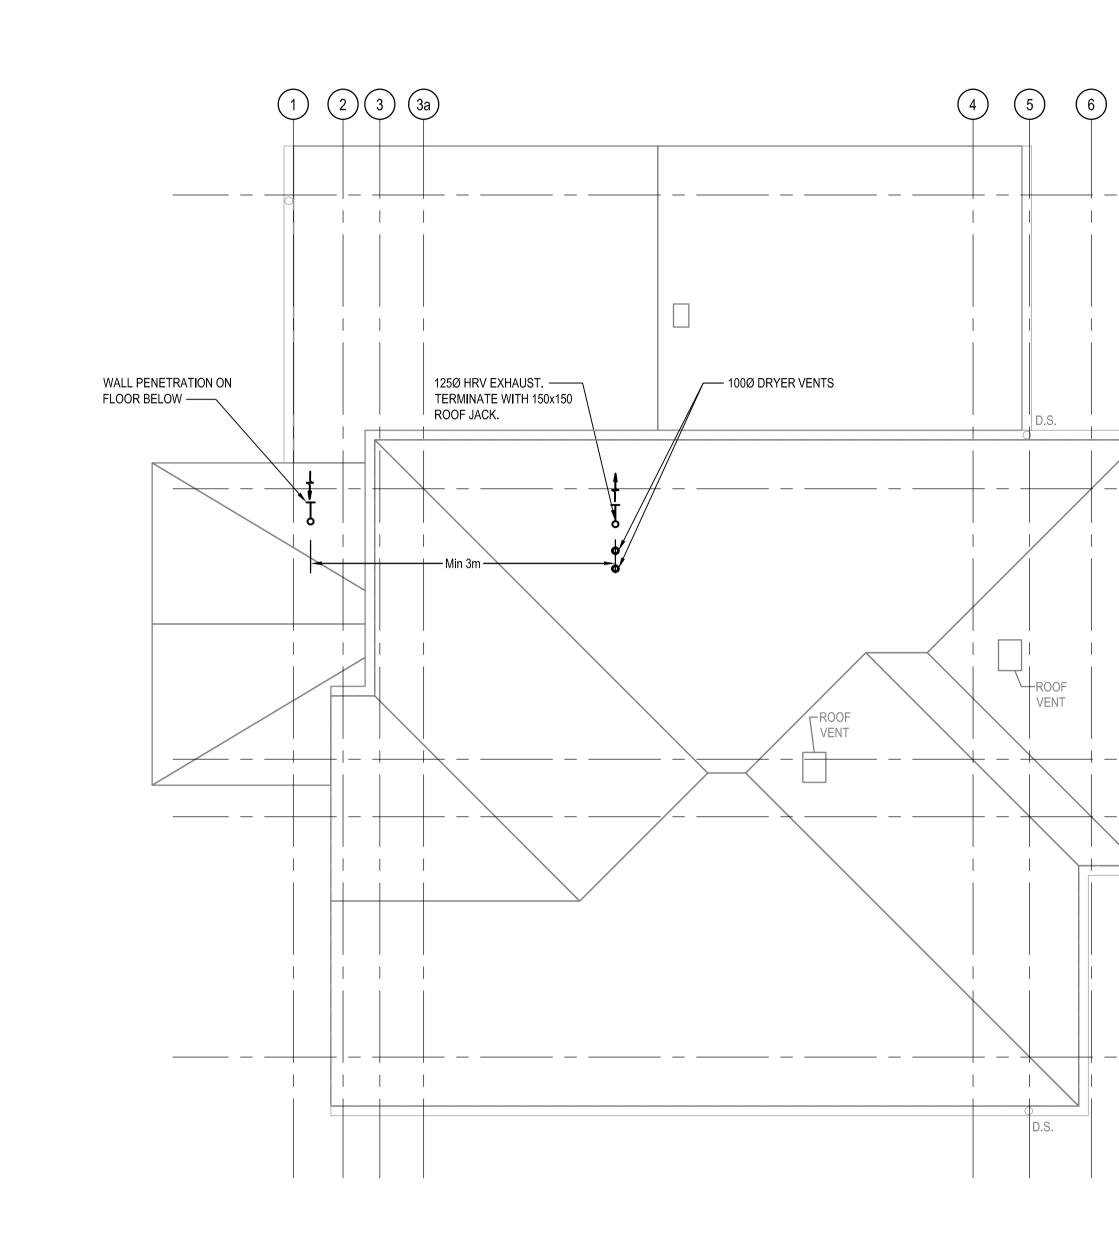



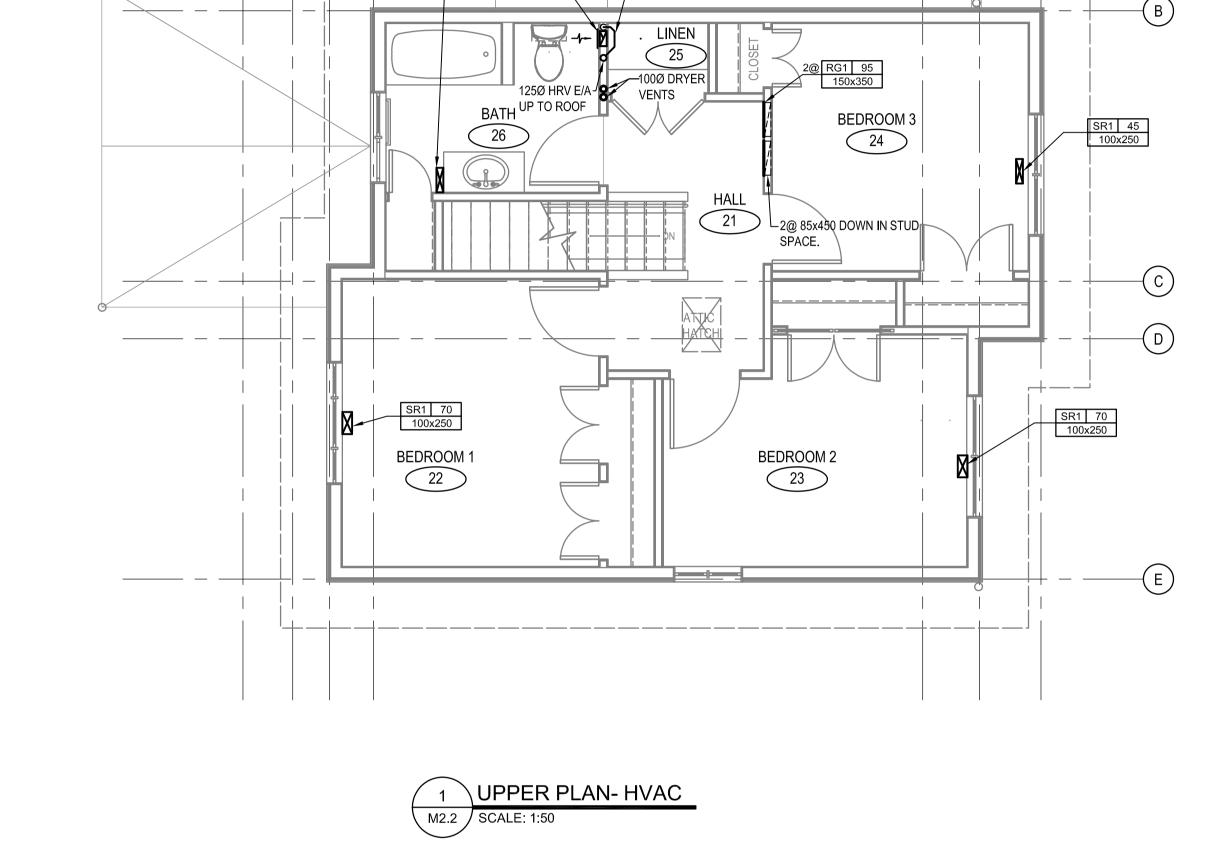



J 350x75 EXHAUST DOWN

4 5 6

1 2 3 3a

PWGSC - B1 - 1000X707

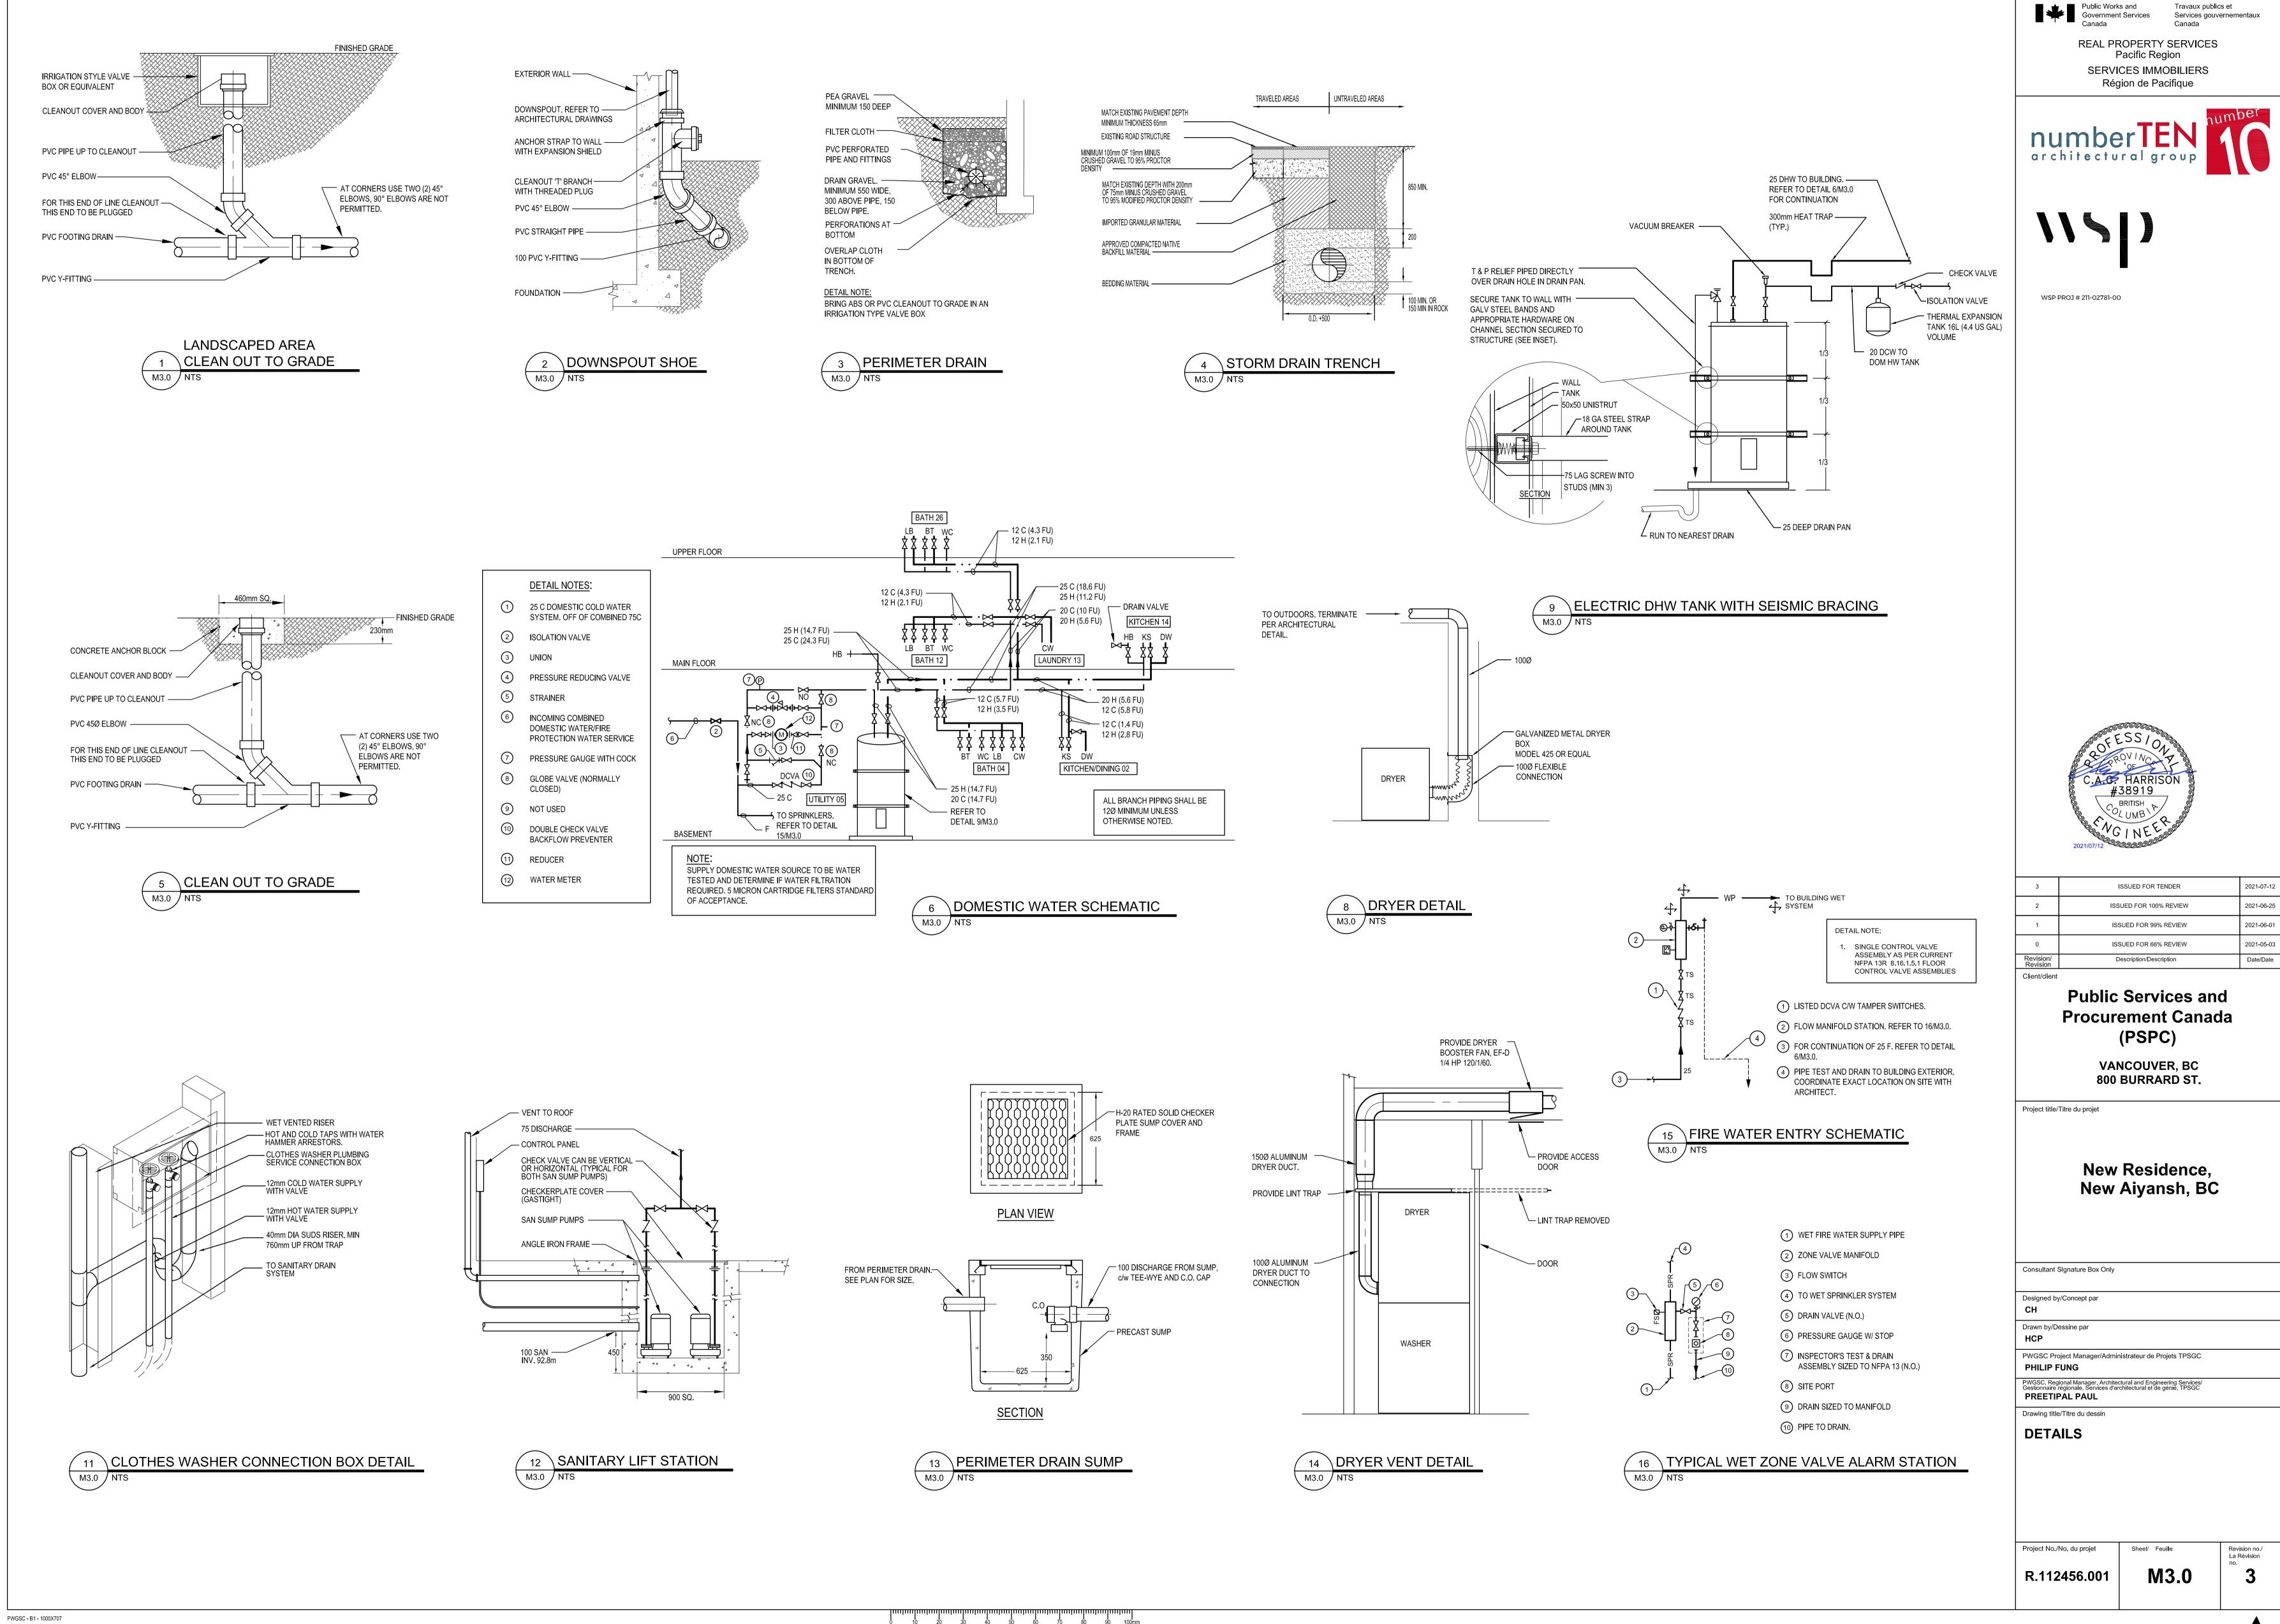

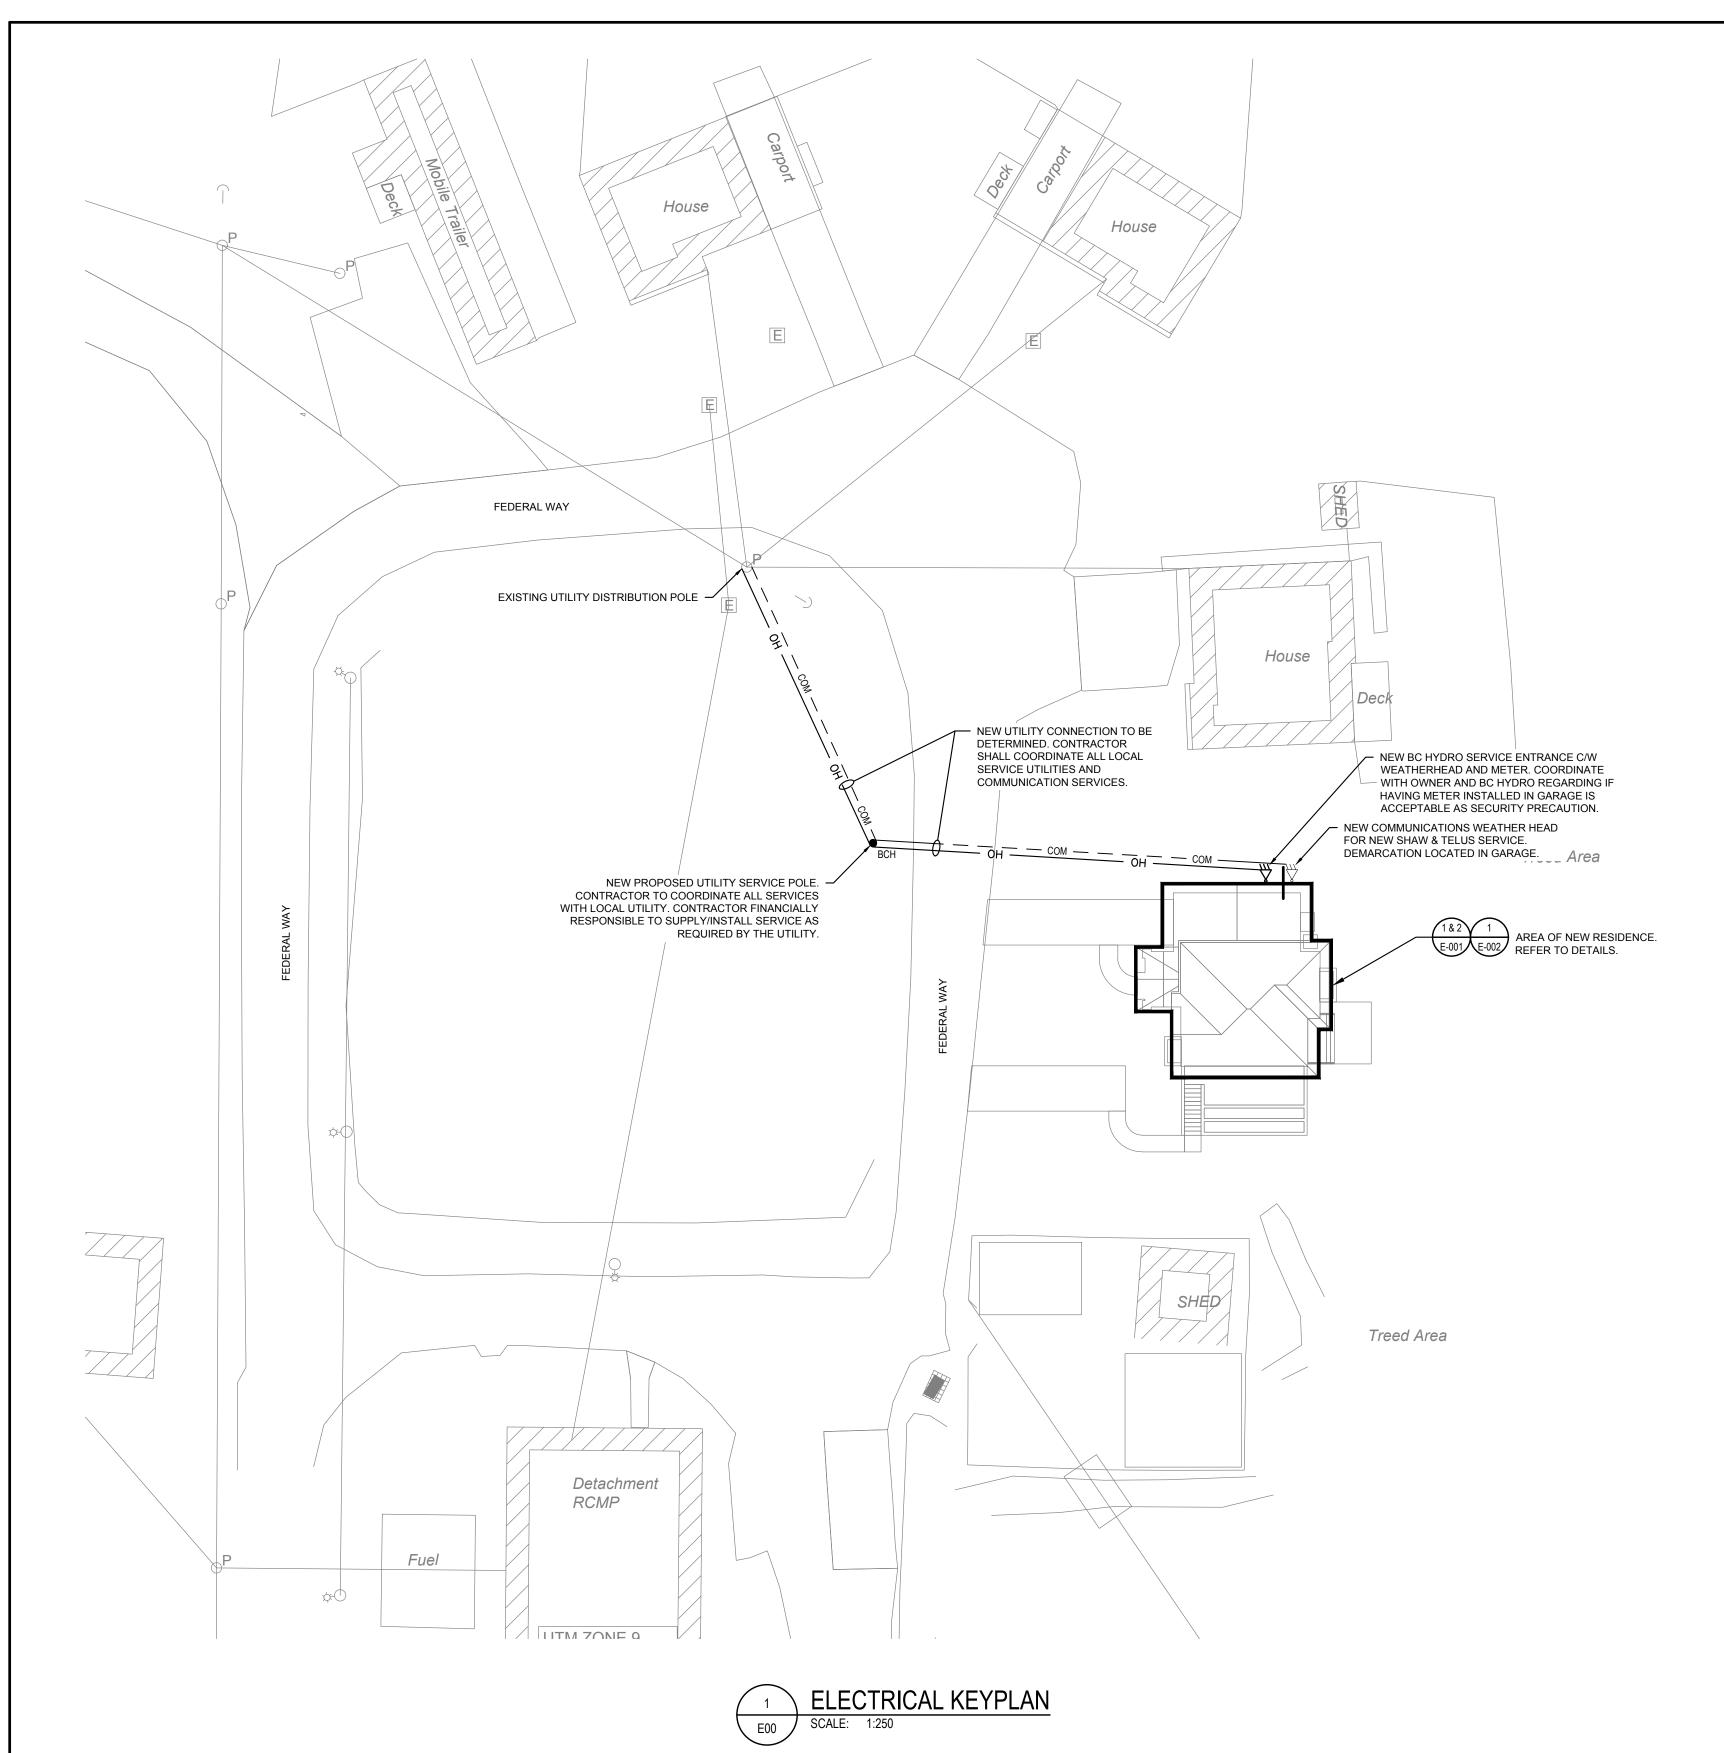

GENERAL NOTES:

- 1. CONTRACTOR SHALL READ ELECTRICAL DRAWINGS IN CONJUNCTION WITH ARCHITECTURAL, STRUCTURAL, MECHANICAL AND CIVIL DRAWINGS IN ORDER TO PROVIDE A COMPLETE AND ACCURATE TENDER BID.
- 2. CONTRACTOR SHALL PROVIDE ALL SEISMIC BRACING, RESTRAINTS, AND ASSOCIATED HARDWARE, AS REQUIRED. ENGAGE A STRUCTURAL ENGINEER TO ADVISE AND REVIEW SEISMIC ANCHORAGE AND RESTRAINT OF NEW ELECTRICAL
- 3. EXISTING INFORMATION WITHIN THESE DRAWINGS IS BASED ON INFORMATION PROVIDED BY OTHERS, EXTRACTED FROM HISTORICAL RECORDS AND SITE OBSERVATION.
- 4. ALL CONDUCTORS SHALL BE RUN IN CONDUIT SUITABLE FOR THE APPLICATION IN ACCORDANCE WITH THE LATEST
- 5. CONTRACTOR TO FIELD LOCATE THE EXACT ROUTING OF ALL FEEDERS AND PROVIDE AN INSTALLATION THAT IS THE LEAST OBTRUSIVE AND DISRUPTIVE TO THE FACILITY.
- 6. ALL CONDUITS CROSSING A SEISMIC GAP OR EXPANSION JOINT SHALL ALLOW UP TO 150mm MOVEMENT IN ALL DIRECTIONS.
- 7. CONTRACTOR IS RESPONSIBLE FOR APPLYING FOR TEMPORARY POWER BACKBOARD DURING CONSTRUCTION. COORDINATE WITH BC HYDRO.
- 8. CONTRACTOR TO COORDINATE WITH BCHYDRO AND SHAW/TELUS FOR NEW SERVICES, INCLUDING ALL FEES AND PERMITS AS NEEDED. ALLOW FOR A CASH ALLOWANCE OF \$25,000 FOR UTILITY DESIGN AND CONSTRUCTION.

	ANNO	TATIONS	3		
DENOTE	DESCRIPTION	DENOTE	DESCRIPTION		
BND	BOND WIRE (AS PER SPECIFICATIONS)	GFI	GROUND FAULT INTERRUPTOR		
GND	GROUND WIRE (#6)	SPD	SURGE PROTECTION DEVICE		
C/W	COMPLETE WITH	TR	TAMPER RESISTANT		
DISC	DISCONNECT	WT	WATER TIGHT		
WP	WEATHERPROOF	AFF	ABOVE FINISHED FLOOR		
AFG	ABOVE FINISHED GRADE				
SYMBOL	DESCRIPTION				
XXX	MECHANICAL EQUIPMENT TAG				
1	REFERENCE NOTE (1 DENOTES SEE NOTE 1)				
1	KITCHEN EQUIPMENT TAG				
1	OWNER SUPPLIED EQUIPMENT TAG				
1	CONDUIT TAG				
Δ	REVISION IDENTIFICATION TAG	REVISION IDENTIFICATION TAG			
A	PANEL IDENTIFICATION TAG	PANEL IDENTIFICATION TAG			
	NEW EQUIPMENT	NEW EQUIPMENT			
	EXISTING EQUIPMENT TO REMAIN	EXISTING EQUIPMENT TO REMAIN			

NOMENCLATURE PANEL DESIGNATION ——— CIRCUIT NUMBER ----

EXISTING EQUIPMENT TO BE REMOVED

	SINGLE LINE DIAGRAM SYMBOLS
SYMBOL	DESCRIPTION
38	POWER TRANSFORMER.
\sim	MOLDED CASE CIRCUIT BREAKER.
/ 9	UNFUSED VOLTAGE DISCONNECT SWITCH.
	FUSED DISCONNECT SWITCH.
	AUTOMATIC TRANSFER SWITCH WITHOUT MANUAL BYPASS
M	METER
	BUSBAR
\rightarrow	SERVICE CONNECTION
G	GENERATOR
	PANELBOARD
	PANELBOARD COMPLETE WITH MAIN BREAKER
M	UTILITY POWER METER

	POWER SYMBOLS
SYMBOL	DESCRIPTION
WP GFI O/C U/C DW F W D MW	DUPLEX 15A RECEPTACLE "WP" WHERE SHOWN, DENOTES DEVICE MOUNTED IN WEATHERPROOF F.S. BOX WITH WEATHERPROOF COVER "GFI" WHERE SHOWN, DENOTES GROUND FAULT INTERRUPTER TYPE DUPLEX RECEPTACLE "OC" WHERE SHOWN, DENOTES OVER THE COUNTER MOUNTED "UC" WHERE SHOWN, DENOTES UNDER THE COUNTER MOUNTED "DW,F,W,D,MW" RESIDENTIAL EQUIPMENT: DISHWASHER, FRIDGE, WASHER, DRYER, MICROWAVE
\$	SIMILAR TO ABOVE, BUT MOUNTED APPROXIMATELY 3'-6" (1050 mm) ABOVE FINISHED FLOOR LEVEL OR ABOVE COUNTER, UNLESS OTHERWISE NOTED.
4	15A DUPLEX RECEPTACLE PROTECTED BY GFI OUTLET OR BREAKER AT PANELBOARD. MOUNTED APPROXIMATELY 3'6" (1050 mm) AFF.
	TWO 15A DUPLEX RECEPTACLES IN COMMON FACEPLATE.
#	SIMILAR TO ABOVE, BUT MOUNTED APPROXIMATELY 3'-6" (1050 mm) ABOVE FINISHED FLOOR LEVEL OR ABOVE COUNTER.
(h)	15A DUPLEX RECEPTACLE, DAMP AREA RATED, CEILING MOUNTED. PROVIDE WP FLIP COVER IN DAMP AREAS.
 	20A DUPLEX RECEPTACLE (5-20R)
•	SPECIAL PURPOSE RECEPTACLE AS DENOTED
	HARDWIRED EQUIPMENT CONNECTION
PP LP	SINGLE SURFACE MOUNTED / FLUSH MOUNTED PANELBOARD, "PP" DENOTES POWER PANEL,"LP" DENOTES LIGHTING AND POWER PANEL,
LV LV	SINGLE SURFACE MOUNTED / FLUSH MOUNTED LOW VOLTAGE "LV" DENOTES LOW VOLTAGE PANEL
J	JUNCTION BOX
РВ	PULLBOX
● WP	FLUSH-MOUNTED PUSHBUTTON MOUNTED 4'-0" (1.2 m) ABOVE FINISHED FLOOR LEVEL. "WP" WHERE SHOWN, DENOTES WEATHERPROOF.
Ó	MOTOR
C	DISCONNECT SWITCH UNLESS NOTED OTHERWISE
	ELECTRIC BASEBOARD HEATER
T	THERMOSTAT
•	GROUND ROD

SYMBOL	DESCRIPTION
'A'	1'X4' SURFACE LUMINAIRE, LETTER "A" INDICATES LUMINAIRE TYPE AS PER LUMINAIRE SCHEDULE.
'A' \	RECESSED DOWNLIGHT
Ä	SURFACE MOUNTED DOWN LIGHT
, A.O.	WALL MOUNTED LUMINAIRE, LETTER `A' INDICATES TYPE AS PER LUMINAIRE SCHEDULE.
☆ 'A'	FLUSH WALL MOUNTED LUMINAIRE
'A <mark>'a a</mark>	SURFACE MOUNTED TRACK LUMINAIRE, LENGTH AS INDICATED; NUMBER OF HEADS INDICATED
0	UNDERCABINET LED 'PUCK' LIGHTING
\$ \$ # \$	ONE, TWO, THREE LINE VOLTAGE TOGGLE SWITCH AND LOW VOLTAGE SWITCH MOUNTED 4'-0" (1.2m) ABOVE FINISHED FLOOR LEVEL. UNLESS OTHERWISE NOTED.
3 4 D	"3" WHERE SHOWN, DENOTES 3-WAY SWITCH "4" WHERE SHOWN, DENOTES 4-WAY SWITCH "D" WHERE SHOWN, DENOTES DIMMER SWITCH
(S) (S)	OCCUPANCY SENSOR - CEILING MOUNTED, WALL MOUNTED

	COMMUNICATIONS SYMBOLS
SYMBOL	DESCRIPTION
▼	TELEPHONE DROP
WAP	WIRELESS ACCESS POINT
♦	CABLE TELEVISION SIGNAL OUTLET (CATV)
TSB	TELEPHONE/COMMUNICATIONS SIGNAL TERMINAL PLYWOOD BACKBOARD. COPPER BUSS BAR (PRE-DRILLED)
8	DOORBELL CHIME

FIRE ALARM SYMBOLS							
SYMBOL	DESCRIPTION						
C _A	COMBINATIONAL SMOKE ALARM / CARBON MONOXIDE DETECTOR (HARDWIRED CONNECTION)						
S _A	SMOKE ALARM (HARDWIRED CONNECTION) C/W 10 YEAR LITHIUM BATTERY (REFER TO CEC RULE 32-200 e)						
CO A	WALL MOUNTED CARBON MONOXIDE ALARM (HARDWIRED CONNECTION)						

	CC	DDE LOAD	
		MAIN DWELLING (137 m ²)	BASEMENT SUITE (58 m ²)
BASIC LOAD:	=	6000 W	5000 W
ELECTRIC HEATING LOADS:	=	-	-
RANGE:	=	6000 W	6000 W
WATER HEATER: 4500 W x 25%	=	1125 W	-
DRYER: 4000 W x 25%	=	1000 W	1000 W
SUB TOTAL:	=	13750 W	12000 W
DEMAND (CEC 8-200 [2]):	=	13750 W	7800 W
BREAKER RATING:	=	SEE SERVICE SIZE	70 A
HEAT PUMP HP-1:	=	14400 W	
HRV HEATER:	=	4000 W	
DEMAND TOTAL:	=	39950 W	
AMPS @ 240V, 1φ	=	167 A	
SERVICE SIZE:	=	200A SERVICE	

DRAWING LIST								
DRAWING NUMBER	DRAWING NAME							
E00	ELECTRICAL LEGEND, SITE PLAN, AND DRAWING LIST							
E01	MAIN FLOOR AND BASEMENT PLAN - ELECTRICAL							
E02	UPPER FLOOR AND ROOF PLAN - ELECTRICAL							
E03	ELECTRICAL DETAILS							
E04	ELECTRICAL SCHEDULES							
E05	ELEVATIONS							



REAL PROPERTY SERVICES
Pacific Region



SERVICES IMMOBILIERS Région de Pacifique



WSP PROJ # 211-02781-00



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Public Services and Procurement Canada (PSPC)

> VANCOUVER, BC 800 BURRARD ST.

Project title/Titre du projet

New Residence New Aiyansh, BC

Consultant Signature Box Only
Designed by/Concept par
NJS
Drawn by/Dessine par NJS
PWGSC Project Manager/Administrateur de Projets TPSGC
PHILIP FUNG
PWGSC, Regional Manager, Architectural and Engineering Services/ Gestionnaire régionale, Services d'architectural et de génie, TPSGC PREETIPAL PAUL
Drawing title/Titre du dessin

SINGLE FAMILY HOUSE ELECTRICAL LEGEND, SITE PLAN,

AND DRAWING LIST

NEW EMPLOYEE HOUSING

R.112456.001

E00

GENERAL NOTES:

- 1. PROVIDE ARC FAULT PROTECTION OF ALL 125V RECEPTACLES RATED 20A OR LESS AS PER LATEST EDITION OF CEC, RULE
- 2. SMOKE ALARMS (INCLUDING COMBINATION TYPE ALARMS) ARE TO BE INTERCONNECTED IN EACH UNIT AS PER BCBC 9.10.19.5.
- 3. LOCATE COMBINATION CO/SMOKE ALARM MINIMUM 1500mm [5'-0"] AWAY FROM FUEL-BURNING APPLIANCES.
- 4. PROVIDE ALL HARDWIRED DOORBELL SYSTEMS C/W WIRING, PUSHBUTTONS, TRANSFORMERS, CHIME AND MOUNTING EQUIPMENT AS REQUIRED FOR A COMPLETE AND OPERATIONAL SYSTEM.
- 5. PROVIDE A CEILING RECEPTACLE IN THE GARAGE LOCATED AS CLOSE AS POSSIBLE TO DOOR OPERATOR.
- 6. COORDINATE GARAGE DOOR SYSTEM WITH GARAGE DOOR SUPPLIER, INCLUDING WIRING, DOOR SENSORS, PUSHBUTTON AND DOOR OPERATOR AS REQUIRED.
- 7. EFFLUENT FILTER ALARM AS SUPPLIED BY EFFLUENT FILTER MANUFACTURER.

KEYNOTES:

- 1 PROVIDE A CIRCUIT AND LOCAL DISCONNECT FOR DUCT HEATER. COORDINATE WITH THE MECHANICAL CONTRACTOR ON SITE.
- PROVIDE A GFI-PROTECTED OUTLET C/W FLIP COVER WITHIN SOFFIT FOR HOLIDAY LIGHTING. OUTLET TO BE RATED FOR DAMP LOCATIONS.
- 3 SANITARY SUMP PUMPS. PROVIDE 15A DEDICATED CIRCUIT TO CONTROLLER BOX AND COORDINATE FINAL CONNECTIONS WITH MECHANICAL. CONTROLS AND PUMP BY MECHANICAL.
- (4) IRRIGATION RECEPTACLE. CONTRACTOR TO COORDINATE WITH THE MECHANICAL CONTRACTOR ON SITE FOR FINAL LOCATION.
- 5 CONTROL PANEL FOR SUMP PUMPS. CONTRACTOR TO COORDINATE WITH THE MECHANICAL CONTRACTOR ON SITE FOR FINAL LOCATION.
- 6 CENTER OVER LOCATION OF DINING TABLE. COORDINATE WITH ARCHITECT.



REAL PROPERTY SERVICES Pacific Region SERVICES IMMOBILIERS Région de Pacifique





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PWGSC, Regional Manager, Architectural and Engineering Services/ Gestionnaire régionale, Services d'architectural et de génie, TPSGC PREETIPAL PAUL


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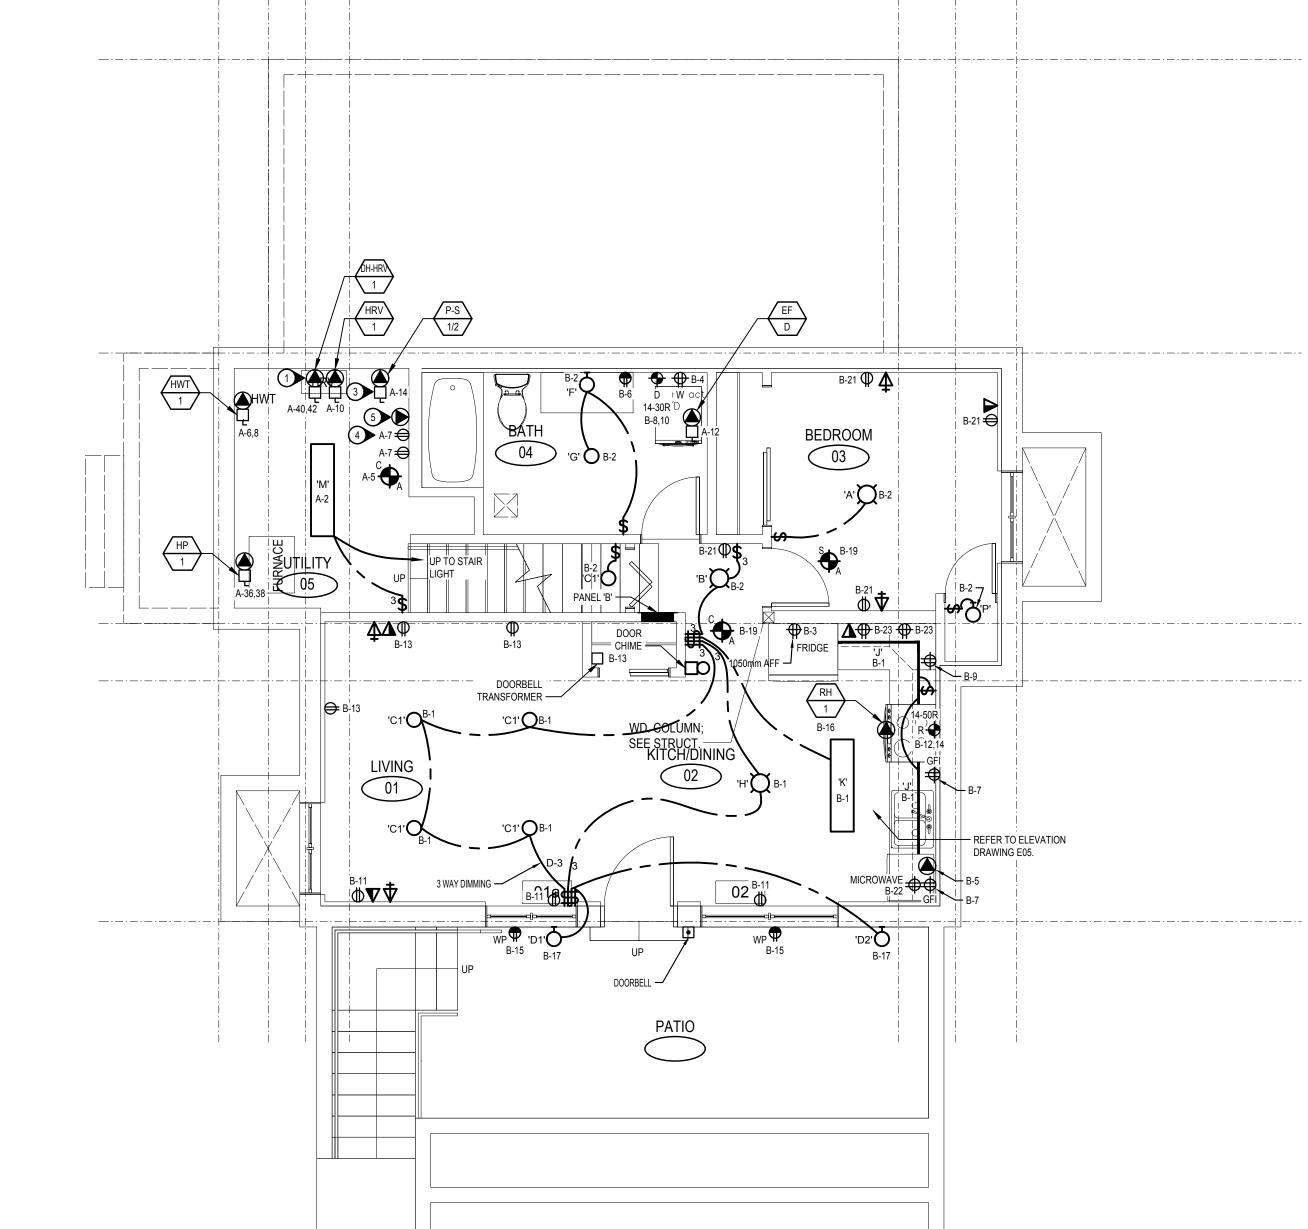
NEW EMPLOYEE HOUSING SINGLE FAMILY HOUSE


MAIN FLOOR AND BASEMENT PLAN -ELECTRICAL

R.112456.001

E01



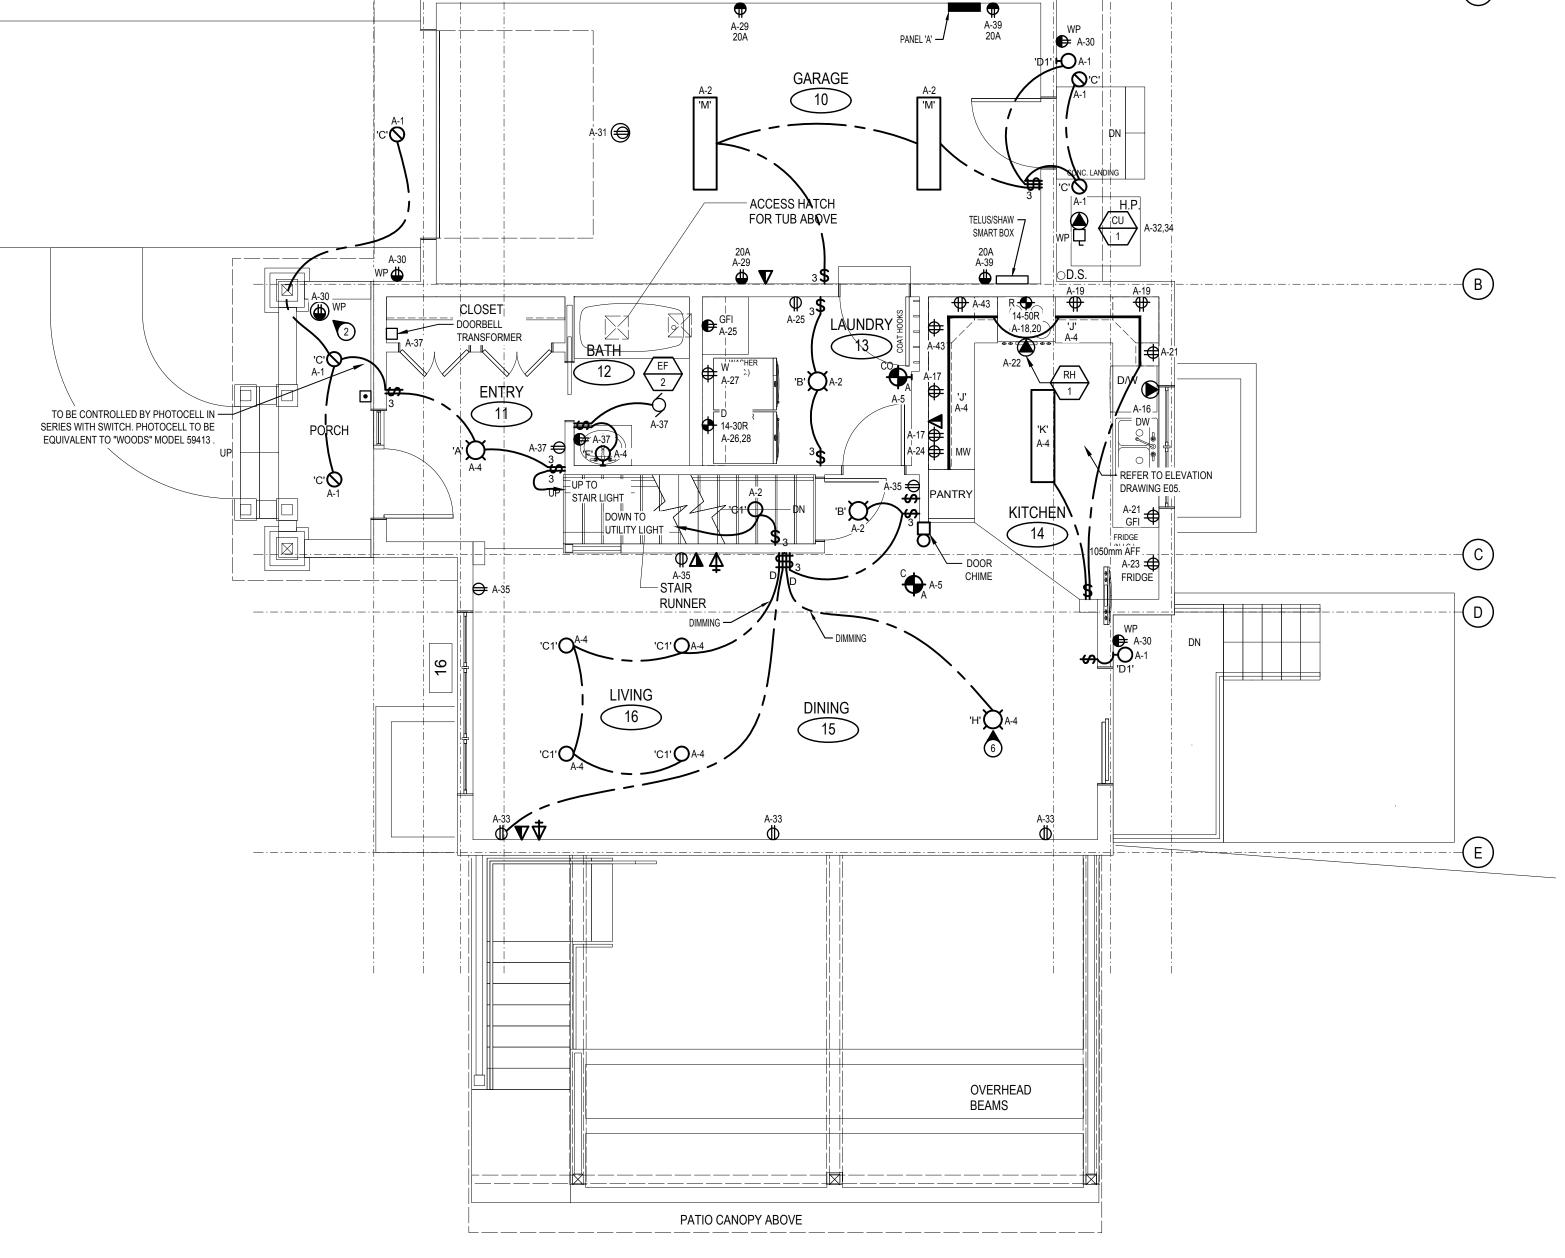

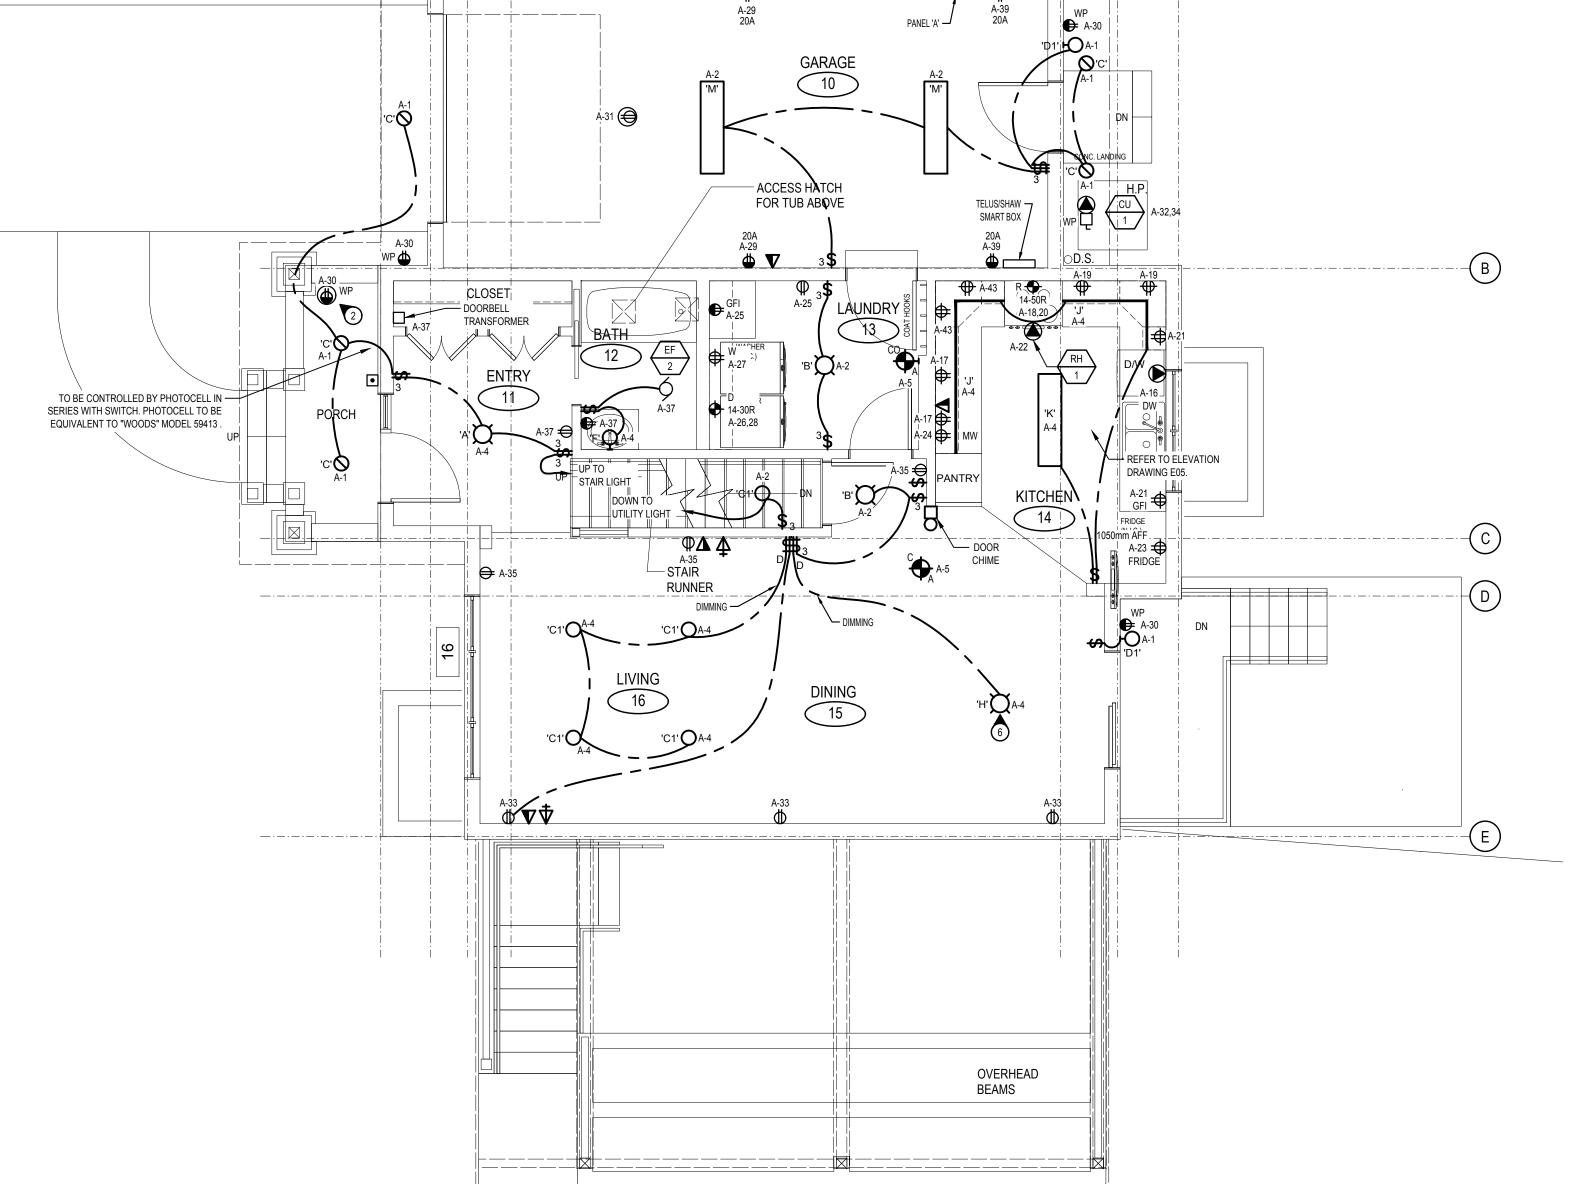

BC HYDRO METER. CONFIRM FINAL LOCATION ON

SITE WITH HYDRO.

BASEMENT PLAN - ELECTRICAL

CONC. LANDING

2 MAIN FLOOR PLAN - ELECTRICAL

GENERAL NOTES:

- 1. PROVIDE ARC FAULT PROTECTION OF ALL 125V RECEPTACLES RATED 20A OR LESS AS PER LATEST EDITION OF CEC, RULE
- 2. SMOKE ALARMS (INCLUDING COMBINATION TYPE ALARMS) ARE TO BE INTERCONNECTED IN EACH UNIT AS PER BCBC 9.10.19.5.



Public Works and Government Services Services gouvernementaux Canada

Travaux publics et Services gouvernementaux Canada

REAL PROPERTY SERVICES
Pacific Region SERVICES IMMOBILIERS Région de Pacifique





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1	ISSUED FOR 99% REVIEW	2021-06-01
0	ISSUED FOR 66% REVIEW	2021-05-03
Revision/ Revision	Description/Description	Date/Date

Public Services and Procurement Canada (PSPC)

VANCOUVER, BC 800 BURRARD ST.

Project title/Titre du projet

New Residence New Aiyansh, BC

Consultant Signature Box Only

Drawn by/Dessine par

PWGSC Project Manager/Administrateur de Projets TPSGC PHILIP FUNG

PWGSC, Regional Manager, Architectural and Engineering Services/ Gestionnaire régionale, Services d'architectural et de génie, TPSGC PREETIPAL PAUL

Drawing title/Titre du dessin

NEW EMPLOYEE HOUSING SINGLE FAMILY HOUSE


UPPER FLOOR AND ROOF PLAN -ELECTRICAL


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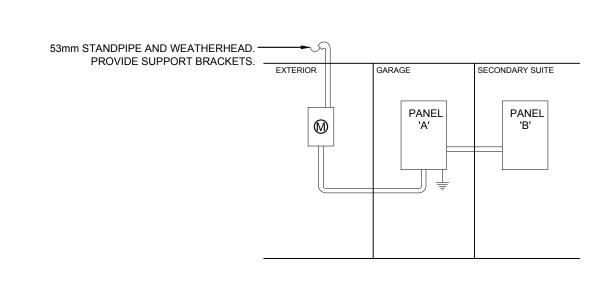
E02

BEDROOM 3 BEDROOM 1 1 UPPER FLOOR PLAN - ELECTRICAL


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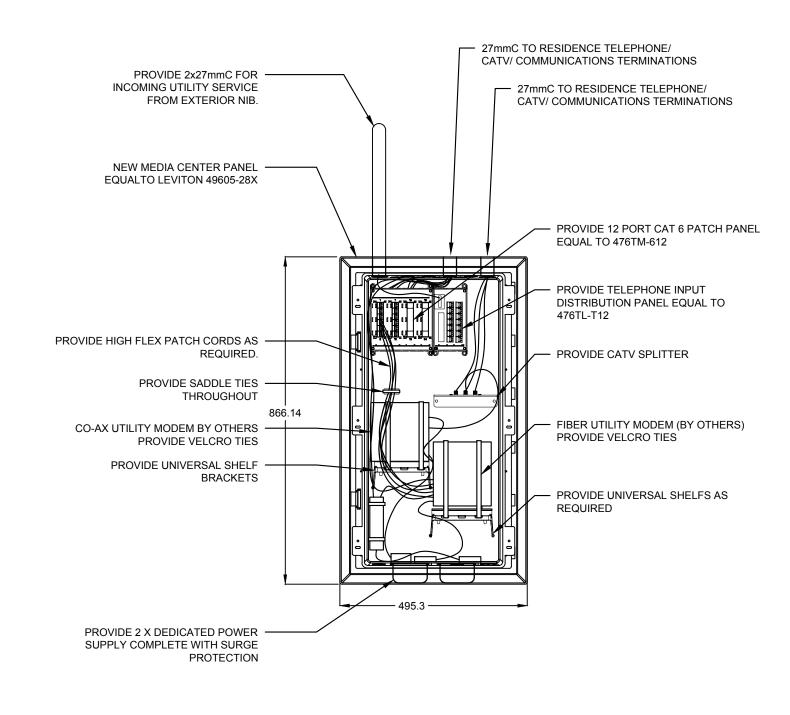





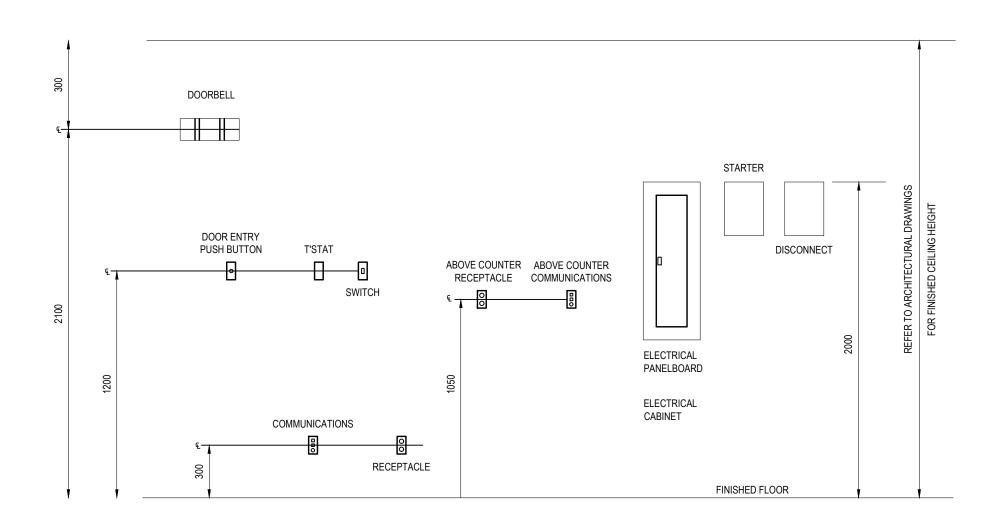


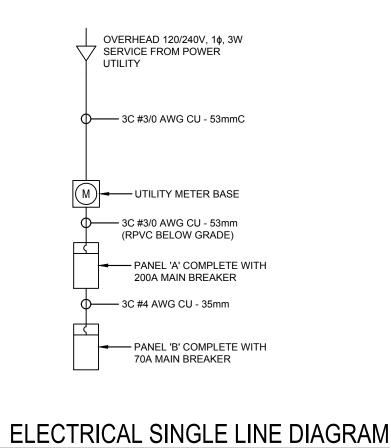




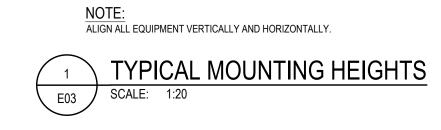

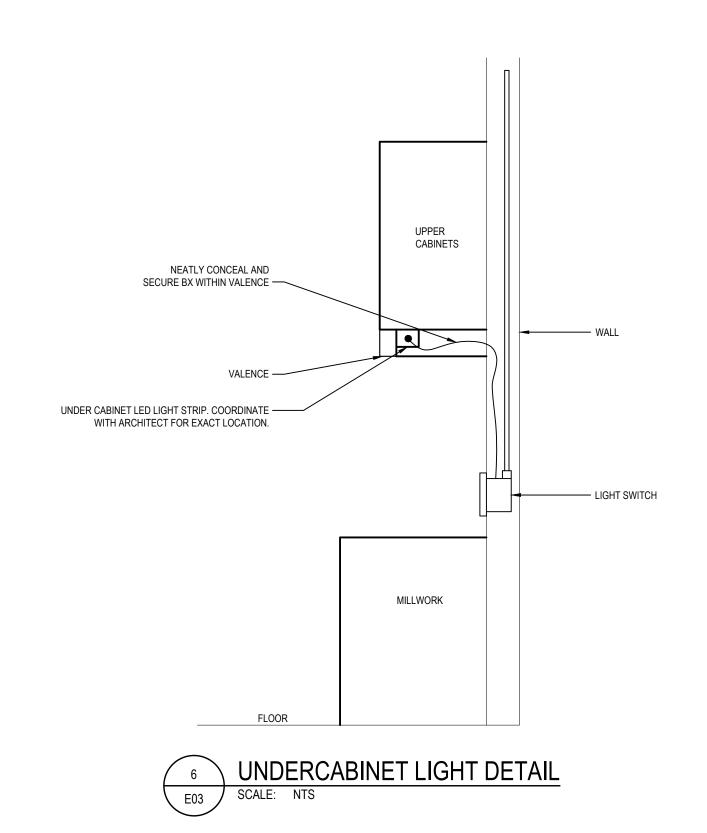

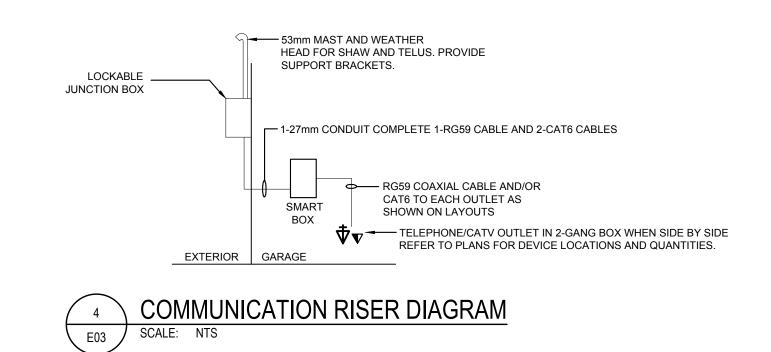



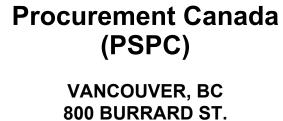

ISSUED FOR TENDER

ISSUED FOR 100% REVIEW

ISSUED FOR 99% REVIEW

ISSUED FOR 66% REVIEW

Description/Description

Public Services and

Public Works and Government Services Services gouvernementaux Canada

Travaux publics et Services gouvernementaux Canada

REAL PROPERTY SERVICES Pacific Region SERVICES IMMOBILIERS Région de Pacifique

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WSP PROJ # 211-02781-00

800 BURRARD ST.

Project title/Titre du projet

New Residence New Aiyansh, BC

Consultant Signature Box Only

Designed by/Concept par

Drawn by/Dessine par

PWGSC Project Manager/Administrateur de Projets TPSGC PHILIP FUNG

PREETIPAL PAUL Drawing title/Titre du dessin

NEW EMPLOYEE HOUSING

SINGLE FAMILY HOUSE

ELECTRICAL DETAILS

R.112456.001

RCMP New Employee Housing - New Aiyansh			w Aiyansh Project No: 211-02781-00							Date: July 13, 2021						Issue: 66% REVIEW									0 - NJS				
			POWER REQUIREMENTS						FIRE ALARM AUXILIARY PWR				STARTER					SCONN	IECT	CONTROL DEVICE									
TAG	DESCRIPTION	LOCATION	유	ΚW	Volts	Ŧ		MCA	OVERCURRENT	FEEDERS		Smoke Shut-off			Delayed Vital	Standby	Туре	Location	SI	w	Туре	s	I W	۷ Ту	/pe S	ı	w	NOTES	
CU-1	CONDENSING UNIT	EXTERIOR			240	1	23.8	28.9	30A-2P	3#10 TECK 90	N	N	N	N	N	N			M N	М	ND	Е	E E	=	I N	М	M 1,	3,4	
EF-D	DRYER BOOSTER FAN	BATH 04	0.25		120	1			15A-1P	2#12 + GND	Y	N	N	N	N	N	OA				ND	Е	E E	<u>: </u>	I N	М	M 1,2	2,6	
HP-1	HEAT PUMP	UTILITY ROOM		14.4	240	1			80A-2P	2#4 + GND	N	N	N	N	N	N			EE	E	ND	E	E E	-	Γ N	М	M 1,	3,4	
OH-HRV-	DUCT HEATER	UTILITY ROOM		4	120	1			25A-1P	2#12 + #GND	Y	N	N	N	N	N	SS		EE	E	ND	E	EE	-			M 1,4		
HRV-1	HEAT RECOVERY VENTILATOR	UTILITY ROOM		0.25	120	1			15A-1P	2#12 + GND	Y	N	N	N	N	N	SS		EE	E	ND	E	EE	_ T	C M	М	M 1,	5	
HWT-1	ELECTRIC DOMESTIC HOT WATER HEATER	UTILITY ROOM		4.5	240	1			25A-2P	2#12 + GND	Y	N	N	N	N	N			M N	М	ND	Е	E E	-	ſ N	M	M 1		
RH-1	RANGE HOOD (BY OWNER)	SUITE KITCHEN AND MAIN KITCHENS		0.5	120	1	4		15A-1P	2#12 + GND	Y	N	N	N	N	N	DSC		EE	E		Е	E E	<u> </u>	м м	М	M 2		

NOTES:

1. PROVIDE DISCONNECT FOR UNIT (WEATHERPROOF WHERE REQUIRED).

2. BUILT-IN SWITCH ON OWNER SUPPLIED UNIT. 3. POWER TO HP-1 IS SUB-FED FROM CU-1.

4. MOUNT AND CONNECT TO MECHANICALLY SUPPLIED THERMOSTAT 5. PROVIDE WALL MOUNTED SWITCH. COORDINATE LOCATION WITH MECHANICAL CONTRACTOR.

6. CONNECT POWER TO CONTROL BOX (SUPPLIED BY MECHANICAL). INSTALL FLOATS AS REQUIRED BY MANUFACTURER..

GENERAL NOTES

1. Magnetic starters with pilot light and four auxiliary dry contacts for interlocks, 2 NO and 2 NC; thermal overload protection (review Mechanical shop drawings to ensure proper selection); flexible connections for power wiring to all equipment.

2. Shafts for ducts and/or pipes cannot used for electrical distribution.

3. Line voltage thermostats shall be supplied by Mechanical and installed by Electrical.

4. Electrical contractor to confirm nameplate ratings prior to installation.

				P	AN	IEL	'A'		
	9	Voltage: Location: Mounting: Bus Size: nt Rating: Other:	2	G/ SU 22 10	JRF 5A kA	AGE		AKER, SUPPLY FROM UTILITY METER	ł ·
сст	Description	Bkr	Р	A	В	Р	Bkr	Description	cc
1	EXTERIOR LIGHTS	15A	1			1	15A	INTERIOR LIGHTING	2
3	INTERIOR LIGHTING	15A	1			1	15A	INTERIOR LIGHTING	4
5	SMOKE ALARMS	15A	1			2	254	HOT WATER TANK 1	6
7	UTILITY ROOM RECEPT.	15A	1	in		2	23A	HOT WATER TANK T	8
9	UPPER BATH RECEPT. FAN	15A	1			1	15A	HRV-1	10
11	UPPER BEDROOM RECEPT.	15A	1			1	15A	BOOSTER FAN	12
13	UPPER BEDROOM RECEPT.	15A	1			1	15A	SANITARY DUPLEX SUMP PUMP	14
15	UPPER BEDROOM RECEPT.	15A	1			1	15A	DISHWASHER	16
17	COUNTER RECEPT.	20A	1			2	504	RANGE	18
19	COUNTER RECEPT.	20A	1			2	30A	MINGE	20
21	COUNTER RECEPT.	20A	1			1	15A	RANGEHOOD FAN	22
23	FRIDGE	15A	1			1	15A	MICROWAVE	24
25	LAUNDRY RECEPT.	15A	1	11		2	204	CLOTHES DRYER	26
27	CLOTHES WASHER	20A	1			2	JUA	CLOTHES DRTER	28
29	GARAGE RECEPT.	20A	1			1	15A	EXTERIOR RECEPT.	30
31	GARAGE DOOR OPERATOR	15A	1	in		2	300	CONDENSING UNIT CU-1	32
33	LIVING ROOM RECEPT.	15A	1			2	JUA	CONDENSING ONLY CO-1	34
35	LIVING ROOM RECEPT.	15A	1			2	904	HEAT PUMP HP-1	36
37	MAIN BATH RECEPT. & ENTRY	15A	1			2	OUA	HEAT FOWE HEST	38
39	GARAGE RECEPT.	20A	1			2	254 4104	4KW DUCT HEATER - HRV-1	40
41	COUNTER RECEPT.	20A	1	1, 1		2	ZJA	THE BOOT REALER - HRV-1	42
43	COUNTER RECEPT.	20A	1	(E		1	15A	SPARE	44
45	SPARE	15A	1			1	15A	SPARE	46
47	SPARE	15A	1			1	15A	SPARE	48
49	SPARE	15A	1			1	15A	SPARE	50
51	SPARE	15A	1			1		SPACE	52
53	SPACE		1			1		SPACE	54
55	SPACE	- 1	1			1		SPACE	56
57	SPACE		1			1		SPACE	58
59	SPACE		1			1		SPACE	60

				P	AΝ	IEL	'B'		
Location: Mounting: Bus Size: Fault Current Rating:									
сст	Description	Bkr	Р	A	В	Р	Bkr	Description	ССТ
1	KITCHEN LIGHTING	15A	1	1		1	15A	BATH/BEDROOM LIGHTING	2
3	FRIDGE	20A	1		П	1	20A	CLOTHES WASHER	4
5	DISHWASHER	15A	1	Г		1	15A	BATH. SINK RECEPT.	6
7	COUNTER RECEPT.	20A	1		П	_	204	OLOTHEO DOVED	8
9	COUNTER RECEPT.	20A	1	Г		2	3UA	CLOTHES DRYER	10
11	LIVING ROOM RECEPT.	15A	1		П	^	504	BANGE	12
13	LIVING ROOM RECEPT.	15A	1	Г		2	AUC	RANGE	14
15	EXTERIOR RECEPT.	15A	1		П	1	15A	RANGEHOOD FAN	16
17	EXTERIOR LIGHTING	15A	1			1	15A	SPARE	18
19	SMOKE ALARM	15A	1		П	1	15A	SPARE	20
21	BEDROOM RECEPT.	15A	1			1	15A	MICROWAVE	22
23	COUNTER RECEPT.	20A	1		П	-1		SPACE	24
25	SPARE	15A	1			1		SPACE	26
27	SPARE	15A	1		П	1		SPACE	28
					$\overline{}$	1	_	SPACE	30

TYPE	DESCRIPTION		TYPICAL LOCATION	NOTES
A	LARGE SURFACE MOUNT - 16" DIAMETER 3x12W LED		BEDROOM LIMNG ROOM ENTRY	120V, 2900K
В	SURFACE MOUNT - 12" DIAMETER 1x12W LED		HALLWAY	120V, 2900K
c	RECESSED - 6" DIAMETER 1x12W LED		EXTERIOR	120V, 2900K
C1	RECESSED - 4" DIAMETER 1x12W LED		INTERIOR	120V, 2900K
D1	WALL MOUNT - INTEGRAL MOTION SENSOR INTEGRAL LED LIGHT SOURCE		EXTERIOR	120V, 2900K
D2	WALL MOUNT - INTEGRAL LED LIGHT SORUCE		EXTERIOR	120V, 2900K
F	WALL MOUNT VANITY 3x12W LED		BATHROOM	120V, 2900K
G	RECESSED - 6" DIAMETER 1x12W LED		BATHROOM	120V, 2900K
н	PENDANT MOUNT 1x 24W LED GLOBE		DINING ROOM	120V, 2900K, CHROME FINISH
j	UNDER CABINET - LED STRIP	The state of the s	KITCHEN UNDERCABINET	230 LM/FT, 120V, 3000K, 3W/FT, FROSTED LENS AND MOUNTING HARDWARE
к	SURFACE LINEAR 4FT		KITCHEN	120V, 2900K
М	SURFACE LINEAR 4FT		GARAGE	120V, 2900K
N	WALL MOUNT		STAIRS	120V, 2900K
Р	WALL/CEILING MOUNT		CLOSET	120V, 2900K

LUMINAIRE SCHEDULE



REAL PROPERTY SERVICES Pacific Region SERVICES IMMOBILIERS Région de Pacifique



301-3600 Uptown blvd Victoria BC, Canada T+ 1 250-384-5510 F+ 1 250-386-2844

WSP PROJ # 211-02781-00



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Consultant Signature Box Only Drawn by/Dessine par PWGSC Project Manager/Administrateur de Projets TPSGC PHILIP FUNG PWGSC, Regional Manager, Architectural and Engineering Services/ Gestionnaire régionale, Services d'architectural et de génie, TPSGC PREETIPAL PAUL


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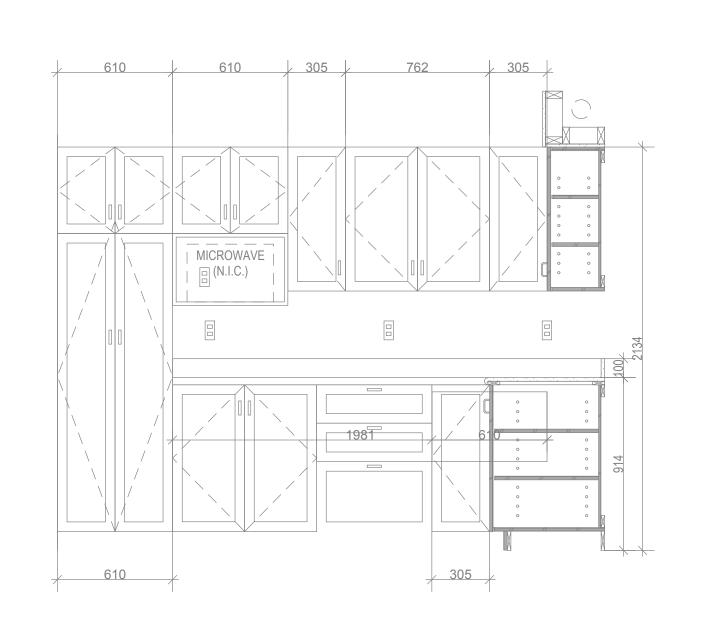
ELECTRICAL SCHEDULES


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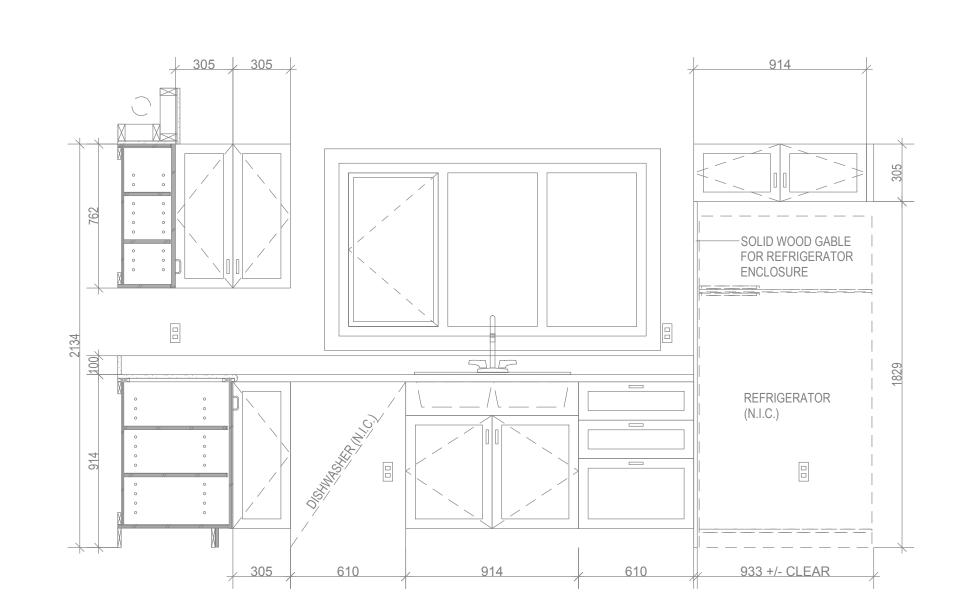
E04



MAIN FLOOR KITCHEN ELEVATION



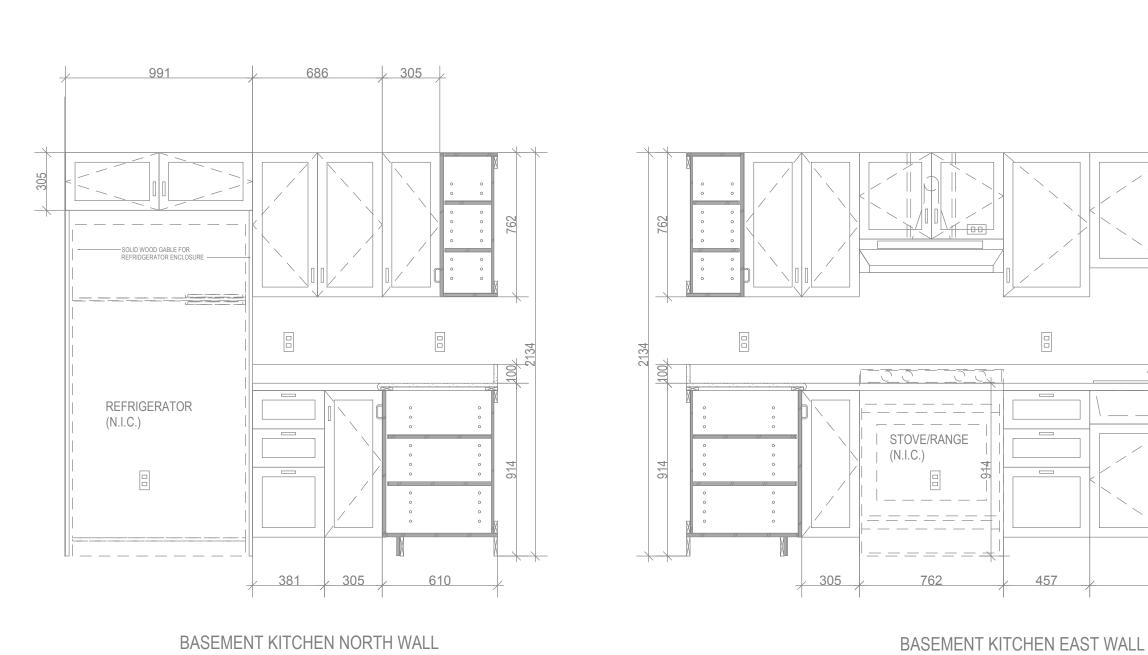

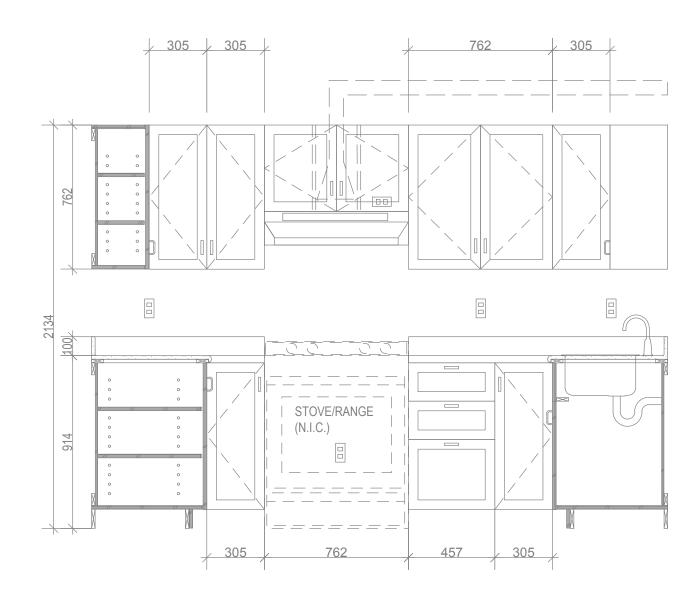

_ FILLER AS REQ.

MAIN FLOOR KITCHEN EAST WALL MAIN FLOOR KITCHEN NORTH WALL MAIN FLOOR KITCHEN EAST WALL






REAL PROPERTY SERVICES
Pacific Region SERVICES IMMOBILIERS Région de Pacifique





WSP PROJ # 211-02781-00

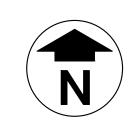



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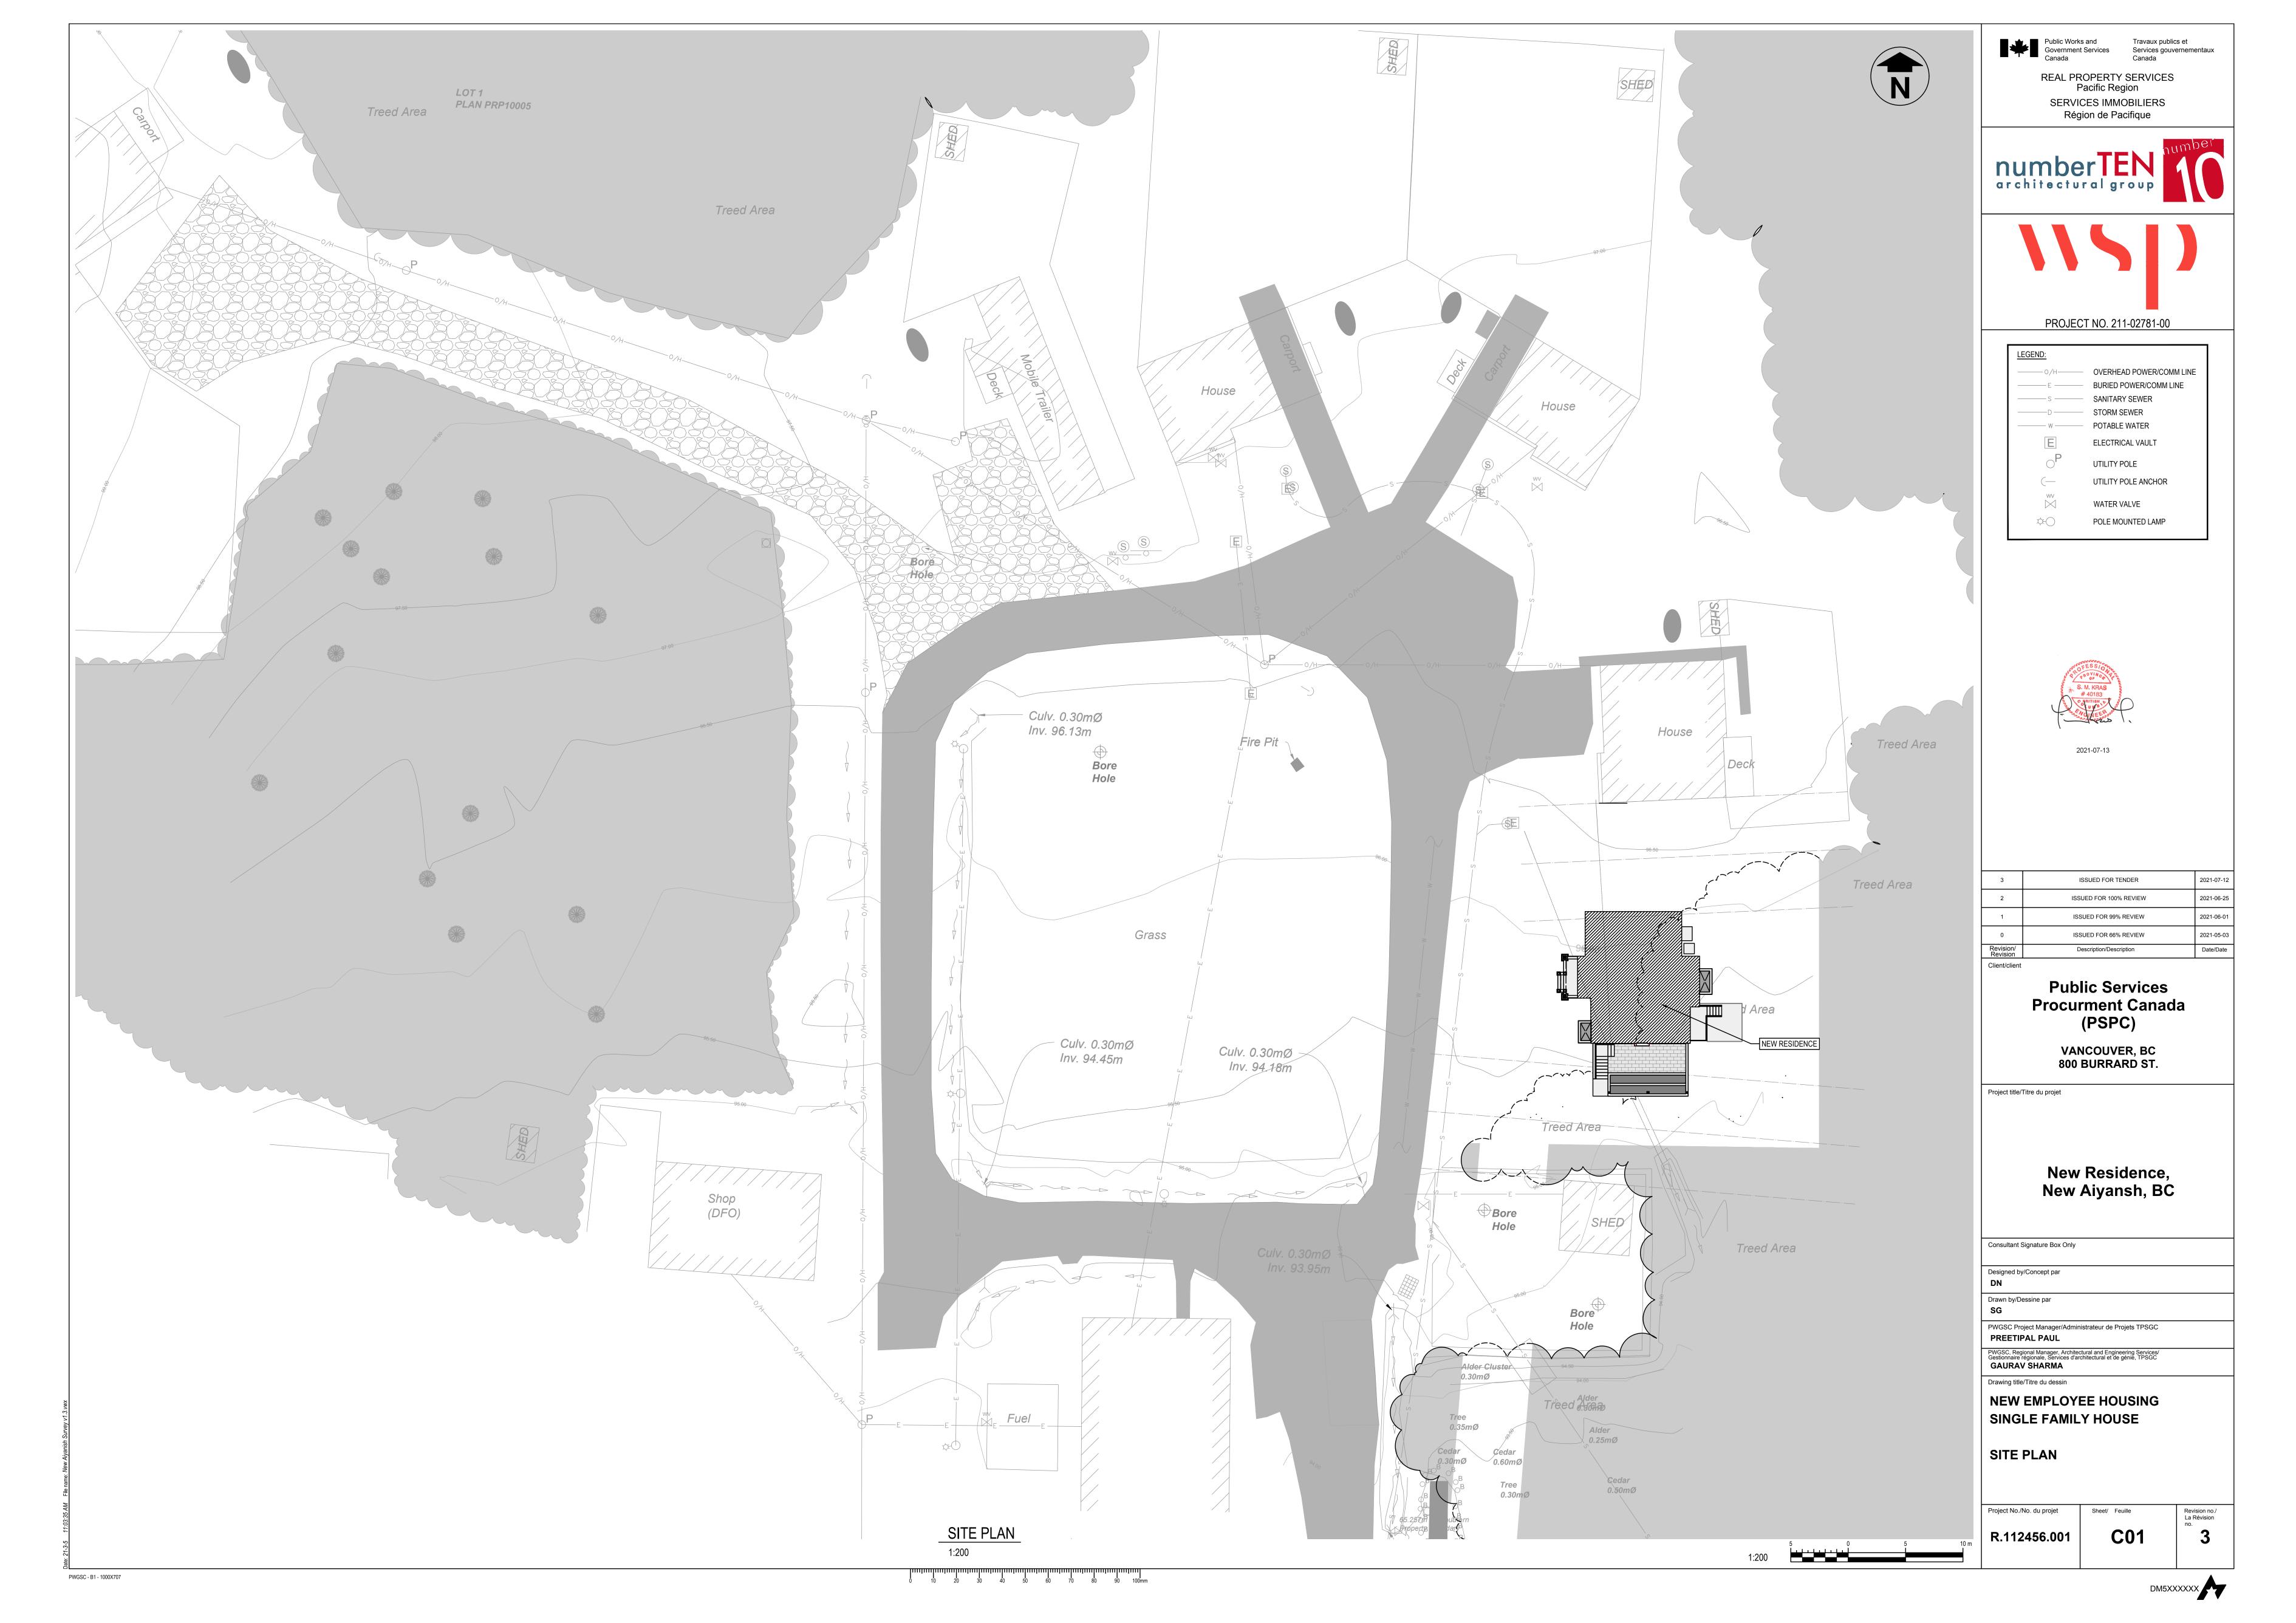
Drawing title/Titre du dessin

NEW EMPLOYEE HOUSING SINGLE FAMILY HOUSE

ELEVATIONS

R.112456.001





GENERAL NOTES: 1. ALL UTILITY LOCATIONS SHOWN ARE APPROXIMATE. CONTRACTOR TO CONFIRM UTILITY LOCATIONS PRIOR TO CONSTRUCTION. 2. ALL REMOVAL ITEMS TO BE DISPOSED OF AT A SUITABLE FACILITY. 3. ALL CONSTRUCTION AND MATERIALS TO BE IN ACCORDANCE WITH SPECIFICATIONS, AND THESE DRAWINGS; WHICHEVER IS MOST STRINGENT. CONTRACTOR SHALL BE SOLELY RESPONSIBLE FOR CONSTRUCTION MEANS, METHODS, TECHNIQUES, SEQUENCES AND PROCEDURES AND FOR COORDINATING THE VARIOUS PARTS OF THE WORK. 5. LOCATION SHOWN FOR EXISTING WATER SERVICE AND SANITARY SERVICE ARE APPROXIMATE AND MAY BE SIGNIFICANTLY DIFFERENT FROM ACTUAL LOCATION. ACTUAL CONFIGURATION SHOULD BE FIELD CONFIRMED. 6. CONTRACTOR IS RESPONSIBLE FOR MAINTENANCE OF AS-CONSTRUCTED RECORDS, WHICH ARE TO BE HANDED OVER TO ENGINEER UPON COMPLETION OF CONSTRUCTION. 7. CAREFULLY RELOCATE EXISTING LANDSCAPE FEATURES, TRAFFIC SIGNS AND SITE FEATURES TO ACCOMMODATE CONSTRUCTION WORK. ALL EXISTING WORKS AFFECTED BY CONSTRUCTION TO BE RETURNED TO AS FOUND OR BETTER CONDITION. 8. DISPOSE OF ALL EXCAVATED MATERIAL UNSUITABLE FOR REUSE AT A SUITABLE OFF-SITE DISPOSAL AREA, IN ACCORDANCE WITH ALL APPLICABLE REGULATIONS. 9. PROVIDE CLEAN SAWCUTS IN ASPHALT AND CONCRETE AT DEMOLITION LINES. 10. ANY CHANCE FIND OF ARCHAEOLOGICAL MATERIAL SHALL RESULT IN AN IMMEDIATE WORK STOPPAGE TO ALLOW FOR FURTHER ANALYSIS. STOP ALL ACTIVITY AND IMMEDIATELY NOTIFY ENGINEER OR DEPARTMENTAL REPRESENTATIVE IF ANY ARCHAEOLOGICAL MATERIAL IS ENCOUNTERED. 11. ANY ASPHALT DISTURBANCE TO BE RESTORED ACCORDING TO PAVEMENT STRUCTURE DETAIL. 12. FOLLOW ALL RECOMMENDATIONS IN GEOTECHNICAL REPORT BY WOOD DATED 13-OCT-2020. 13. REMOVE ANY TREES WITHIN 3m OF CENTRELINE OF STORM DRAIN, OR TREES WITH ROOTS LARGER THAN 50mm DIAMETER WITHIN LIMITS OF EXCAVATION. USE SHORING TO REDUCE WIDTH OF EXCAVATION TO 1.0m IN ORDER TO MINIMIZE TREE REMOVAL. ASSUMED TREE DENSITY: 1 TREE PER 13m². 14. ASSUMED TREE SIZE RANGE: 25% OF THE TREES WITHIN THE REQUIRED CLEARING AREA HAVE A TRUNK DIAMETER OF APPROXIMATE 300-400mm. 75% OF THE TREES WITHIN THE REQUIRED CLEARING AREA HAVE A TRUNK DIAMETER OF APPROXIMATELY 200-300mm. 15. MAINTAIN INVENTORY OF ANY TREES REMOVED INCLUDING TRUNK DIAMETER AND SPECIES, WITH A PHOTOGRAPH OF EACH TREE. 16. PLANT NEW TREES AT A 2:1 RATIO TO REPLACE TREES REMOVED, MATCHING THE SPECIES OF TREE REMOVED. ASSUME THE FOLLOWING PLANTING ARE REQUIRED: 8 POPLAR, 8 SPRUCE, 16 CEDAR. NEW TREES TO BE PLANTED AT A LOCATION SELECTED ON-SITE BY THE DEPARTMENTAL REPRESENTATIVE DURING CONSTRUCTION. **UTILITY NOTES:** 1. CONTRACTOR TO LOCATE AND IDENTIFY EXISTING WATER, SANITARY AND STORM CONNECTION POINTS PRIOR TO CONSTRUCTION. 2. CONTRACTOR TO CONFIRM SIZE, MATERIAL AND CLASS OF EXISTING PIPING AND TO SUBMIT PROPOSED CONNECTOR, FITTINGS AND ADAPTORS AT LEAST 1 WEEK PRIOR TO CONSTRUCTION. 3. PROVIDE 1.5m OF SOIL COVER ABOVE ALL BURIED UTILITIES. 4. ALL FITTINGS TO BE COMPATIBLE WITH PIPE MATERIAL AND PRESSURE CLASS. 5. A MINIMUM OF 1.0m HORIZONTAL CENTRE TO CENTRE AND 150mm CLEAR VERTICAL SEPARATION SHALL BE MAINTAINED BETWEEN WATER SERVICES AND ELECTRICAL, GAS AND TELEPHONE SERVICES EXCEPT WHERE NOTED. MAINTAIN 1.5m CENTRE TO CENTRE SEPARATION BETWEEN WATER AND SANITARY OR STORM SERVICES. 6. FOR CROSSING OF EXISTING SEWERS, WHERE WATER SERVICE DOES NOT HAVE THE REQUIRED 450mm VERTICAL SEPARATION, WRAP THE SEWER JOINTS WITH PETROLATUM TAPE 1.5m EITHER SIDE OF THE WATER SERVICE. WHERE A VERTICAL SEPARATION OF 150mm CAN NOT NE ACHIEVED, SPECIAL MITIGATION MEASURES SHALL BE APPROVED. 7. PRESSURE TEST AND FLUSH WATER SERVICE TO MINIMUM 100 PSI IN ACCORDANCE WITH NATIONAL PLUMBING CODE. 8. PRESSURE TEST SANITARY PRESSURE SERVICE TO MINIMUM 50 PSI. 9. STORM PIPE TO BE PVC SDR35 TO CSA C182.2. 10. WATER SERVICE TO BE MUNICIPAL SERVICE TUBING, SERIES 200, TO CSA B137.1. 11. SANITARY SERVICE TO BE HDPE DR17 4710 TO CSA B137.1. GEOTECHNICAL AND MATERIALS TESTING FOR SITE WORKS THE CONTRACTOR WILL BE REQUIRED TO RETAIN AND PAY FOR THE SERVICES OF A QUALIFIED INDEPENDENT GEOTECHNICAL TESTING AGENCY UNDER THE SUPERVISION OF A REGISTERED PROFESSIONAL ENGINEER, AND PAY THE COST OF TESTING SERVICES FOR QUALITY CONTROL SEE SPECIFICATIONS FOR DETAILS.







Travaux publics et Services gouvernementaux

Région de Pacifique

REAL PROPERTY SERVICES Pacific Region **SERVICES IMMOBILIERS**





PROJECT NO. 211-02781-00



2021-07-13

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Client/client

Public Services Procurment Canada (PSPC)

VANCOUVER, BC 800 BURRARD ST.

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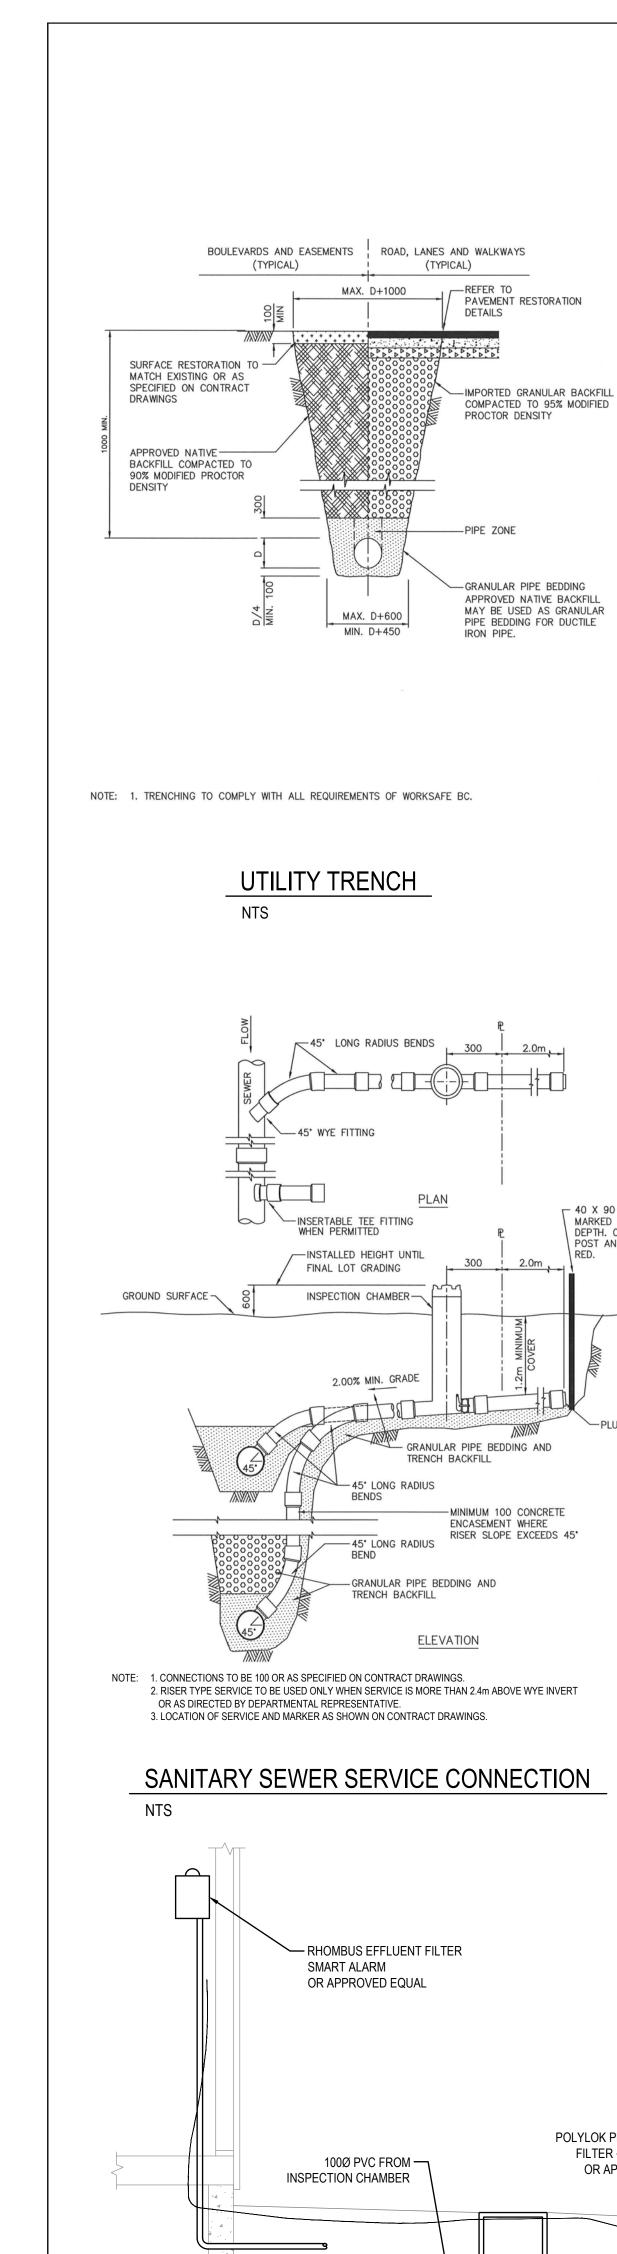
New Residence, New Aiyansh, BC


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Designed by/Concept par DN
Drawn by/Dessine par SG
PWGSC Project Manager/Administrateur de Projets TPSGC PREETIPAL PAUL
PWGSC, Regional Manager, Architectural and Engineering Services/ Gestionnaire régionale, Services d'architectural et de génie, TPSGC GAURAV SHARMA

Drawing title/Titre du dessin **NEW EMPLOYEE HOUSING** SINGLE FAMILY HOUSE

SERVICING PLAN

Project No./No. du projet La Révision R.112456.001



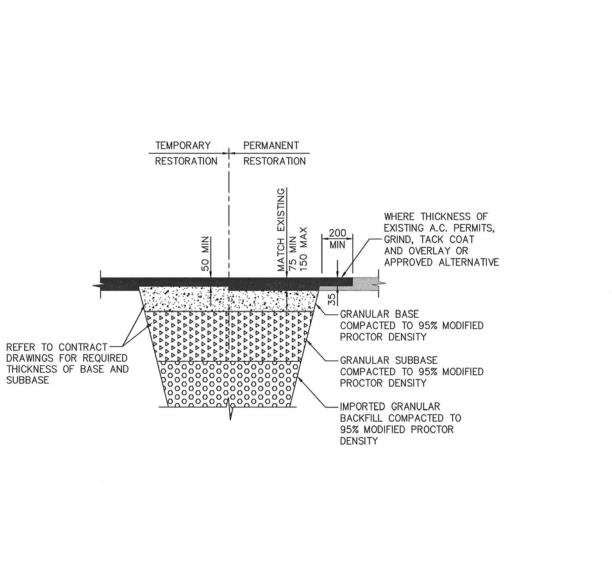

PAVEMENT RESTORATION

- 45' WYE FITTING

-- INSERTABLE TEE FITTING WHEN PERMITTED

-GRANULAR PIPE BEDDING AND

100 MINIMUM CONCRETE

RISER SLOPE EXCEEDS 45°

50mm HMAC ----

ENCASEMENT WHERE

TRENCH BACKFILL

-45' LONG RADIUS

TRENCH BACKFILL

NOTE: 1. CONCRETE STORM SEWER PIPES TO BE PROVIDED WITH SUPPLIER INSTALLED PVC STUB.

3. LOCATION OF SERVICE AND MARKER AS SHOWN ON CONTRACT DRAWINGS.

OR AS DIRECTED BY DEPARTMENTAL REPRESENTATIVE.

2. CONNECTIONS TO BE 100 MINIMUM OR LARGER AS SPECIFIED ON CONTRACT DRAWINGS.

3. RISER TYPE SERVICE TO BE USED ONLY WHEN SERVICE IS MORE THAT 2.4m ABOVE WYE INVERT

-GRANULAR PIPE BEDDING AND


ELEVATION

MARKED WITH DEPTH. COLOUR POST AND PLUG

45' LONG RADIUS BENDS


NTS


GROUND SURFACE -

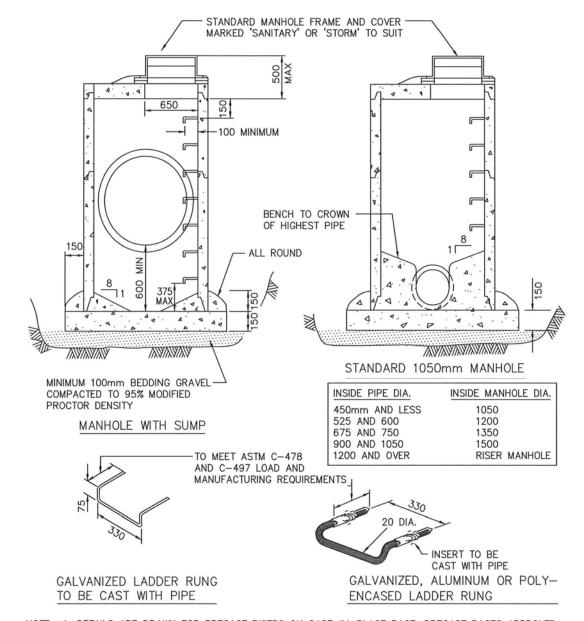




MANHOLE AND SUMP DETAILS

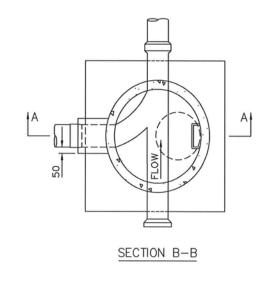

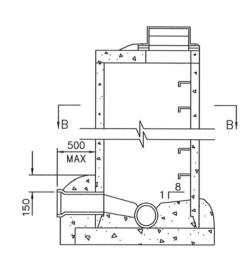

SECTION A-A

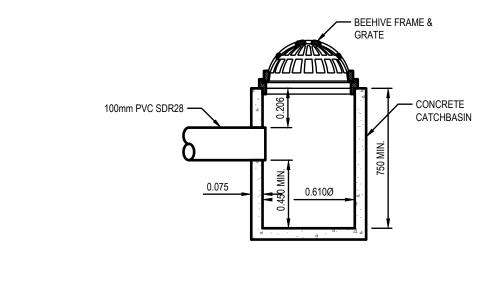

15M REBAR —

15M REBAR TIES -

BENT OVER AT TOP

SECTION (A

ELEVATION

SANDBAG ENDWALL FOR

CULVERT INLETS & OUTLETS

LAWN BASIN DETAIL

— DITCH GRADE

CONCRETE

— STANDARD SANDBAGS FILLED

WITH 15MPa WET PREMIXED

- TYPICAL DITCH SECTION

AT CULVERT INLETS AND OUTLETS

MANHOLE CONNECTION DETAILS



Government Services
Canada

Public Works and

REAL PROPERTY SERVICES Pacific Region

SERVICES IMMOBILIERS Région de Pacifique

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New Residence, New Aiyansh, BC

Consultant Signature Box Only Designed by/Concept par

Project title/Titre du projet

Drawn by/Dessine par

Client/client

PWGSC Project Manager/Administrateur de Projets TPSGC PREETIPAL PAUL

PWGSC, Regional Manager, Architectural and Engineering Services/ Gestionnaire régionale, Services d'architectural et de génie, TPSGC **GAURAV SHARMA**

NEW EMPLOYEE HOUSING

Drawing title/Titre du dessin

SINGLE FAMILY HOUSE

DETAILS

Project No./No. du projet

C03 R.112456.001


DM5XXXXXX

BRASS TABS COLLAR WITH 2-5/8" ALLEN HEAD CAP SCREWS -DR35 PVC RISER INSTALLED DEPTH FACTORY INSTALLED PLUG INSTALLATION IN BOULEVARD LID DETAIL CAST IRON LID--305 x 508 CONCRETE CONCRETE PULL BOX 37 SERIES BROOKS PRODUCTS LTD. OR APPROVED EQUIVALENT WITH STEEL CHEQUER PLATE LID PERMANENTLY MARKED 'SANITARY' AS REQUIRED. 4-CONCRETE JUMBO → INSTALLATION IN DRIVEWAY AND ROAD



NOTE: 1. INSPECTION CHAMBER TO BE APPROVED MANUFACTURED FITTING.

TYPICAL DRIVEWAY STRUCTURE

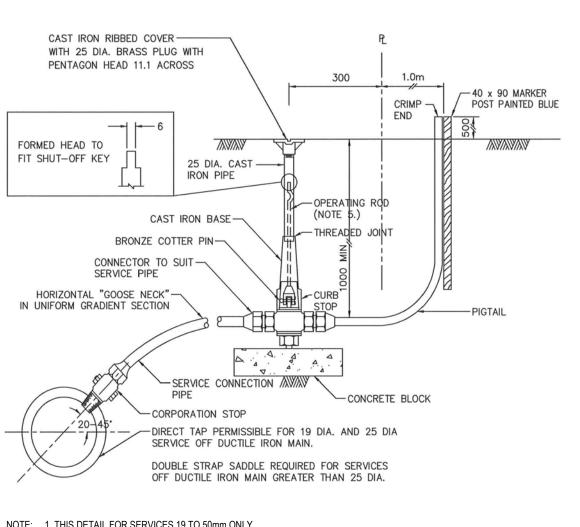


NOTE: 1. THIS DETAIL FOR SERVICES 19 TO 50mm ONLY. 2. INSTALL SERVICE PIPE WITH "GOOSE NECK" IN HORIZONTAL POSITION. 3. WHEN CURB STOP INSTALLED IN DRIVEWAY PLACE COVER IN CHAMBER MARKED "WATER". 4. OPERATING ROD DIAMETERS: • 14mm FOR 25mm OR SMALLER CURB STOPS. • 19mm FOR 32mm TO 50mm CURB STOPS.






└ 200mm - 25 CRUSHED ROCK, COMPACTED TO 95% MODIFIED PROCTOR DENSITY. └─ 250mm - 75 MINUS CRUSHED ROCK, COMPACTED TO 95% MODIFIED PROCTOR DENSITY EXISTING GROUND

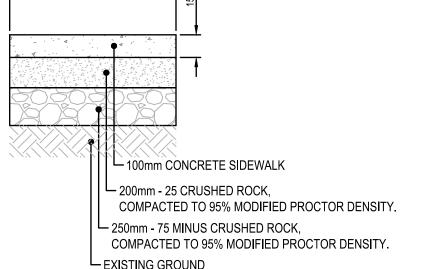


TYPICAL SIDEWALK DETAIL

0 10 20 30 40 50 60 70 80 90 100mm

SWALE DETAIL

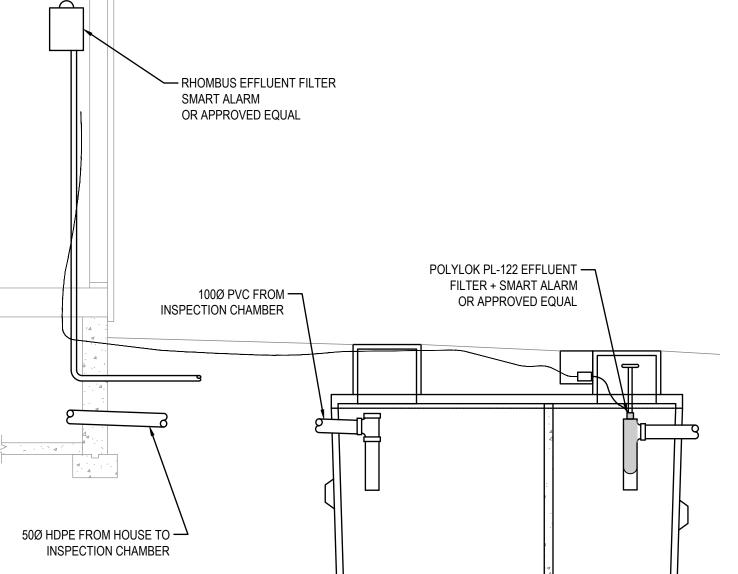

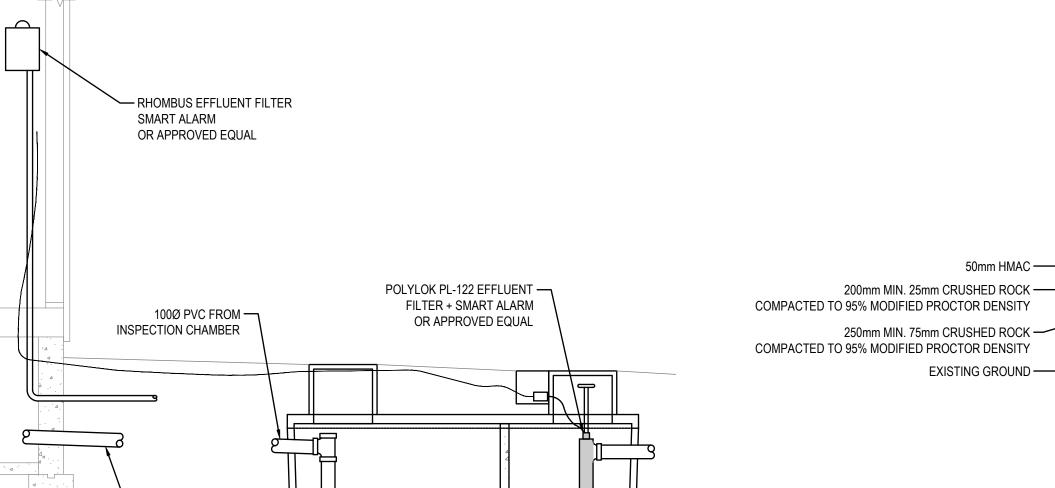

SEPTIC TANK (1200gal)


MARKED WITH DEPTH. COLOUR POST AND PLUG


STORM SEWER SERVICE CONNECTION

SANITARY SEWER SERVICE CONNECTION

PWGSC - B1 - 1000X707

SEWER TANK DETAIL

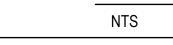

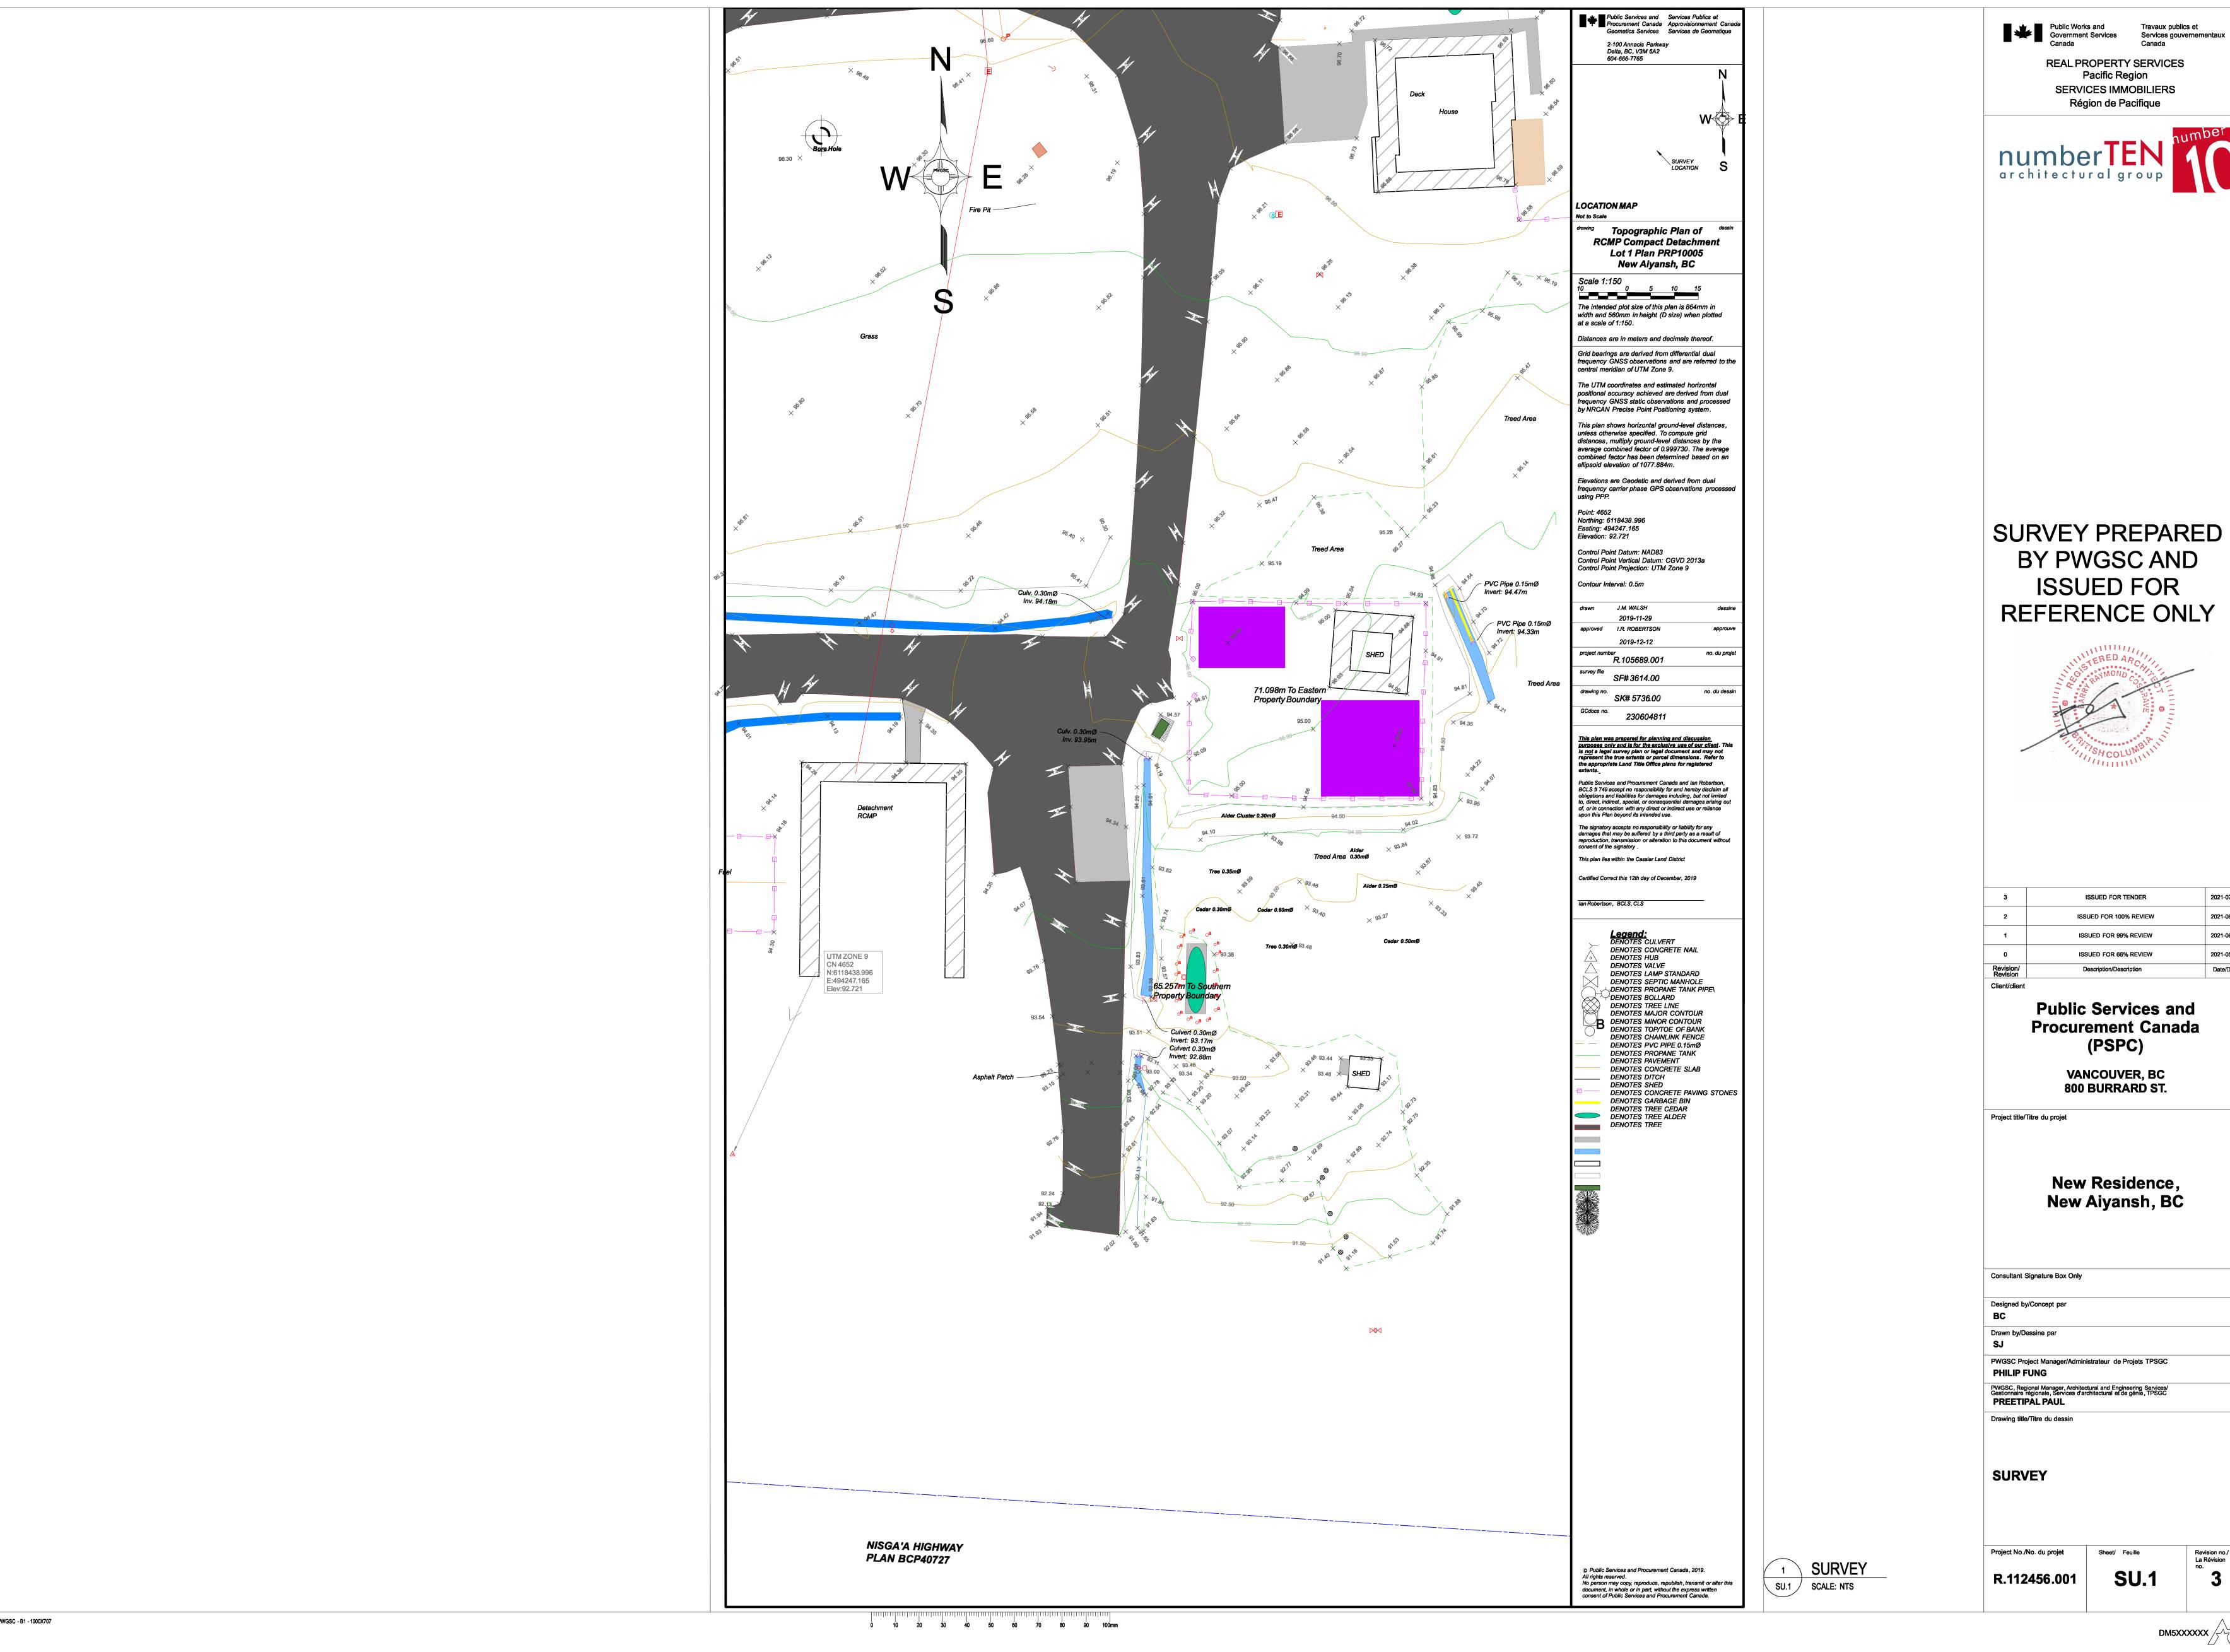



3	ISSUED FOR TENDER	2021-07-12
2	ISSUED FOR 100% REVIEW	2021-06-25
1	ISSUED FOR 99% REVIEW	2021-06-01
0	ISSUED FOR 66% REVIEW	2021-05-03
Revision/ Revision	Description/Description	Date/Date
Client/client		