MATSQUI LIVING UNIT 5 UNDERSLAB SUPPLY VENTING

MECHANICAL DEMOLITION AND RENOVATION SCOPE PACKAGE

MECHANICAL LEGEND		MECHANICAL LEGEND		
*	EX. DUCTWORK		PUMP	
<u>x</u>	DUCTWORK	<u> </u>	PRESSURE REDUCING VALVE	
	EX. FLEXIBLE DUCTWORK	_	PRESSURE GAUGE	
	FLEXIBLE DUCTWORK	<u> </u>		
M	SUPPLY DUCT RISER/SECTION		THERMOMETER	
	RETURN/EXHAUST DUCT RISER/SECTION	₩	GLOBE VALVE	
	OUTDOOR AIR DUCT RISER/SECTION	₽	ANGLE GLOBE VALVE	
***********	DUCTWORK C/W 50mm THERMAL INSULATION	₹	STRAINER	
5	DUCTWORK C/W 25mm ACOUSTIC	₩.	GATE VALVE	
<u>*************************************</u>	INSULATION 2511111 ACCOSTIC	P8	PRESSURE SWITCH	
<u>x</u>	DUCTWORK C/W 50mm ACOUSTIC INSULATION	⊣ —	UNION	
<u>X</u>	FLEXIBLE DUCT CONNECTOR	ı⊈ı	CALIBRATED BALANCE VALVE	
	ROUND DUCT RISER	₹	CHECK VALVE	
	ROUND DUCT DROP	101	BALANCING VALVE	
_	VOLUME DAMPED		PIPE CAP	
Z 	VOLUME DAMPER	৵	2-WAY CONTROL VALVE (2 POSITION)	
	FIRE DAMPER IN VERTICAL SEPERATION	*	3-WAY CONTROL VALVE (2 POSITION)	
•	FIRE DAMPER IN HORIZONTAL		EX. HOT WATER SUPPLY	
X 	SEPERATION		HOT WATER SUPPLY	
M	MOTORIZED DAMPER (2 POSITION - OPEN/CLOSE)		EX. HOT WATER RETURN	
	MOTORIZED DAMPER (MODULATING)		HOT WATER RETURN	
MM	motorized brim er (modobrimo)	XXXX	EQUIPMENT TAG	
<u>s</u>	MANUAL WALL SWITCH	(4)	POINT OF DISCONNECTION	
(€) _{ZONE}	MOTION DETECTOR	•	POINT OF CONNECTION	
⊚	CARBON DIOXIDE SENSOR	NO.@	AIR DISTRIBUTION TAG	
① _{ZONE}	THERMOSTAT	TYPE L/S SIZE		
(P)	DIFFERENTIAL PRESSURE SENSOR	<u> </u>	PIPE RISER	
		G—	PIPE DROP	


ABB	REVIATIONS		
LIST OF GENERAL ABBERVIATIONS			
ABBREVIATION DESCRIPTION			
AFF	ABOVE FINISHED FLOOR		
C/W	COMPLETE WITH		
RWL	RAIN WATER LEADER		
T/A, T/A	FROM ABOVE, TO ABOVE		
F/B, T/B	FROM BELOW, TO BELOW		
NTS	NOT TO SCALE		
0/A	OUTSIDE AIR		
R/A	RETURN AIR		
E/A	EXHAUST AIR		
S/A	SUPPLY AIR		
T.O.D.	TOP OF DUCT		
Т.О.Р	TOP OF PIPE		
U.O.D.	UNDERSIDE OF DUCT		
J.O.P.	UNDERSIDE OF PIPE		
u/s	UNDERSIDE		
DN	DOWN		
FRR	FIRE RESISTANCE RATING		
U.N.O.	UNLESS OTHERWISE NOTED		
CTE	CONNECT TO EXISTING		

MECHANICAL DRAWING LIST			
M100	COVER PAGE		
M101	MECHANICAL - FIRST AND SECOND FLOOR PLANS - DEMO		
M102	MECHANICAL - PHOTOS		
M201	MECHANICAL - FIRST AND SECOND FLOOR PLANS - RENO		
M202	MECHANICAL - ROOF PLAN - RENO		
M203	MECHANICAL - BASEMENT PLAN - DEMO & RENO		
M204	MECHANICAL - SECTIONS		
M205	MECHANICAL - SCHEMATIC		
M206	PLUMBING - RAIN WATER LEADERS & SERVICE CHASES		
M207	FIRE PROTECTION — FIRST FLOOR		
M208	MECHANICAL - DETAILS		
M209	MECHANICAL - DETAILS CONTINUED		

	ARCHITECTURAL DRAWING LIST
G000	TITLE SHEET & OVERALL SITE PLAN
G101	ABBREVIATIONS, SYMBOL LEGEND, AND GENERAL NOTES
A101	SECOND FLOOR PLAN AND ROOF
A102	BASEMENT (MECH. ROOM) AND GROUND FLOOR PLAN
A501	DETAILS
A502	DETAILS
A503	DETAILS
A801	EXISTING CONDITION PHOTOGRAPHS
A802	EXISTING CONDITION PHOTOGRAPHS

	STRUCTURAL DRAWING LIST
S1	GENERAL NOTES
S2	FIRST FLOOR PLAN & DETAILS
S3	SECOND FLOOR PLAN & ROOF PLAN
S4	SECTIONS AND DETAILS

	ELECTRICAL DRAWING LIST
E100	SITE PLAN, LEGEND, DRAWING LIST AND DETAILS
E107	M2d 2ND LEVEL FLOOR PLAN - POWER/LIGHTING LAYOUT
E108	M2c MAIN LEVEL FLOOR PLAN — POWER/LIGHTING LAYOUT
E119	M2c & M2d - PANEL 'EH' SCHEDULES/SINGLE LINE DIAGRAM
E120	M2c/M2d ROOF PLAN - POWER/LIGHTING LAYOUT

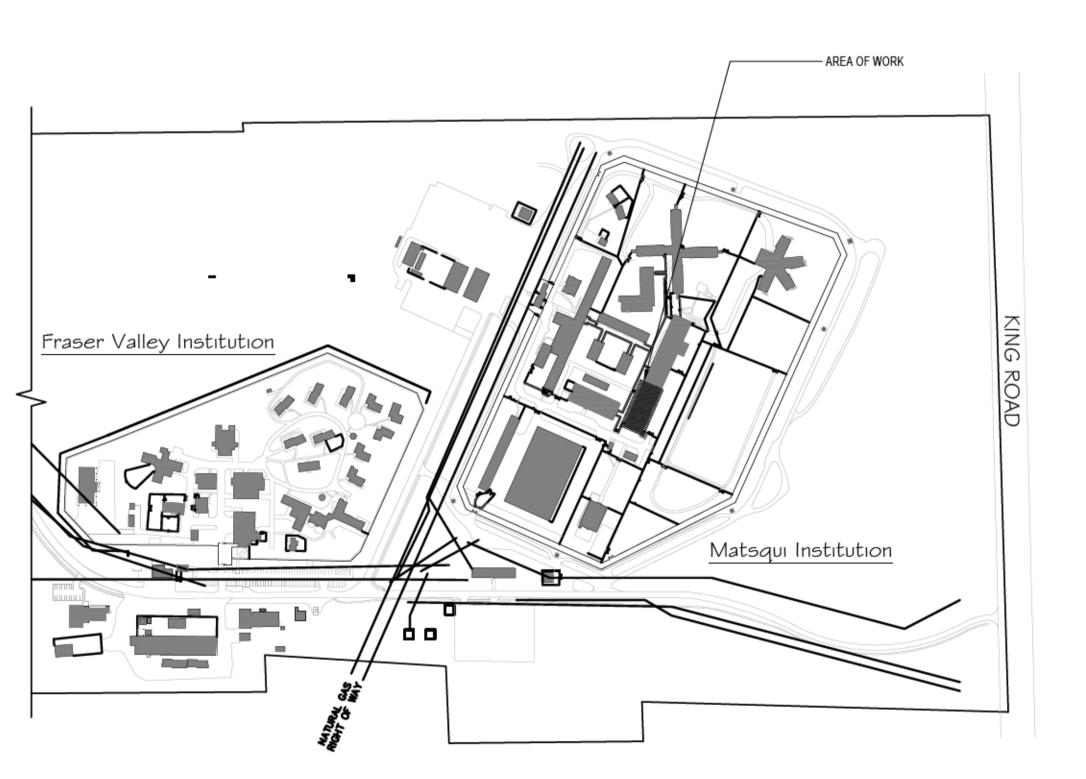





REAL PROPERTY SERVICES
Pacific Region
SERVICES IMMOBILIERS

Région de Pacifique

5	RE-ISSUED FOR TENDER	2020.12.14
4	ISSUED FOR TENDER	2020.11.18
3	ISSUED FOR 99% SUBMISSION	2020.10.02
5	ISSUED FOR 99% REVIEW	2020.09.24
1	ISSUED FOR REVIEW	2020.09.15
0	50% DF 66% SUBMISSION	2020.03.31
Revision/	Description/Description	Date/Date

CORRECTIONAL SERVICE CANADA

Project title/Titre du projet
ABBOTSFORD, BRITISH COLUMBIA
33344 KING ROAD
MATSQUI INSTITUTION BUILDING LU5

MATSQUI LIVING UNIT 5 UNDERSLAB SUPPLY VENTING


Consultant Signature Only
Designed by/Concept par Ivan Nikolic
Drawn by/Dessine par Dean Whaley
PWGSC Project Manager/Administrateur de Projets TPSGC Ken Wendt
Regional Manager, Architectural and Engineering Services Gestionnaire régionale, Services d'architectural et de génie, TPSGC Preetipal Paul

COVER PAGE

projet	•
R.111315.001	

Drawing title/Titre du dessin

5

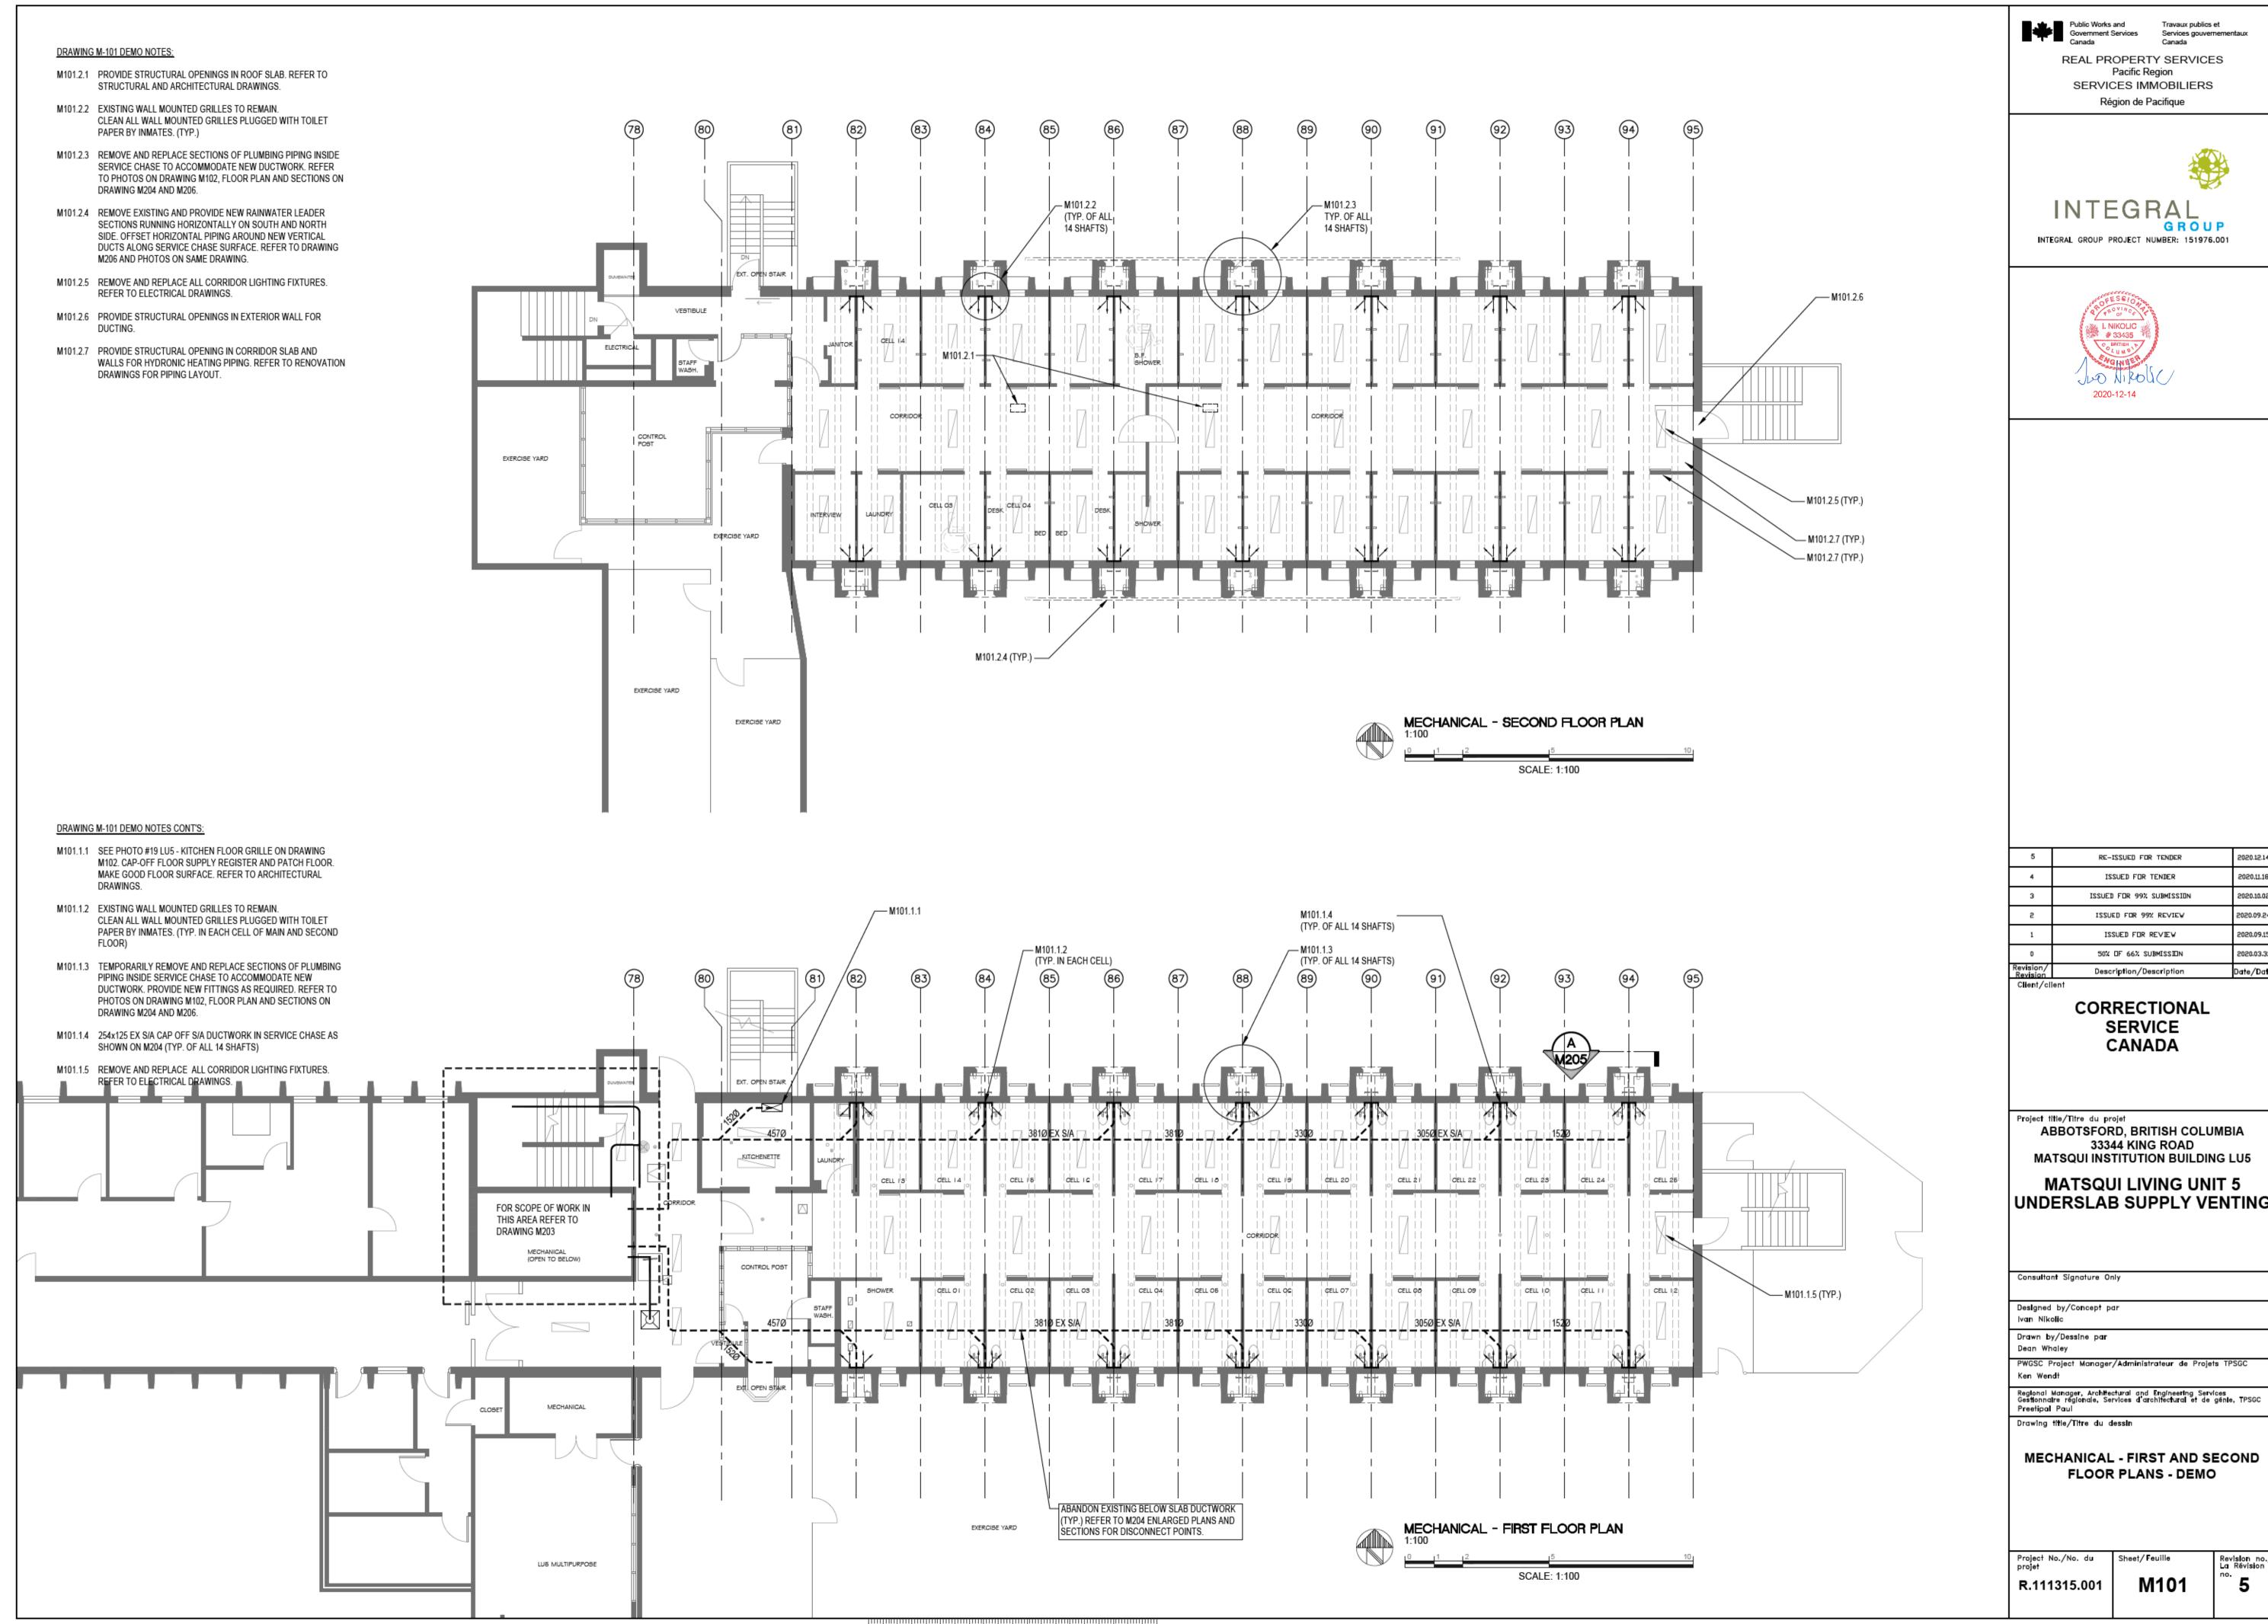

	5	RE-ISSUED FOR TENDER	2020.12.14
4 ISSU		ISSUED FOR TENDER	2020.11.18
	3	ISSUED FOR 99% SUBMISSION	2020.10.02
	S	ISSUED FOR 99% REVIEW	2020.09.24
	1	ISSUED FOR REVIEW	2020.09.15
	0	50% OF 66% SUBMISSION	2020.03.31
	Revision/	Description/Description	Date/Date

UNDERSLAB SUPPLY VENTING

Regional Manager, Architectural and Engineering Services Gestionnaire régionale, Services d'architectural et de génie, TPSGC Preetipal Paul



#1 - LU5 - NORTH VIEW



#2 - LU5 - SOUTH VIEW




#3 - LU5 - ROOF 1



#4 - LU5 - ROOF 2



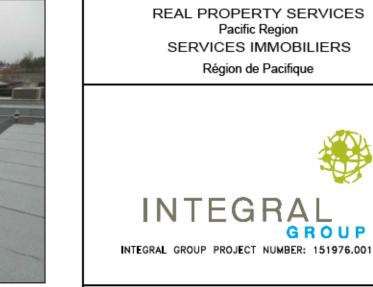

#5 - LU5 - ROOF 3



#6 LU5 - ROOF DRAIN



#7 - LU5 - SERVICE CHASE 1




#8 - LU5 - SERVICE CHASE 2




#9 - LU5 - SERVICE CHASE 3




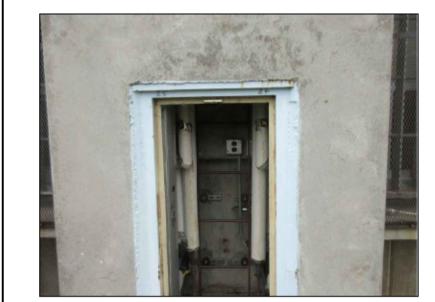


#11 - LU5 - SERVICE CHASE 5

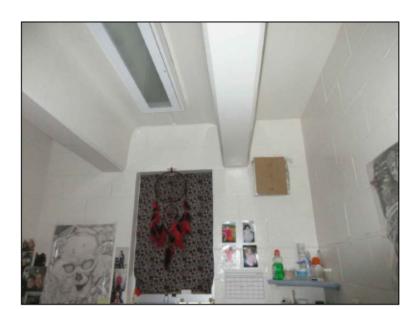

#12 - LU5 - TYPICAL CELL FIRST FLOOR

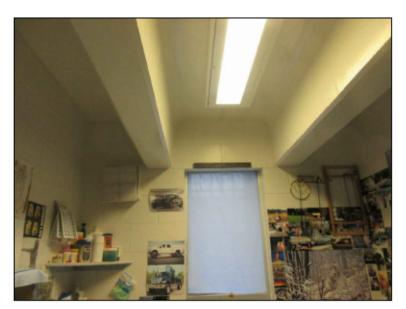

#13 - LU5 - TYPICAL CELL FIRST FLOOR 2

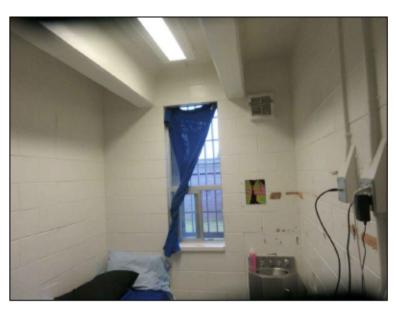


#14 - LU5 - TYPICAL CELL SECOND FLOOR




#15 - LU5 - CORRIDOR FIRST FLOOR



#20 - LU5 - KITCHEN WALL OUTSIDE

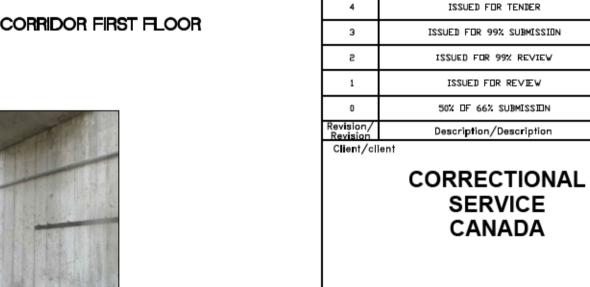

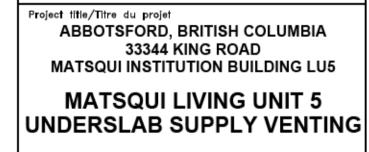

RE-ISSUED FOR TENDER





#16 - LU5 - TYPICAL CELL SECOND FLOOR 2

#21 - LU5 - KITCHEN WALL INSIDE - EXHAUST FAN LOCATION



#17 - LU5 - BASEMENT AHU

#22 - LU5 - EXAMPLE OF EXHAUST FAN ENCLOSURE



#18 - LU5 - BASEMENT EXHAUST FAN

#23 - LU5 - EXISTING AC AND EF



#19 - LU5 - KITCHEN FLOOR GRILLE

#24 - LU5 - SERVICE CHASE GROUND LEVEL





#25 - LU5 - SERVICE CHASE PLATFORM

Consultant Signature Only
Designed by/Concept par Ivan Nikolic
Drawn by/Dessine par Dean Whaley
PWGSC Project Manager/Administrateur de Projets TPSGC Ken Wendt
Regional Manager, Architectural and Engineering Services Gestionnaire régionale, Services d'architectural et de génie, TPSGC Preetipal Paul
Drawing title/Titre du dessin
PHOTOS

PI	Н	וכ	ГО	•

Project No./No. du projet	Sheet/Feuille	Revision no./ La Révision
R.111315.001	M102	ື້ 5
I	I	

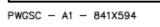

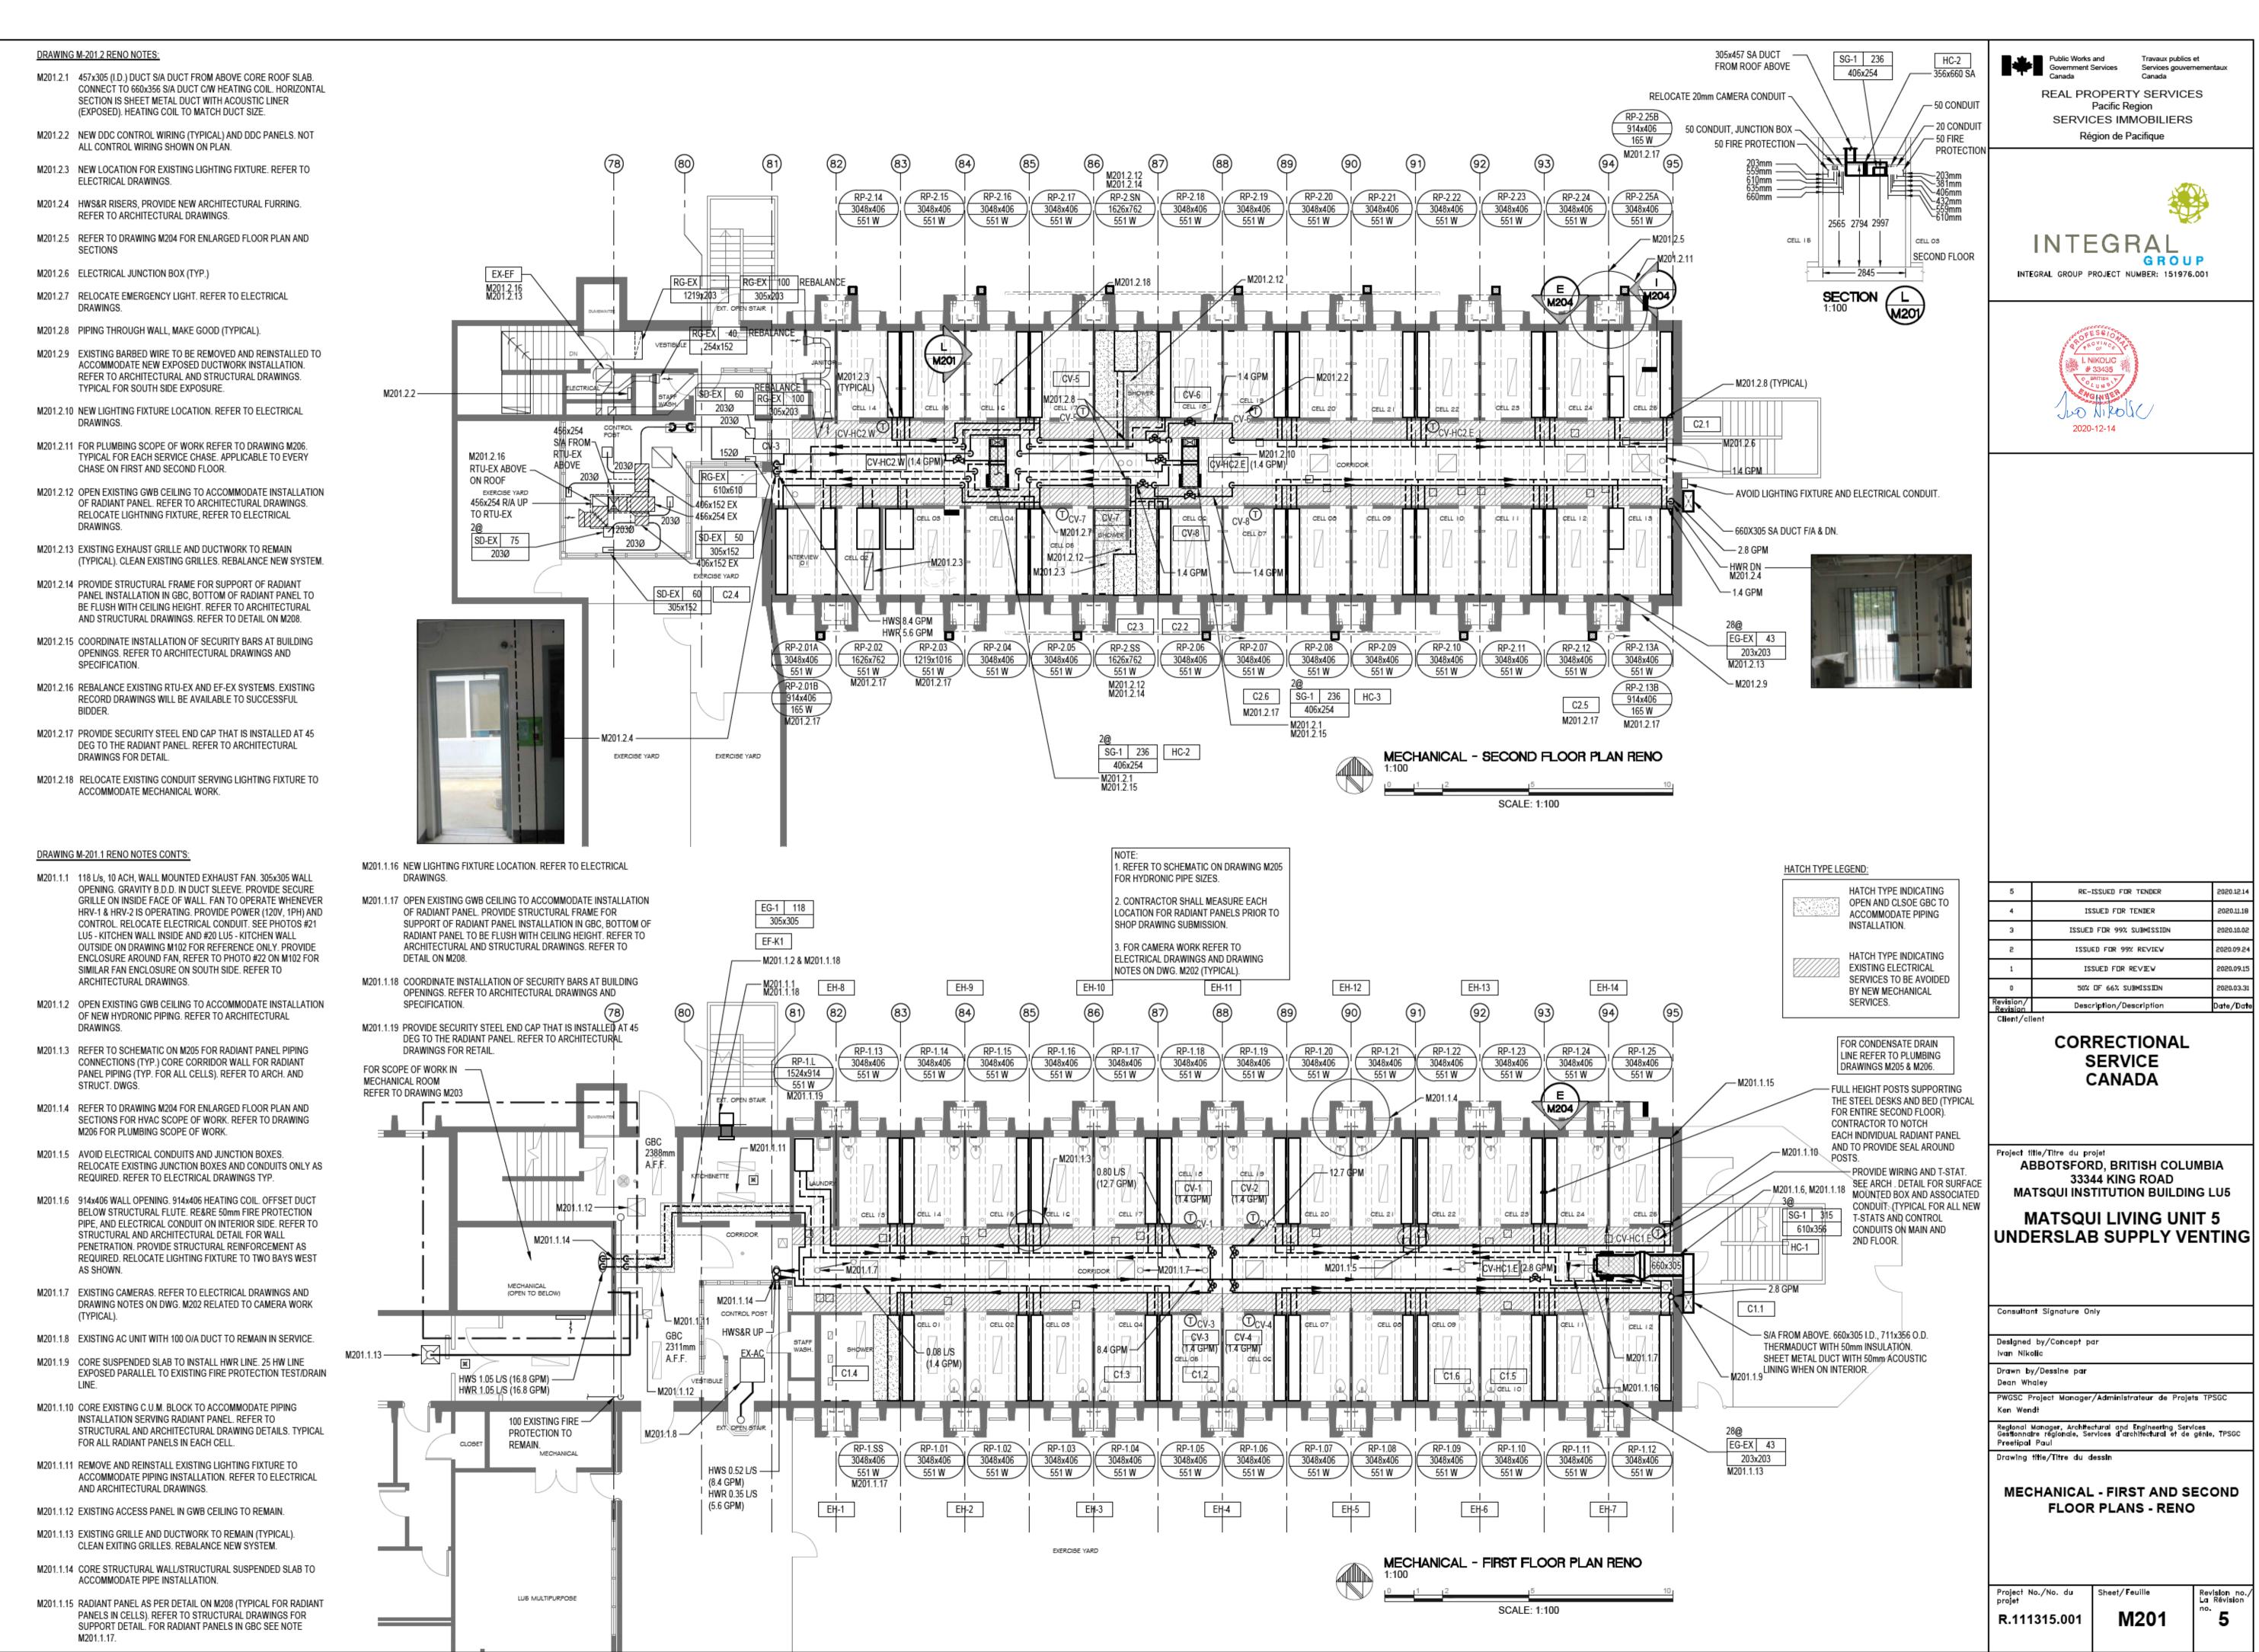

DRAWING M-202 RENO NOTES:

- M202.1 CONDUIT PENETRATION FOR POWER AND CONTROLS. PROVIDE POWER FOR HRV-1 & HRV-2 AS WELL AS SERVICE RECEPTACLE. REFER TO ELECTRICAL DRAWINGS.
- M202.2 REFER TO DRAWING M204 FOR ENLARGED FLOOR PLAN AND SECTIONS. TYP. OF 14 BRANCHES. THERMADUCT DOWN (TYPICAL).
- M202.3 RELOCATE PLUMBING VENT AS SHOWN. REFER TO M206 FOR PLUMBING VENT ROUTING ON SECOND FLOOR.
- M202.4 UNIT TO SIT ON CURB. REFER TO STRUCTURAL AND ARCHITECTURAL DWGS.
- M202.5 457x305 I.D. THERMADUCT SA DOWN C/W 25 INSULATION (ONLY ON DROPS THROUGH CURB). ROOF OPENING 508x356.

M202.6 762x762 OD ROOF CURB.

M202.7 PROVIDE DUCT SLEEPERS AS SPECIFIED (TYP).

CAMERA WORK:

- REFER TO ELECTRICAL DRAWINGS FOR DETAIL CAMERA WORK.
- THERE ARE TOTAL OF TEN (10) EXISTING CAMERAS IN AREA OF
- FOR REMAINING CAMERAS, ALL EFFORTS SHALL BE MADE TO KEEP NEW PIPING AND DUCTWORK AWAY FROM LINE OF SIGHTS
- REFER TO ELECTRICAL DRAWING FOR SCOPE OF WORK RELATED TO CAMERA WORK.
- GENERAL CONTRACTOR IS RESPONSIBLE FOR CAMERA RELOCATION / NEW CAMERAS AND COORDINATION WITH CAMERA CONTRACTOR. ALL CAMERA WORK TO BE PERFORMED BY SPECIALTY CERTIFIED CONTRACTOR AFTER MECHANICAL WORK IS COMPLETED. GENERAL CONTRACTOR AND CAMERA CONTRACTOR TO ALLOW FOR MIN. TWO (2) SITE VISITS DURING PLANNING LAYOUT FOR DUCTWORK AND PIPING. CAMERA CONTRACTOR WILL BE INVOLVED IN SAFETY MEETINGS ORGANIZED BY GENERAL CONTRACTOR.
- GENERAL CONTRACTOR SHALL INCLUDE IN HIS COST WORK RELATED TO COORDINATION AND SITE ACCESS (INCLUDING SECURITY CHECK) WITH CAMERA CONTRACTOR.
- PROTECT ALL EXISTING CAMERAS FROM DUST AND VIBRATION DURING CONSTRUCTION.
- REMOVE 20MM ELECTRICAL CONDUITS AND CAMERA CABLES TO MORE ACCESSIBLE LOCATION TO ALLOW MORE CLEARANCE FOR MECHANICAL EQUIPMENT, PIPING AND DUCTWORK ON FIRST AND SECOND FLOOR. PROVIDE NEW CONDUITS AT OTHER LOCATIONS AND CABLES WITH CONNECTION TO ALL CAMERAS. THIS IS TYPICAL FOR CONDUITS ON FIRST AND SECOND FLOOR BETWEEN GL 80 AND 95.
- UPON COMPLETION OF PROJECT, CAMERA CONTRACTOR SHALL PERFORM COMMISSIONING AND TESTING OF THE SYSTEM.

CAMERA C1.1: RELOCATE EXISTING CAMERA TO NEW LOCATION WEST FROM GL 94. PROVIDE NEW CONDUITS AND CABLES.

C.1.5 & C1.6: ADD TWO NEW CAMERAS C.1.5 AND C1.6 BETWEEN GL 91 AND 92. PROVIDE NEW CONDUITS AND CABLES CONNECTING TO THE EXISTING SYSTEM.

CAMERA C1.4: EXISTING CAMERA TO BE RELOCATED ONE BAY TO THE EAST AS

REQUIRED. PROVIDE NEW CONDUITS AND CABLES. CAMERA C2.1:

EXISTING CAMERA TO REMAIN.

EXISTING CAMERAS TO REMAIN.

CAMERA C2.2 & C2.3: EXISTING CAMERAS TO REMAIN.

CAMERA C1.2 & C1.3:


CAMERA C2.4: EXISTING CAMERA TO BE RELOCATED ABOVE THE DOOR. REMOVE JUNCTION BOX AND EXTEND CONDUITS TO

ACCOMMODATE NEW MECHANICAL PIPING.

CAMERA C2.5:

EXISTING EXTERIOR CAMERA TO BE RELOCATED TO THE RIGHT ON THE EXTERIOR SERVICE CHASE C/W SUPPORT BRACKET. REMOVE JUNCTION BOX AND EXTEND CONDUITS TO ACCOMMODATE NEW DUCTWORK.

EXISTING EXTERIOR CAMERA TO BE RELOCATED TO THE RIGHT ON THE EXTERIOR SERVICE CHASE C/W SUPPORT BRACKET. REMOVE JUNCTION BOX AND EXTEND CONDUITS TO ACCOMMODATE NEW DUCTWORK.

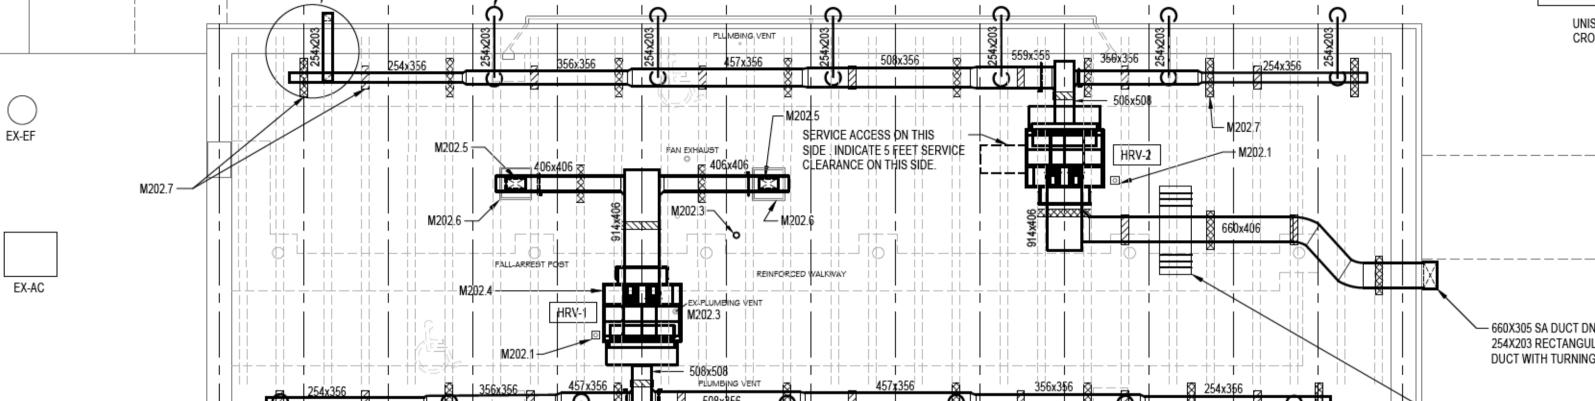

- 254X204 RECTANGULAR DUCT DROP WITH TURNING VANES.

TO SECTION I ON DWG M-204

REFER TO TWO DIMENSIONAL DUCTWORK LAYOUT AS SHOWN ON

GRIDLINE 82. TYPICAL FOR TOTAL OF 14 DUCT DROPS. REFER

--- M202.2

1. ALL EXPOSED DUCTWORK ON THE ROOF AND VERTICAL EXPOSED DUCTWORK DROPS TO BE THERMADUCT 50mm INSULATION APPROPRIATE FOR APPLICATION OUTDOORS, WITH DUCT SUPPORTS, WITH MAXIMUM SPAN ALLOWED, END COVERS, ETC. 2. ALL DUCT DIMENSIONS ARE INSIDE

DIMENSIONS.

3. ALL NEW DUCT MAINS AND ELBOWS WILL BE WITH LONG RADIUS ELBOWS OR TURNING VANES.



(MODULAR TO WORK FOR THIS CONFIGURATION ON THE ROOF). THE PLATFORM TO ACCOMODATE 1 METER LENGTH AND 800 mm HEIGHT. HEIGHT TO BE VERIFIED PRIOR ORDERING, MAINTAINING 150 mm CLEARANCE TOP OF DUCT.

660X305 SA DUCT DN.

UNISTRUT PLATFORM AND

CROSSOVER STAIR SYSTEM

MECHANICAL - ROOF FLOOR PLAN RENO

SCALE: 1:100


GRIDLINE 88 AND 94

- RUN DUCT DROP EAST SIDE AT RUN DUCT DROP EAST SIDE AT


TO PREVENT BLOCKING CAMERA. TO PREVENT BLOCKING CAMERA.

GRIDLINE 88 AND 94

HRV-1 & HRV-2 CURB:

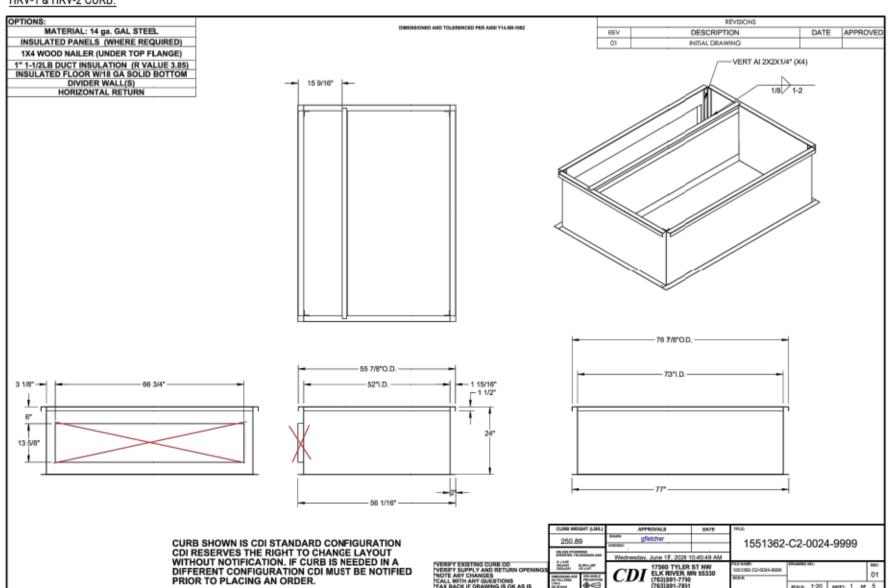



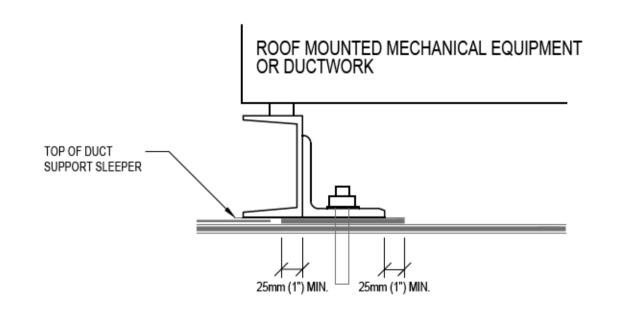

NOTE: FOR THE INSTALLATION OF SMALL MECHANICAL EQUIPMENT OR DUCTWORK ON ROOFED IN SUPPORT SLEEPER, THE CONTRACTOR IS TO CUT A SMALL "X" INTO THE EPDM MEMBRANE, SLIDING EPDM MEMBRANE OVER BOLT, APPLY BUTYL RUBBER SEALANT AROUND BOLTS, INSTALL "L" ANGLE AGAINST "C" CHANNEL OR UNISTRUT THAT IS SUPPORTING MECHANICAL EQUIPMENT OR ROOF MOUNTED DUCTWORK. IT IS CONTRACTOR'S RESPONSIBILITY TO SEISMICALLY RESTRAIN ALL EQUIPMENT AND

ROOF MOUNTED DUCTWORK ATTACHED TO ROOF

Public Works and Government Services Canada Travaux publics et Services gouvernementaux

REAL PROPERTY SERVICES Pacific Region SERVICES IMMOBILIERS Région de Pacifique





5	RE-ISSUED FOR TENDER	2020.12.14
4	ISSUED FOR TENDER	2020.11.18
3	ISSUED FOR 99% SUBMISSION	2020.10.02
2	ISSUED FOR 99% REVIEW	2020.09.24
1	ISSUED FOR REVIEW	2020.09.15
0	50% DF 66% SUBMISSION	2020.03.31
Revision/ Revision	Description/Description	Date/Date
Client/cli	ent	

CORRECTIONAL SERVICE CANADA

Project title/Titre du projet ABBOTSFORD, BRITISH COLUMBIA 33344 KING ROAD MATSQUI INSTITUTION BUILDING LU5

MATSQUI LIVING UNIT 5 UNDERSLAB SUPPLY VENTING


Consultant Signature Only Designed by/Concept par Ivan Nikolic Drawn by/Dessine par PWGSC Project Manager/Administrateur de Projets TPSGC Regional Manager, Architectural and Engineering Services Gestionnaire régionale, Services d'architectural et de génie, TPSGC Preetipal Paul Drawing title/Titre du dessin


MECHANICAL - ROOF PLAN - RENO

Revision no La Révision M202

R.111315.001

0 10 20 30 40 50 60 70 80 90 100mm PWGSC - A1 - 841X594

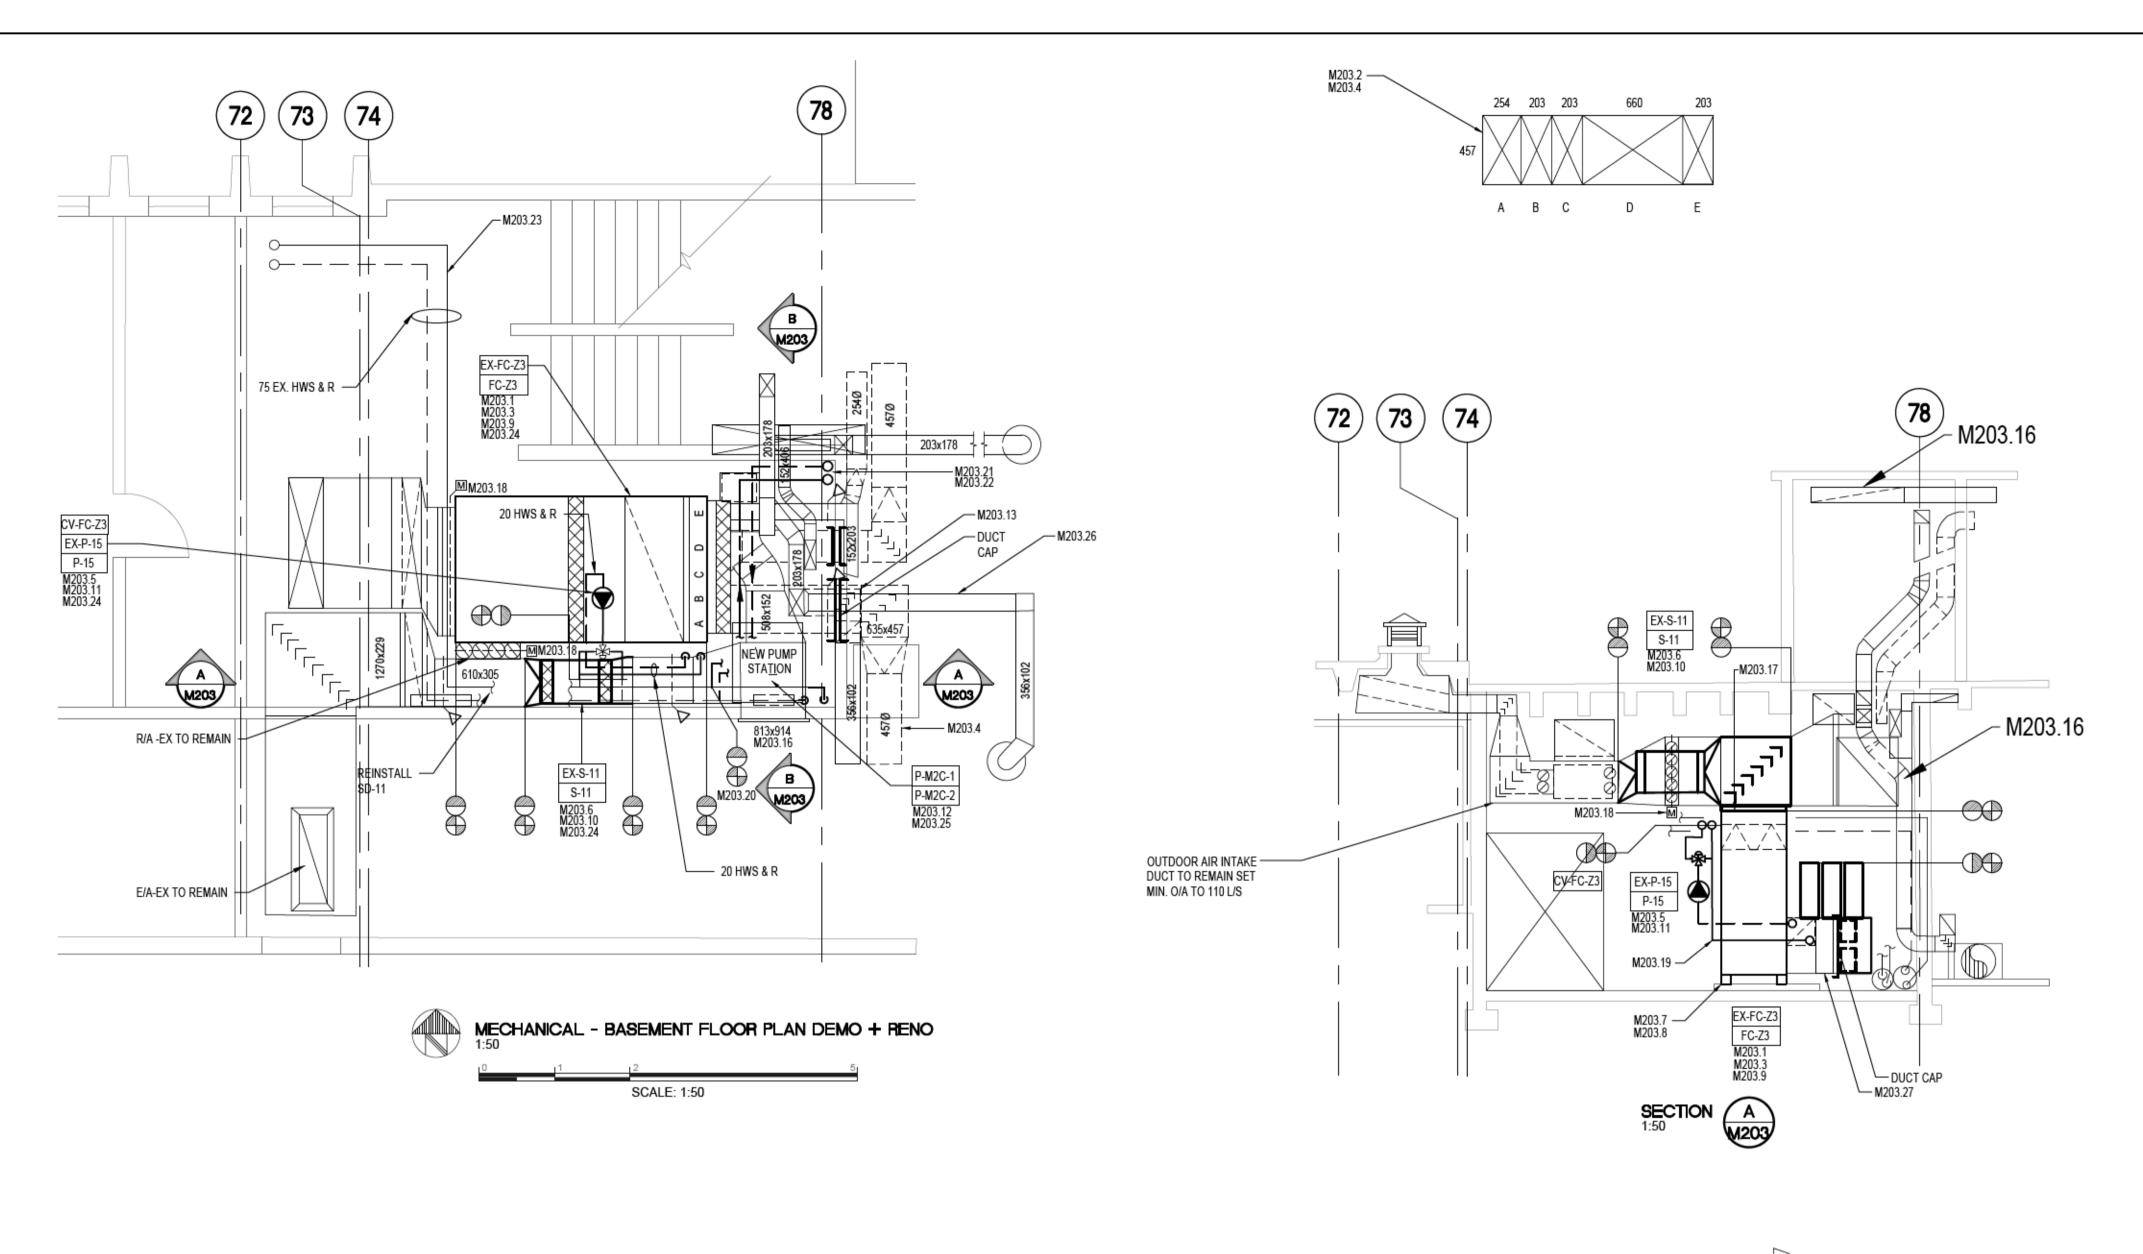

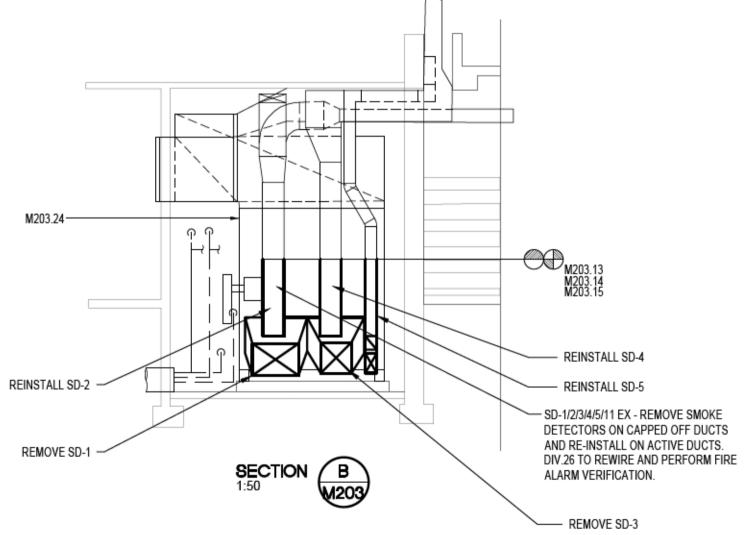

DRAWING M203 NOTES:

- M203.1 REMOVE EXISTING MULTIZONE FAN COIL UNIT FCU-Z3 AND ASSOCIATED HEATING COIL, ZONE DAMPERS, AND ELECTRONIC ACTUATORS.
- M203.2 CONTRACTOR TO HIRE BALANCING CONTRACTOR
 TO TRACE ALL EXISTING S/A AND R/A DUCTWORK
 RELATED TO FC-Z3-EX AND S-11-EX SYSTEMS.
 CONTRACTOR TO UTILIZE SMOKE TRACING FOR
 EACH DUCT ZONE INDIVIDUALLY OF THE
 MULTI-ZONE UNIT.PERFORM THIS WORK PRIOR
 TO PROCEEDING WITH DEMOLITION. PROVIDE
 SKETCH DRAWING AND SUBMIT TO THE
 DEPARTMENTAL REPRESENTATIVE. INDICATE
 DUCTWORK SCHEMATIC FOR ALL AREAS EXCEPT
 BELOW SLAB S/A DUCTWORK SERVING THE
 CELLS. [GENERAL NOTE]
- M203.3 REMOVE EXISTING FC-Z3-EX (SERVICE M2C, LOCATION: MECH. RM. 3, CONFIGURATION VERTICAL, 3 ZONE, EAT 13C, LAT 54C, HWS FLOW 1.1 L/S, EWT 93C, LWT 66C, AIR FLOW 2567 L/S, ESP 249 PA., MOTOR 7.5 HP, 208/3/60, MANUFACTURER SSM, MODEL HQ60.
- M203.4 TEMPORARILY REMOVE TOTAL OF 5 ZONE S/A DUCT SMOKE DETECTORS. REINSTALL 3 ZONE SMOKE DETECTORS (BRANCH TO SRD IN CORRIDOR 1ST FLOOR, BRANCH TO SD IN CORRIDOR ENTRY 1ST FLOOR AND BRANCH TO TWO SR'S ON 2ND FLOOR). SMOKE DETECTOR IN R/A DUCT TO REMAIN. COORDINATE MODIFICATION OF THE EXISTING FIRE ALARM PANEL WITH DIV. 26. UPDATE ZONE NUMBERING.
- M203.5 REMOVE EXISTING P-15-EX (CAPACITY 1.07 L/S, 1/6 HP, 120/1/60, ARMSTRONG S-35, S SERIES).
- M203.6 REMOVE EXISTING S-11-EX (AXIAL, 2171 L/S, 62 PA ESP, MOTOR ¼ HP, 208/3//60)
- M203.7 PROVIDE C200 CHANNEL STRUCTURAL SUPPORT FOR NEW FC-Z3.
- M203.8 PROVIDE SEISMIC ENGINEER SCHEDULE B AND SCHEDULE C-B FOR INSTALLATION OF ALL EQUIPMENT, DUCTWORK AND PIPING (TYPICAL).
- M203.9 PROVIDE NEW UNIT FC-Z3. 1420 CFM, 1.25" ESP, VFD.
- M203.10 PROVIDE NEW EXHAUST FAN S-11. 1420 CFM. (208V, 1PH, 3/4 HP)
- M203.11 PROVIDE NEW PUMP P-15 AS SPECIFIED. (120/1/60).
- M203.12 PROVIDE TWO NEW PUMPS P-M2C-1&2
 (DUTY/STAND-BY ARRANGEMENT). REFER TO
 SCHEMATIC ON M205 FOR ALL VALVES AND
 CONNECTIONS.
- M203.13 CAP-OFF EXISTING S/A DUCT BRANCH 508X457 SERVING NORTH CELLS FIRST AND SECOND FLOOR (EAST WALL IN MECH. ROOM 3). SIZE OF THE EXISTING DUCTWORK TO BE CONFIRMED.
- M203.14 CAP-OFF EXISTING S/A DUCT BRANCH 660X457 SERVING SOUTH CELLS FIRST AND SECOND FLOOR (EAST WALL IN MECH. ROOM 3). SIZE OF THE EXISTING DUCTWORK TO BE CONFIRMED.
- M203.15 MAINTAIN THE EXISTING S/A BRANCH SERVING SRD IN CORRIDOR 1ST FLOOR, BRANCH TO SRD IN CORRIDOR ENTRY 1ST FLOOR AND BRANCH TO TWO SRS ON 2ND FLOOR).
- M203.16 MAINTAIN THE EXISTING R/A BRANCH SERVING RG ON 1ST FLOOR AND RG ON 2ND FLOOR.
- M203.17 MODIFY THE EXISTING R/A TOP DUCTWORK
 CONNECTION TO NEW FC-Z3. MODIFY EXISTING
 S/A SIDE DISCHARGE S/A CONNECTION TO
 REMAINING S/A BRANCHES. PROVIDE
 ACOUSTICAL LINER AND EXTERIOR THERMAL
 INSULATION ON ALL NEW S/A AND R/A
 DUCTWORK.
- M203.18 EXISTING MOTORIZED DAMPERS TO REMAIN.
- M203.19 PROVIDE NEW HYDRONIC HEATING PIPING CONNECTION TO THE HEATING COIL AT FC-Z3. REFER TO PIPING SCHEMATIC.
- M203.20 PROVIDE POINT OF CONNECTION FOR NEW HYDRONIC HWS&R PIPING TO THE EXISTING 75MM HWS&R-EX TO SERVE RADIANT PANELS IN CELL BLOCK AND THREE (3) ZONE COILS. RUN PIPING TO PUMP STATION AND FROM PUMP STATION TO HYDRONIC HEATING DISTRIBUTION SYSTEM. PROVIDE 50mm HWS&R ISOLATION VALVES, PROVIDE 50mm BALANCING VALVE (VALVAES NOT SHOWN ON PLAN).
- M203.21 PROVIDE 50MM HWS&R PIPING SERVING NEW
- RADIANT PANELS AND ZONE COILS.

 M203.22 PROVIDE THERMAL INSULATION ON ALL NEW
- M203.23 PROVIDE THERMAL INSULATION ON ALL EXISTING HYDRONIC HEATING PIPING.

HYDRONIC HEATING PIPING.

- M203.24 MAINTAIN ALL EXISTING CONTROL POINTS
 RELATED TO THE EXISTING SYSTEMS (FC-Z3,
 S-11, P-15) AND ADD NEW AS REQUIRED. PROVIDE
 NEW WIRING AND COMMISSIONING AS REQUIRED.
- M203.25 PROVIDE NEW CONTROL POINTS FOR ALL ADDITIONAL EQUIPMENT AND SYSTEMS, RADIATION CONTROL VALVES, ZONE CONTROL VALVES, P-M2C-1&2, HRV-1&2, ETC.). EXPAND EXISTING CONTROL PANEL AS REQUIRED. ALL CONTROL WORK TO BE PERFORMED BY JOHNSON CONTROLS.
- M203.26 PERFORM COMMISSIONING AND BALANCING OF ALL MODIFIED MECHANICAL SYSTEMS AND THE EXISTING/NEW EQUIPMENT (TYPICAL).
- M203.27 S/A DUCTWORK TO BE EXTENDED TO THE EXISTING DUCT.

Public Works and Government Services Canada

Services gouvernementaux Canada

REAL PROPERTY SERVICES
Pacific Region
SERVICES IMMOBILIERS
Région de Pacifique





5	RE-ISSUED FOR TENDER	2020.12.14
4	ISSUED FOR TENDER	2020.11.18
3	ISSUED FOR 99% SUBMISSION	2020.10.02
N	ISSUED FOR 99% REVIEW	2020.09.24
1	ISSUED FOR REVIEW	2020.09.15
0	50% OF 66% SUBMISSION	2020.03.31
Revision/ Revision	Description/Description	Date/Date
Client/cli	ent	

CORRECTIONAL SERVICE CANADA

Project title/Titre du projet
ABBOTSFORD, BRITISH COLUMBIA
33344 KING ROAD
MATSQUI INSTITUTION BUILDING LU5

MATSQUI LIVING UNIT 5 UNDERSLAB SUPPLY VENTING

Consultant Signature Only
Designed by/Concept par Ivan Nikolic
Drawn by/Dessine par Dean Whaley
PWGSC Project Manager/Administrateur de Projets TPSGC Ken Wendt
Regional Manager, Architectural and Engineering Services Gestionnaire régionale, Services d'architectural et de génie, TPSGC Preetipal Paul

Drawing title/Titre du dessin

MECHANICAL - BASEMENT PLAN -DEMO & RENO

Project No./No. du projet	Sheet/Feuille	Revision no./ La Révision
R.111315.001	M203	^{no.} 5



UP TO SECOND FLOOR CORRIDOR OUTLETS -

TO 203Ø SD - FIRST FLOOR

M203.15

EX-FCU-Z3

M203.2

M203.2

REBALANCE TO 256 L/S (543 CFM)

PWGSC - A1 - 841X594

TO NORTH CELLS FIRST FLOOR

TO 406Ø SD - FIRST FLOOR

TO SOUTH CELLS FIRST AND SECOND FLOORS 1393 L/S (2953 CFM)

CAP-OFF THIS BRANCH


M203.14

CAP-OFF THIS BRANCH

1276 L/S (2705 CFM)

M203.15


REBALANCE TO 416 L/S (881 CFM)

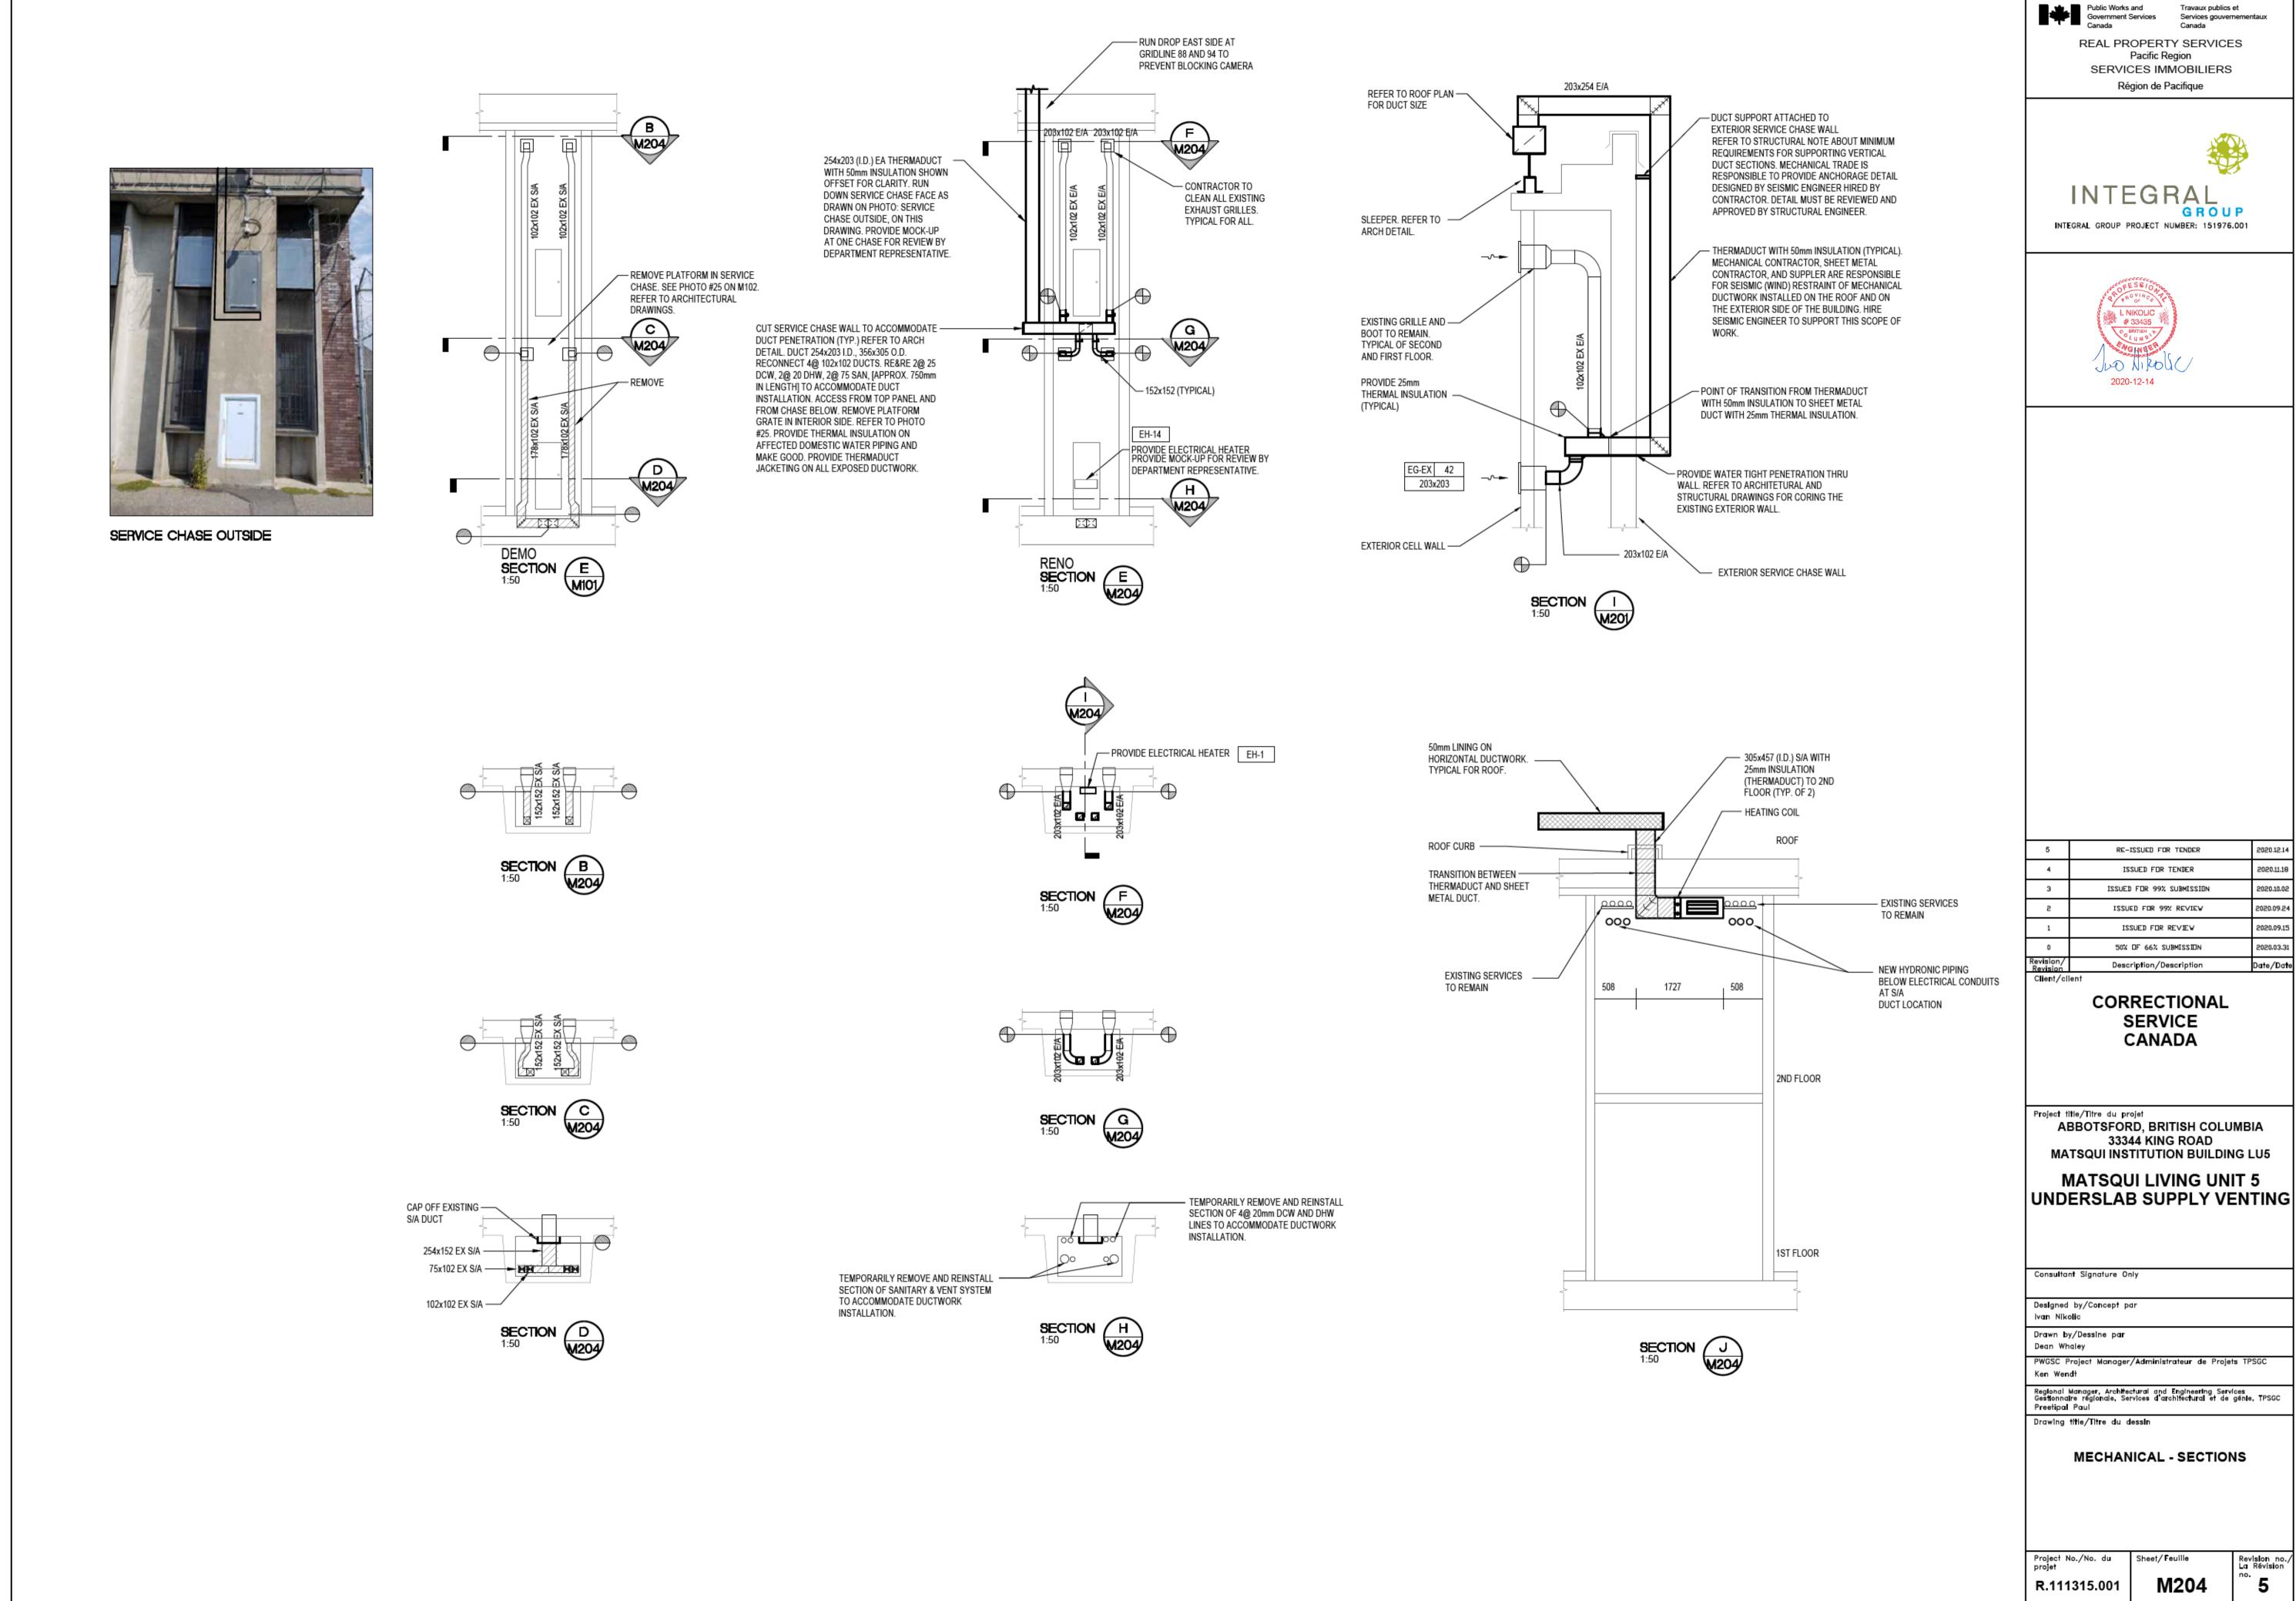

5	RE-ISSUED FOR TENDER	2020.12.14
4	ISSUED FOR TENDER	2020.11.18
3	ISSUED FOR 99% SUBMISSION	2020.10.02
n	ISSUED FOR 99% REVIEW	2020.09.24
1	ISSUED FOR REVIEW	2020.09.15
0	50% OF 66% SUBMISSION	2020.03.31
ision/ vision	Description/Description	Date/Date


Regional Manager, Architectural and Engineering Services Gestionnaire régionale, Services d'architectural et de génie, TPSGC Preetipal Paul

Revision no. La Révision

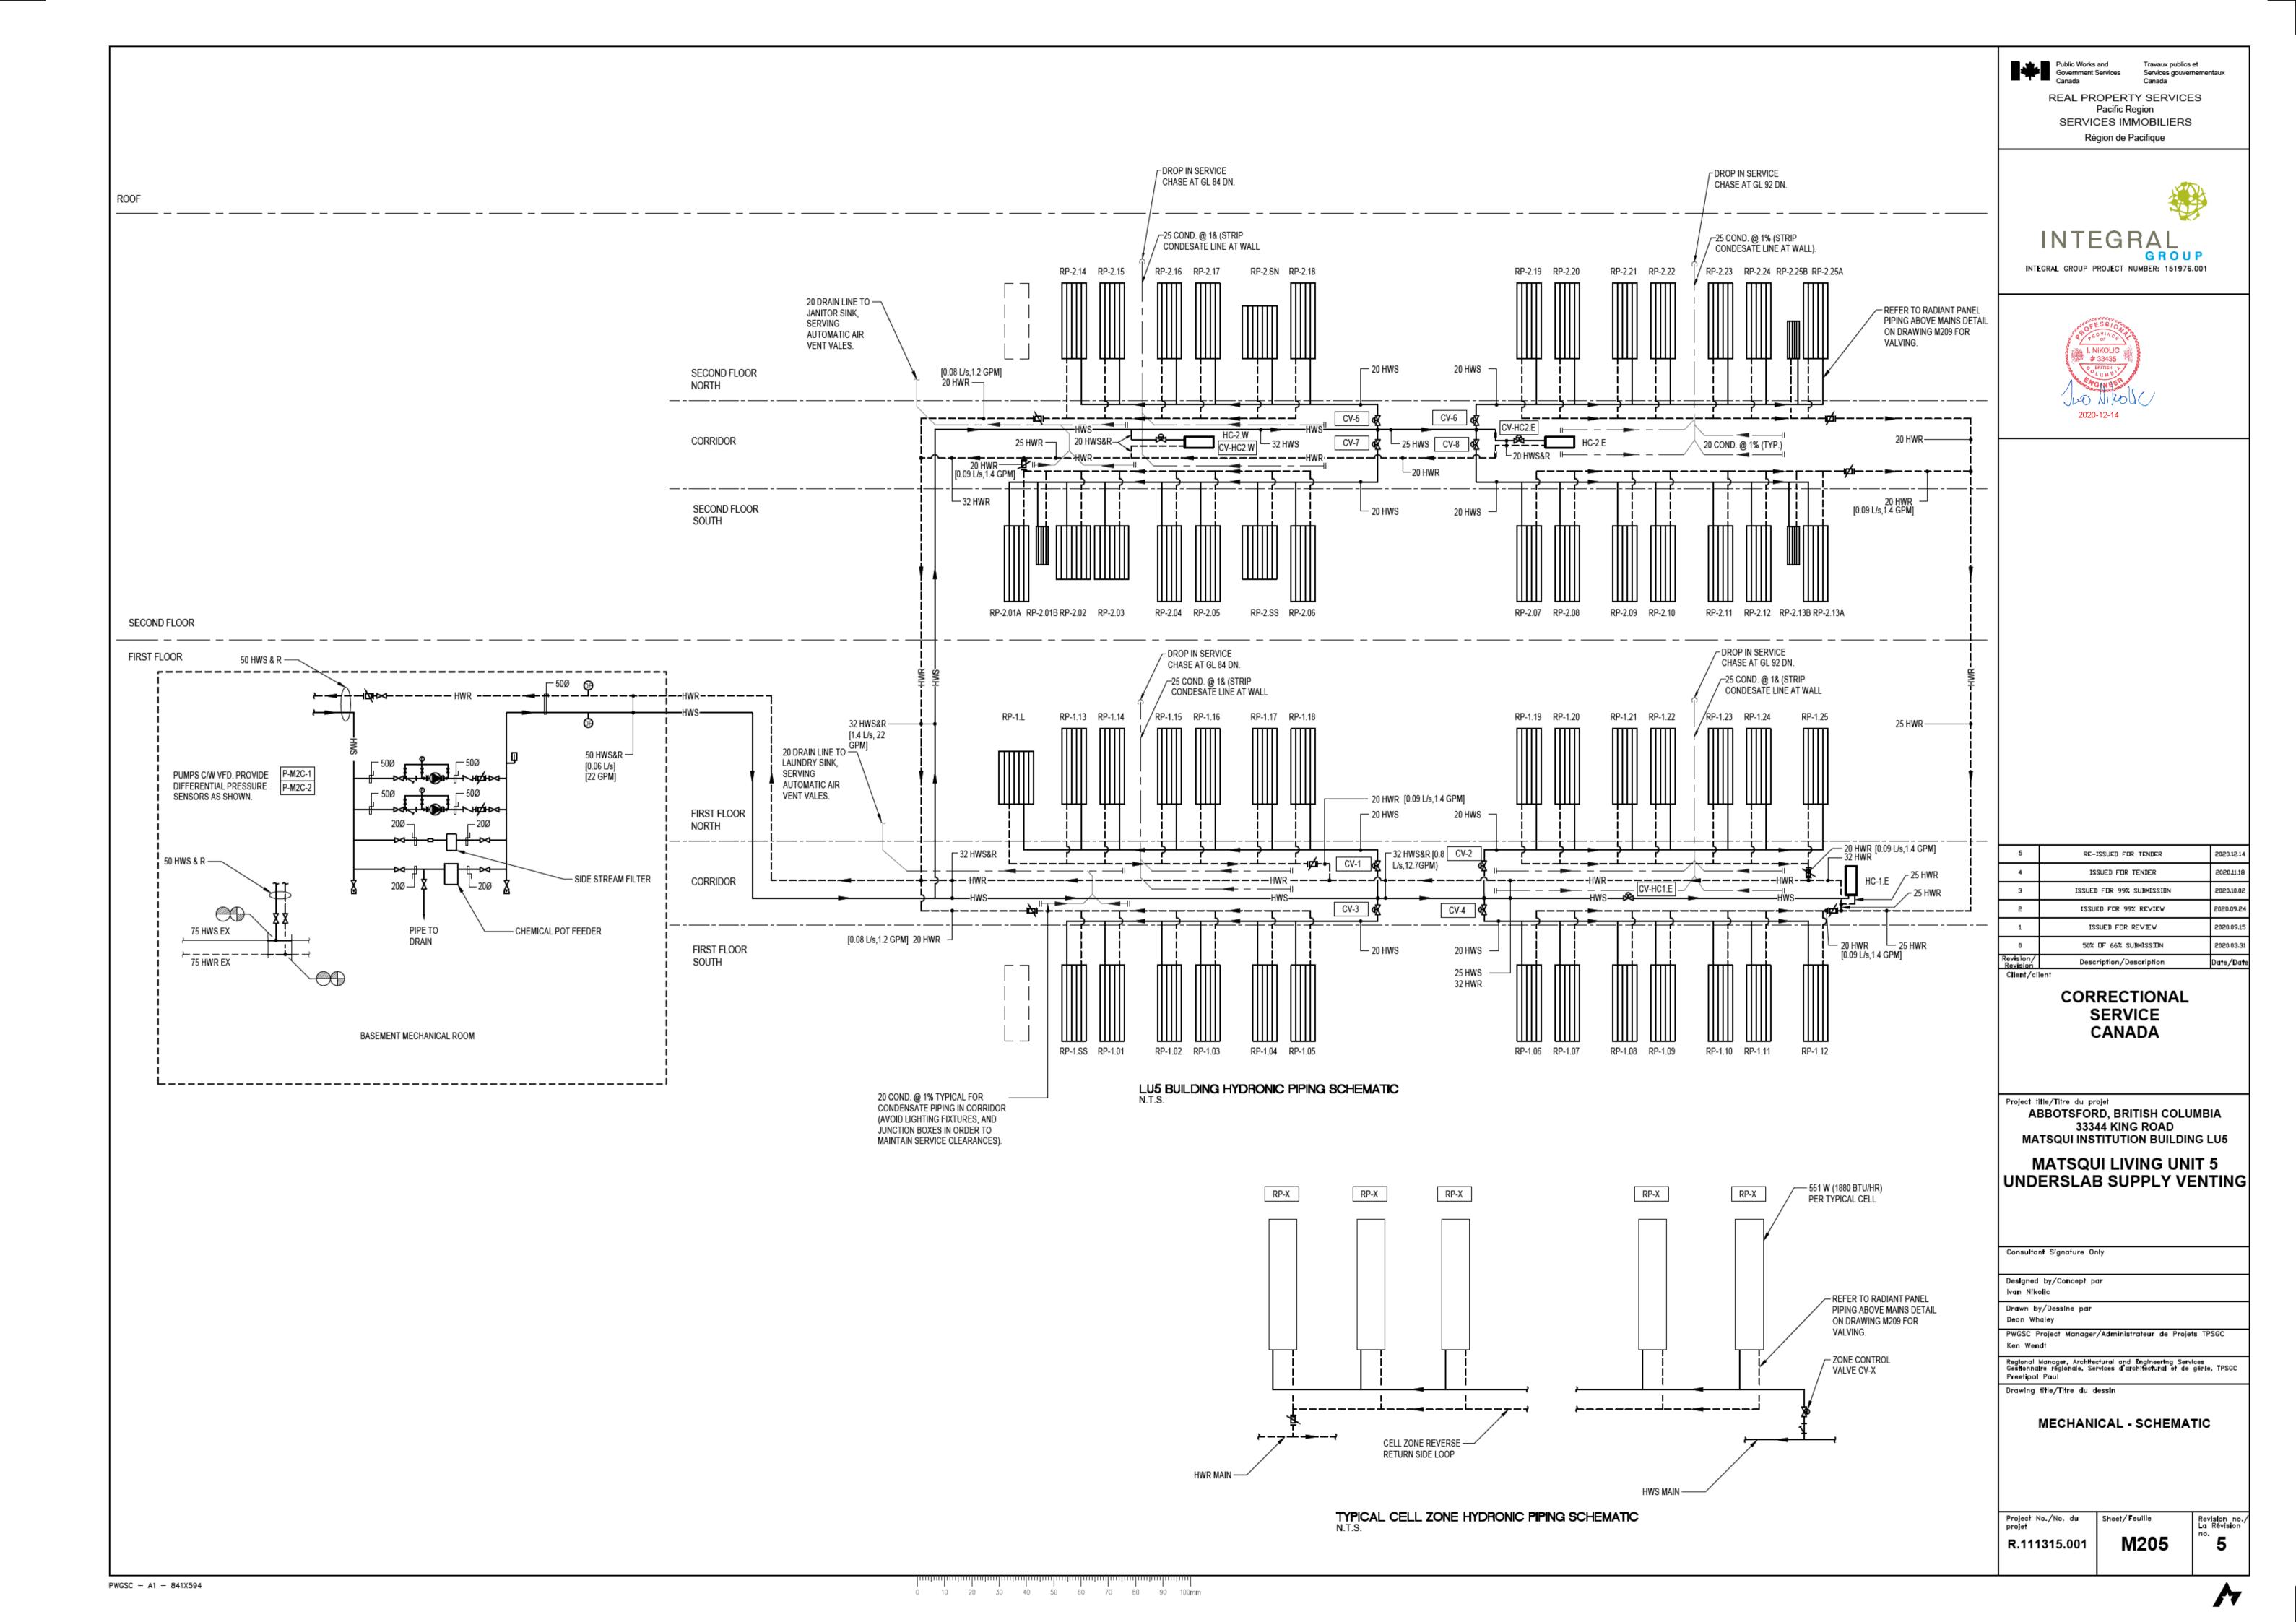




PLUMBING RAIN WATER LEADERS - NORTH

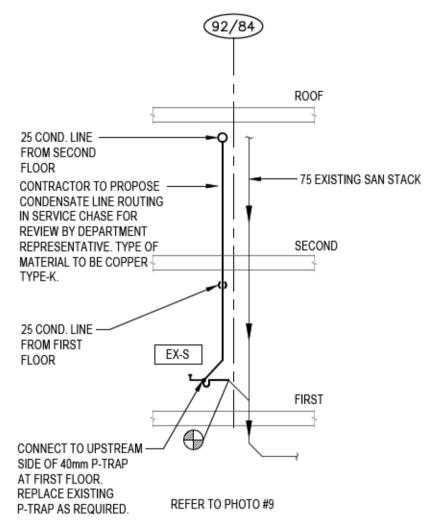

CONDENSATE DRAIN LINE CONNECTION SCHEMATIC

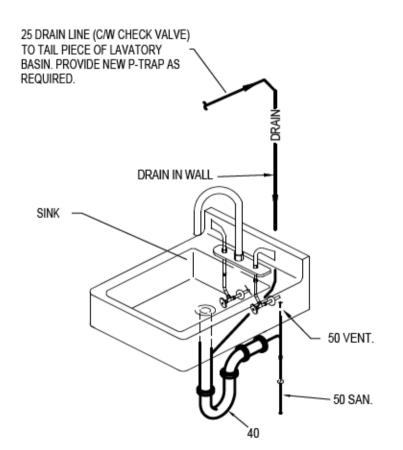


CONDENSATE DRAIN TO LAV. BASIN DETAIL





PLUMBING RAIN WATER LEADERS - SOUTH-WEST N.T.S.

PWGSC - A1 - 841X594

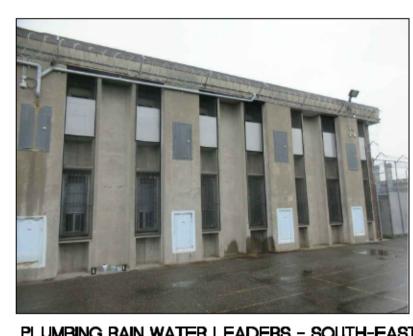

PLUMBING RAIN WATER LEADERS - SOUTH-EAST N.T.S.

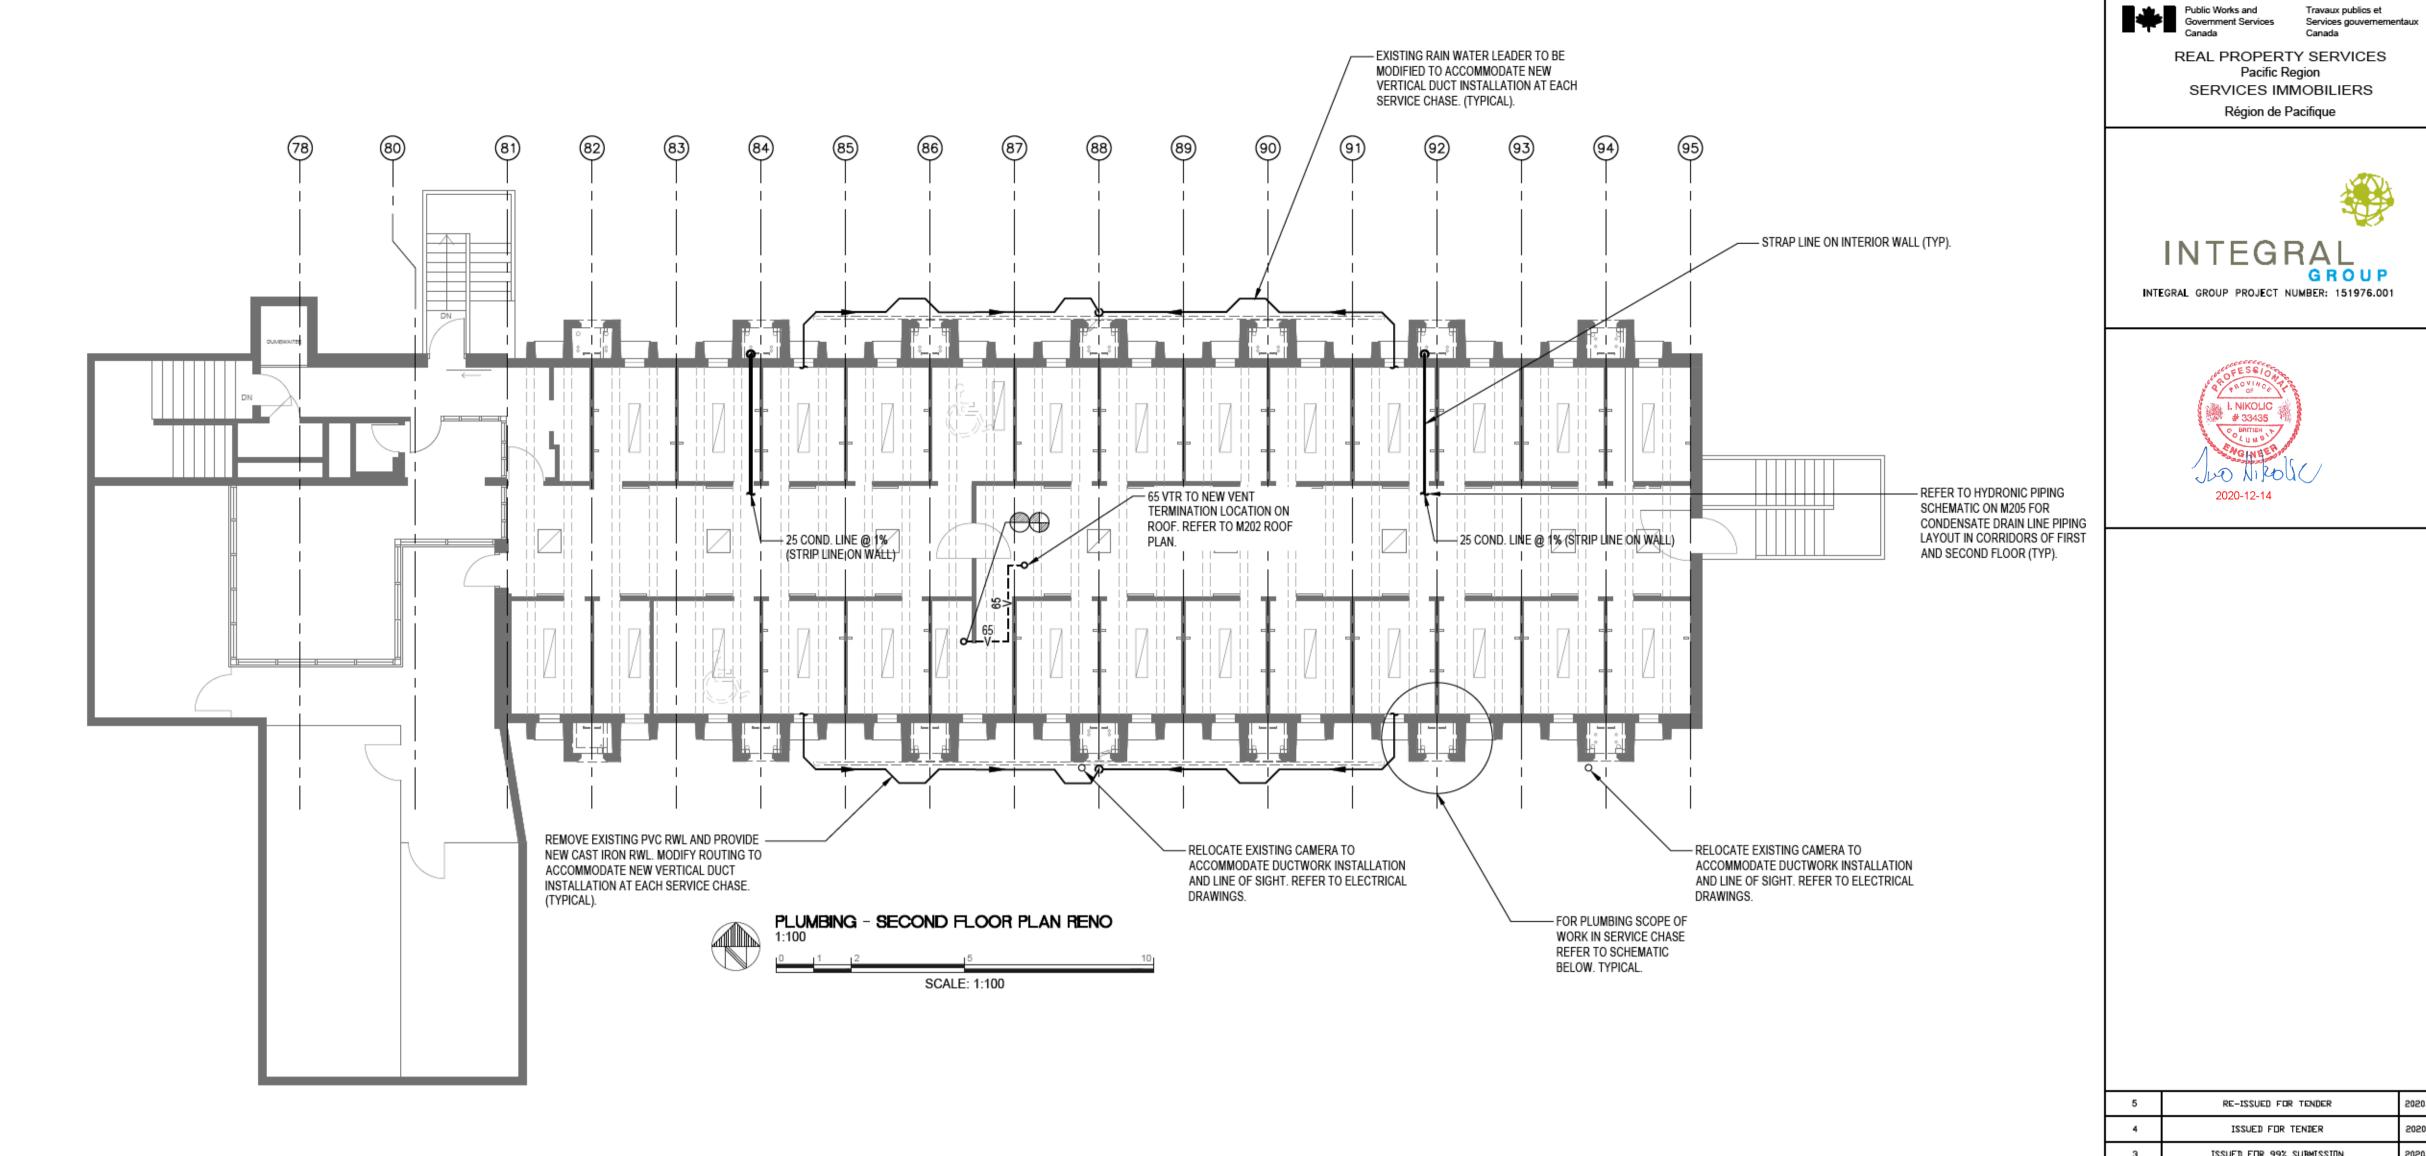

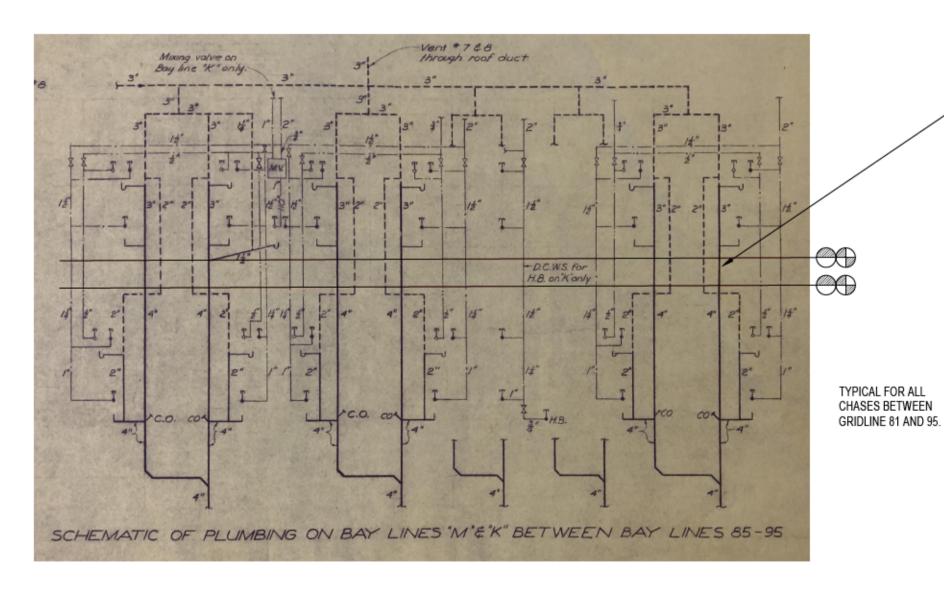

TEMPORARILY DISCONNECT EXISTING PIPING [2@ 40mm CW-EX, 12mm HW-EX, 100mm SAN, STACK-EX, 50 VENT STACK-EX] AND RECONNECT UPON COMPLETION OF DUCT MODIFICATION IN SERVICE CHASE. PROVIDE NEW FITTINGS. PROVIDE NEW THERMAL INSULATION ON DOMESTIC COLD AND HOT WATER PIPING. THIS SCOPE OF WORK IS APPLICABLE TO EACH SERVICE CHASE. FOR SERVICE CHASES BETWEEN GRID LINES 81 & 85, CONTRACTOR TO CONFIRM PIPE SIZES. RECORD PLUMBING DRAWINGS WILL BE AVAILABLE TO THE SUCCESSFUL BIDDER.

ISSUED FOR REVIEW 50% OF 66% SUBMISSION Description/Description Client/client CORRECTIONAL SERVICE

RE-ISSUED FOR TENDER

ISSUED FOR TENDER ISSUED FOR 99% SUBMISSION

ISSUED FOR 99% REVIEW

CANADA

2020.12.14

REAL PROPERTY SERVICES

Pacific Region

SERVICES IMMOBILIERS

Région de Pacifique

2020-12-14

Project title/Titre du projet ABBOTSFORD, BRITISH COLUMBIA 33344 KING ROAD MATSQUI INSTITUTION BUILDING LU5

MATSQUI LIVING UNIT 5 UNDERSLAB SUPPLY VENTING


Consultant Signature Only Ivan Nikolic Drawn by/Dessine par PWGSC Project Manager/Administrateur de Projets TPSGC

Regional Manager, Architectural and Engineering Services Gestionnaire régionale, Services d'architectural et de génie, TPSGC Preetipal Paul

Drawing title/Titre du dessin

PLUMBING - RAIN WATER LEADERS & SERVICE CHASE

Revision no., La Révision M206 R.111315.001

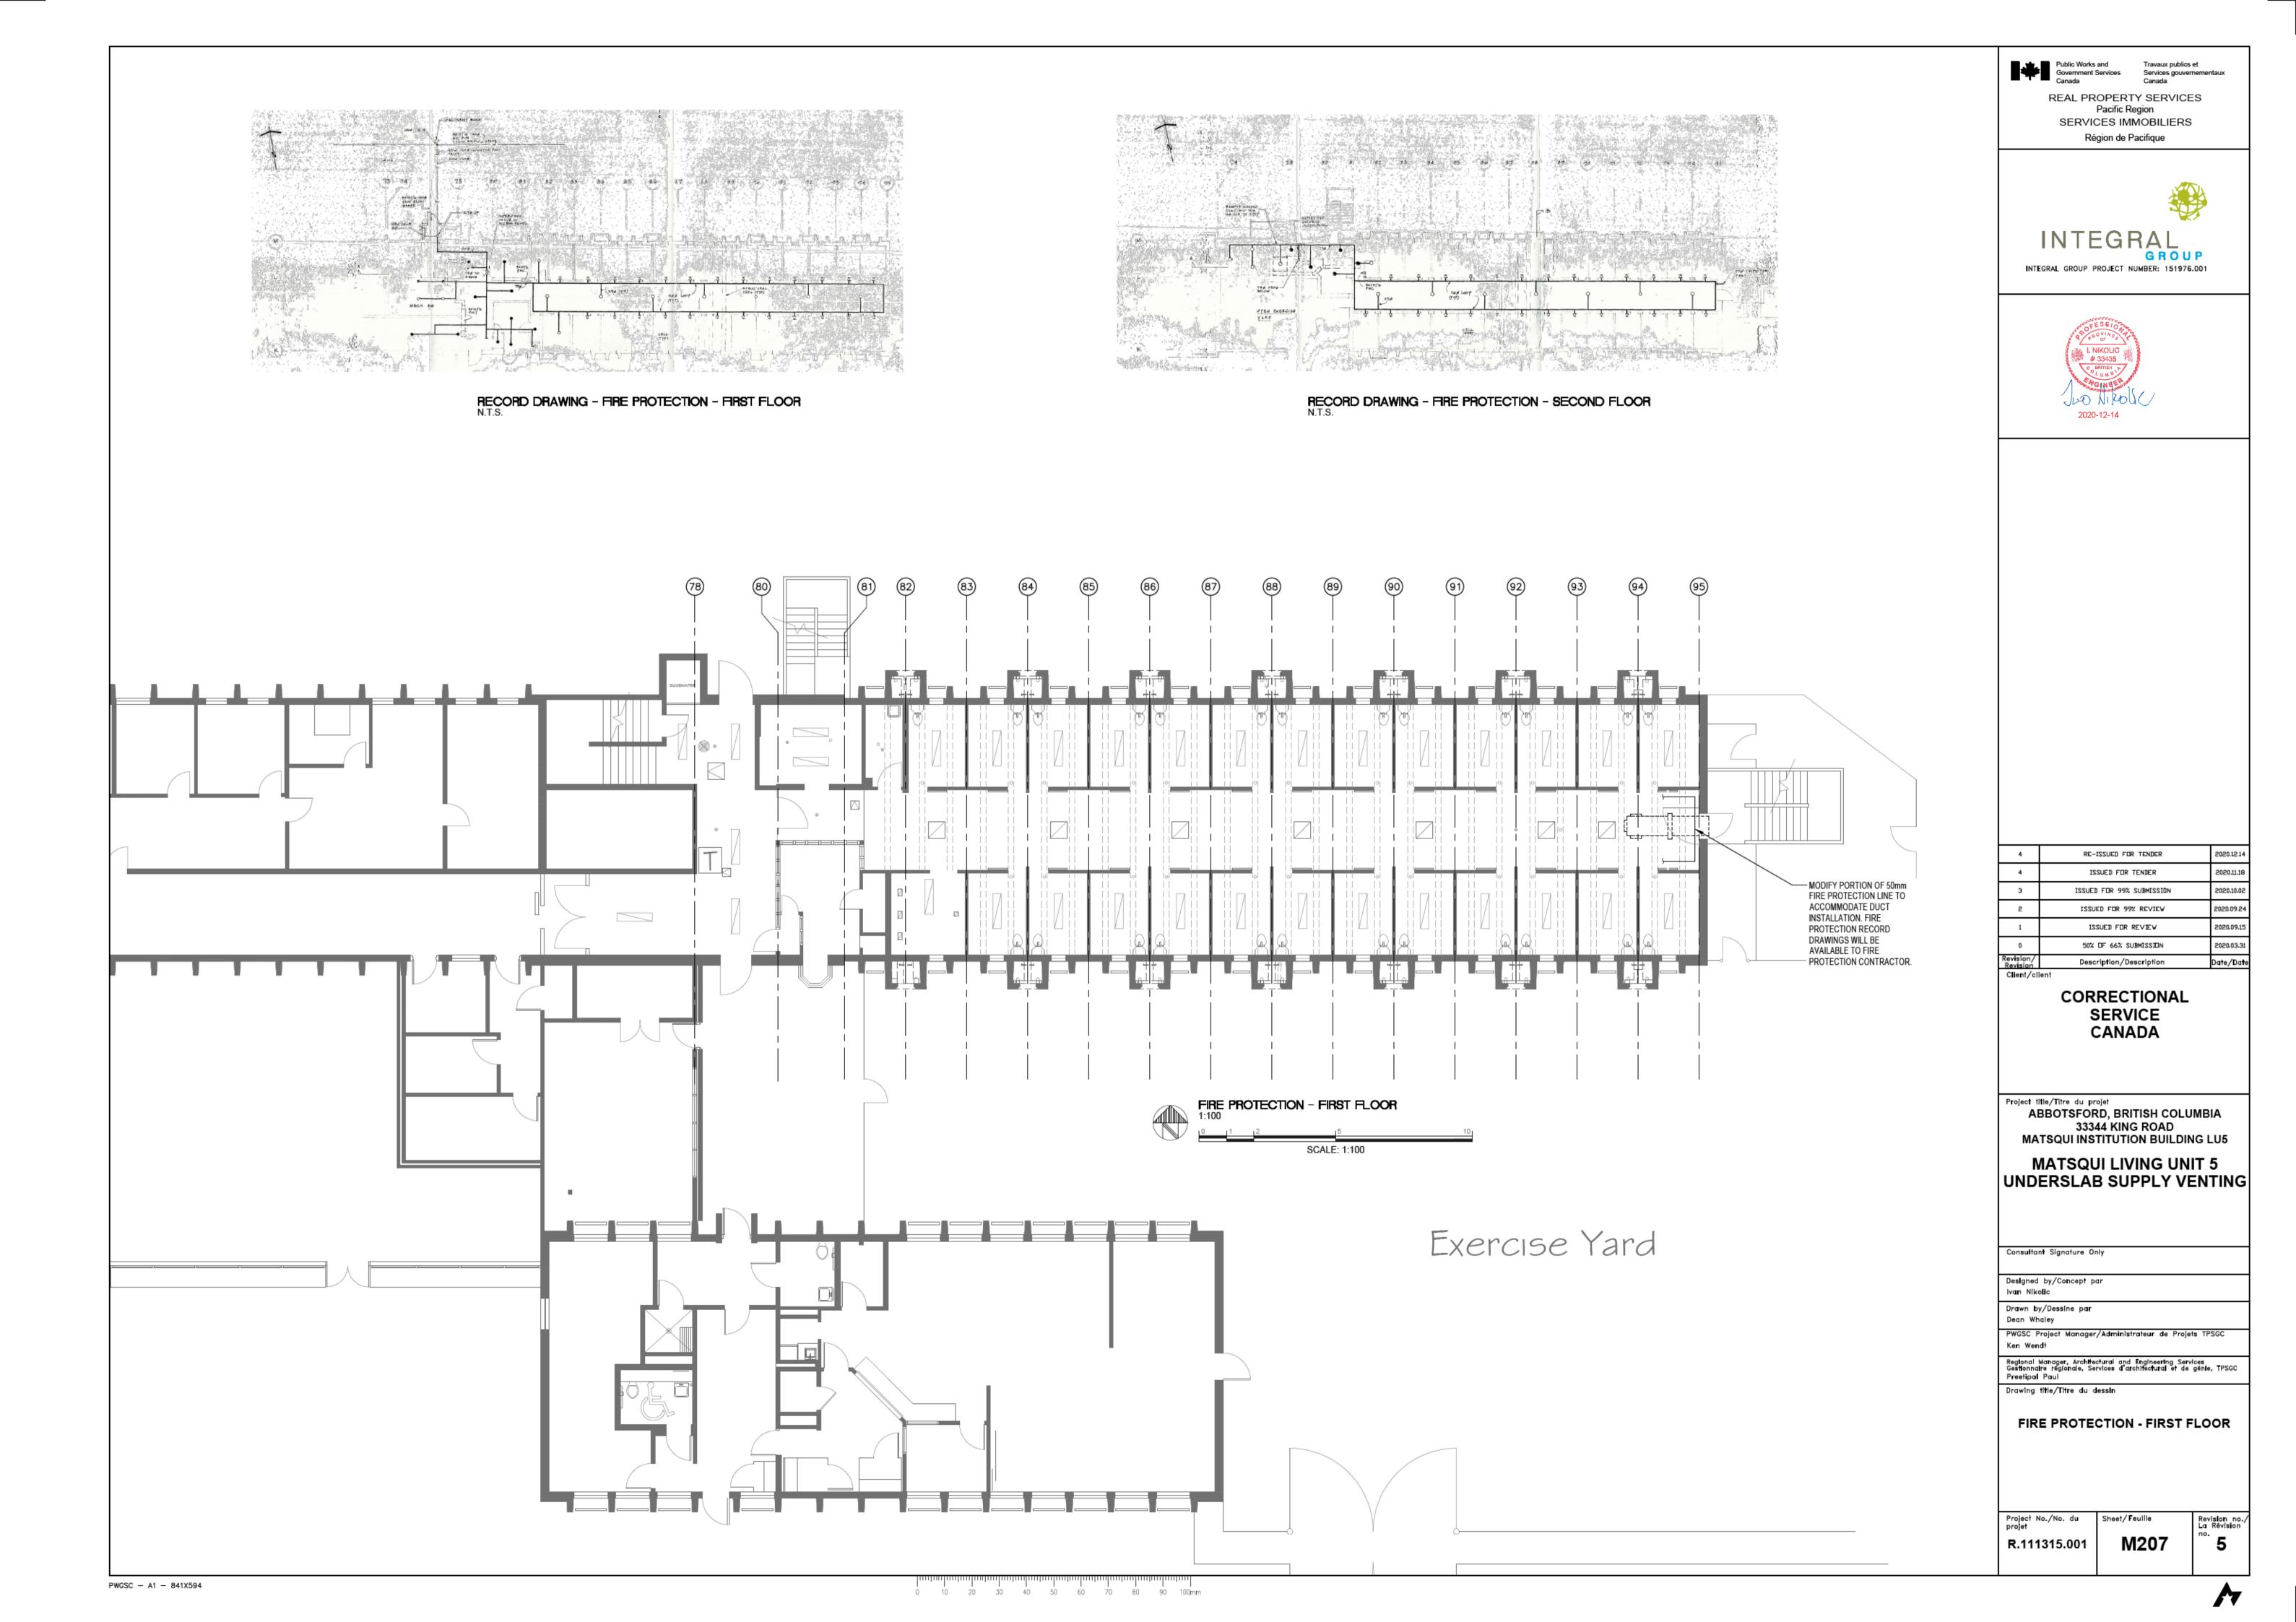


			Unit F	Performance		
Design C	onditions					
Elev	ation (ft)	Sun	nmer	Winter DR /E\	Outdoor Air	Exhaust Air
Elev	ation (ft)	DB (F)	WB (F)	Winter DB (F)	(CFM)	(CFM)
	194	84.0	68.0	11.0	2,100	2,650
Unit Spec	ifications					
Qty	Weig	nt (lb)	Uni	t Installation	Uni	t ETL Listing
1	1,101 (+/- 5%)		Outdoor		UL 1812

		01111			
1	1,101 (+/- 5%) 0	utdoor	UL 18	312
Configu	uration				
	Outdo	or Air		Exhaust Air	
	Intake	Discharge	Intake	0)ischarge
End		End	Bottom		End


Energy Recovery Performance									
Design	Temperature (F)							Capacity	
Condition	Outdo	or Air	Supp	ly Air	Retur	n Air	Exhaust Air		Reduction
Condition	DB	WB	DB	WB	DB	WB	DB	WB	(BTU/h)
Summer	84.0	68.0	77.5	64.6	75.0	62.5	80.2	65.3	25,515.0
Winter	11.0	8.6	55.2	43.6	72.0	55.8	37.2	34.8	101,081.0

Turno	Total Volume	External SP	Total SP	FRPM		Fan	
Type	(CFM)	(in. wg)	(in. wg)	FRPIN	Qty	Type	Drive-Type
Supply	2,100	1.15	1.708	2038	2	Mixed Flow	Direct
Exhaust	2,650	1.25	2.366	2425	2	Mixed Flow	Direct

Exhaust otor Specifica	2,650	1.25	2.366	2425	2	Mixed Flow	Direc
Motor	Qty	Operating Power (hp)	Size	(hp)	Enclosure	Efficiency	RPM
Supply	2	0.62		1	ODP	PE	1725
Exhaust	2	1.23		2	ODP	PE	1725

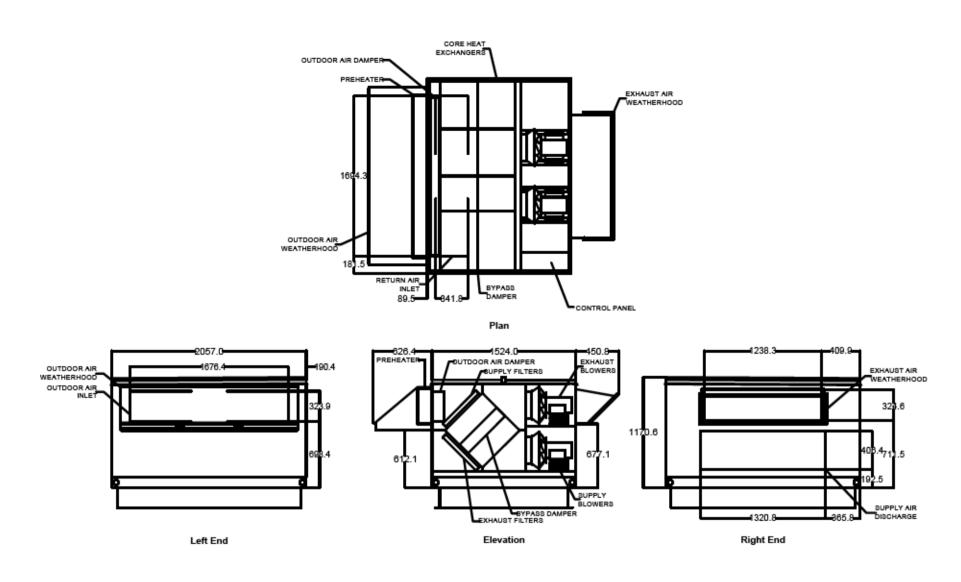

HRV-1 + HRV-2 DIMENSIONS N.T.S.

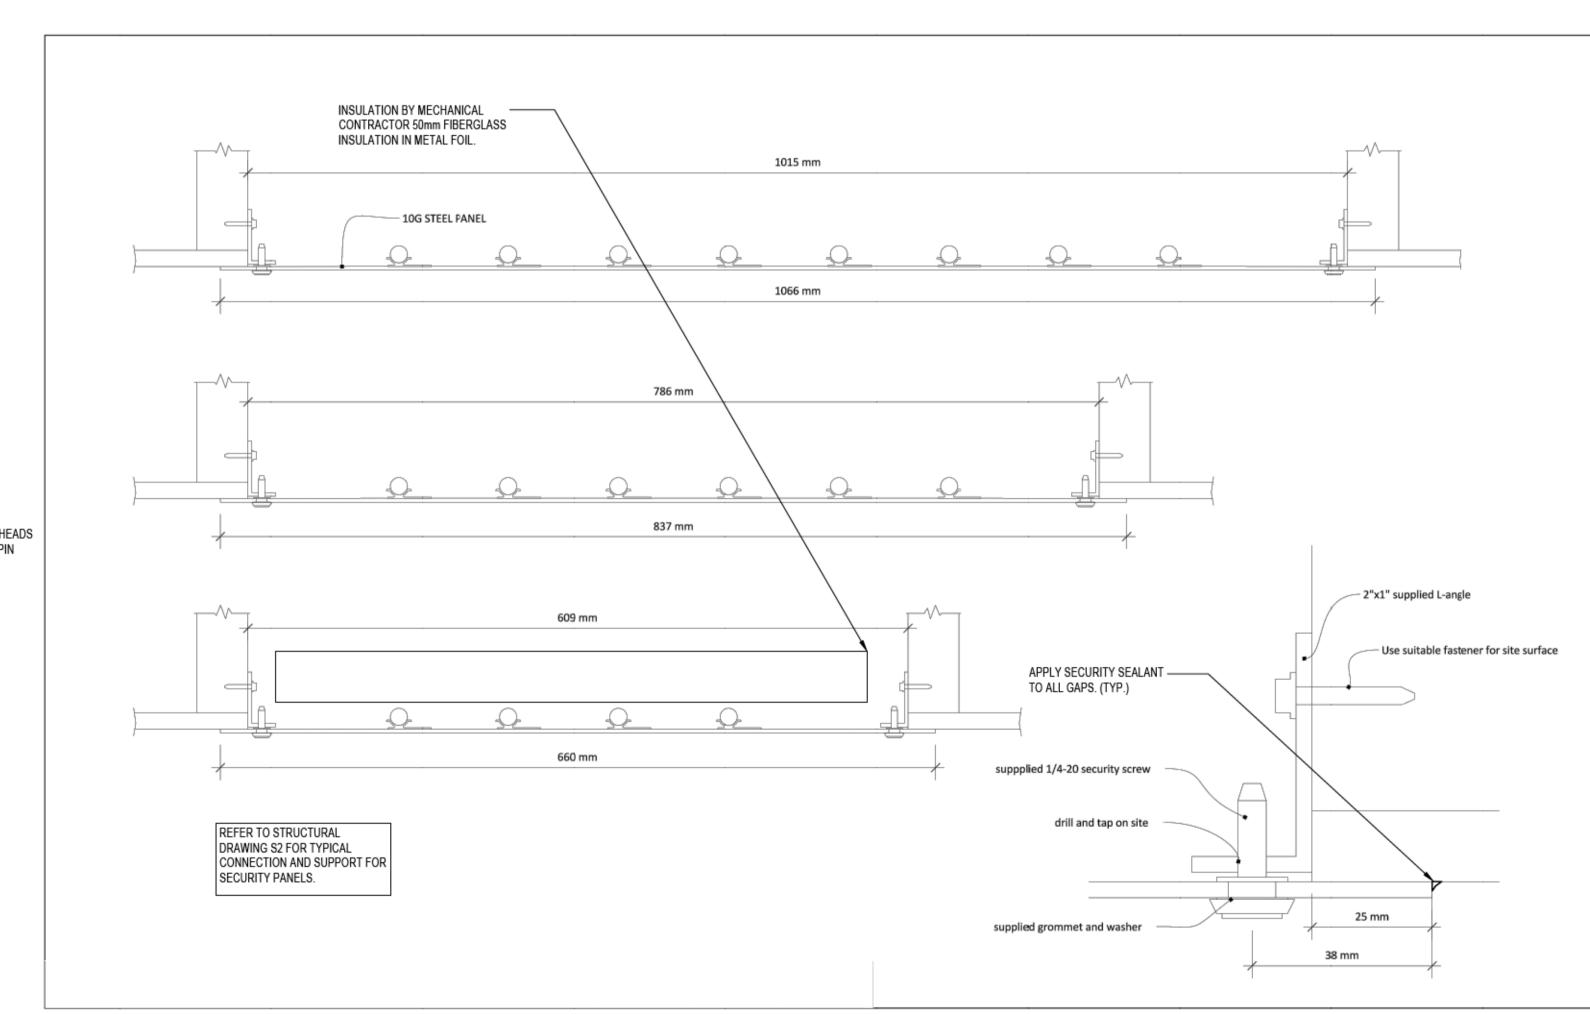

FLUSH MOUNTED SECURITY RADIANT PANEL - SUPPORT IN GYPSUM BOARD CEILING N.T.S.

Public Works and Travaux publics et Services gouvernementaux Canada Canada REAL PROPERTY SERVICES Pacific Region SERVICES IMMOBILIERS Région de Pacifique





Client/cli	ent	
Revision/ Revision	Description/Description	Date/Date
0	50% OF 66% SUBMISSION	2020.03.31
1	ISSUED FOR REVIEW	2020.09.15
N	ISSUED FOR 99% REVIEW	2020.09.24
3	ISSUED FOR 99% SUBMISSION	2020.10.02
4	ISSUED FOR TENDER	2020.11.18
5	RE-ISSUED FOR TENDER	2020.12.14

CORRECTIONAL SERVICE CANADA

Project title/Titre du projet ABBOTSFORD, BRITISH COLUMBIA 33344 KING ROAD MATSQUI INSTITUTION BUILDING LU5

MATSQUI LIVING UNIT 5 UNDERSLAB SUPPLY VENTING

- 1	Consultant Signature Only
	Designed by/Concept par Ivan Nikolic
	Drawn by/Dessine par Dean Whaley
	PWGSC Project Manager/Administrateur de Projets TPSGC Ken Wendt
	Regional Manager, Architectural and Engineering Services Gestionnaire régionale, Services d'architectural et de génie, TPSGC Preetipal Paul


Drawing title/Titre du dessin

MECHANICAL - DETAILS


Project No./No. du projet	Sheet/Feuille	Revision no. La Révision
R.111315.001	M208	ື 5

OF RADIANT PANEL


PWGSC - A1 - 841X594

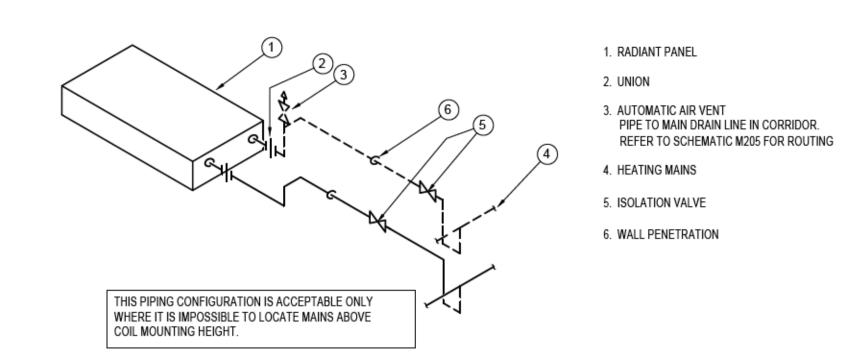


RADIANT PANEL PIPING ABOVE MAINS N.T.S.

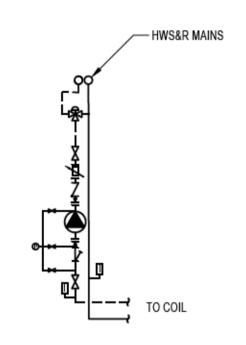


FCZ3 COIL PIPING DETAIL N.T.S.

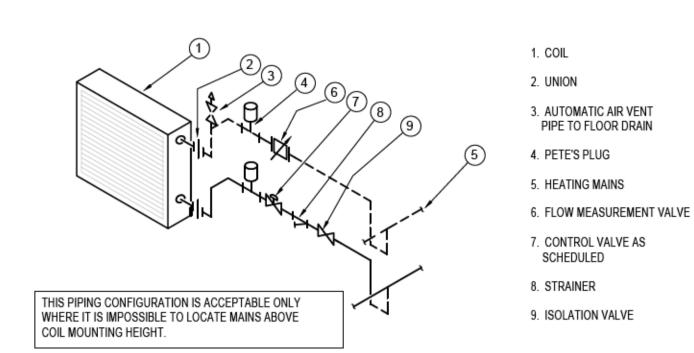

ZONE COIL PIPING ABOVE MAINS N.T.S.

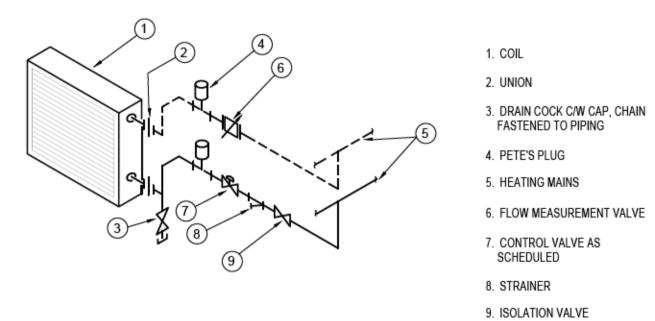

ZONE COIL PIPING BELOW MAINS N.T.S.

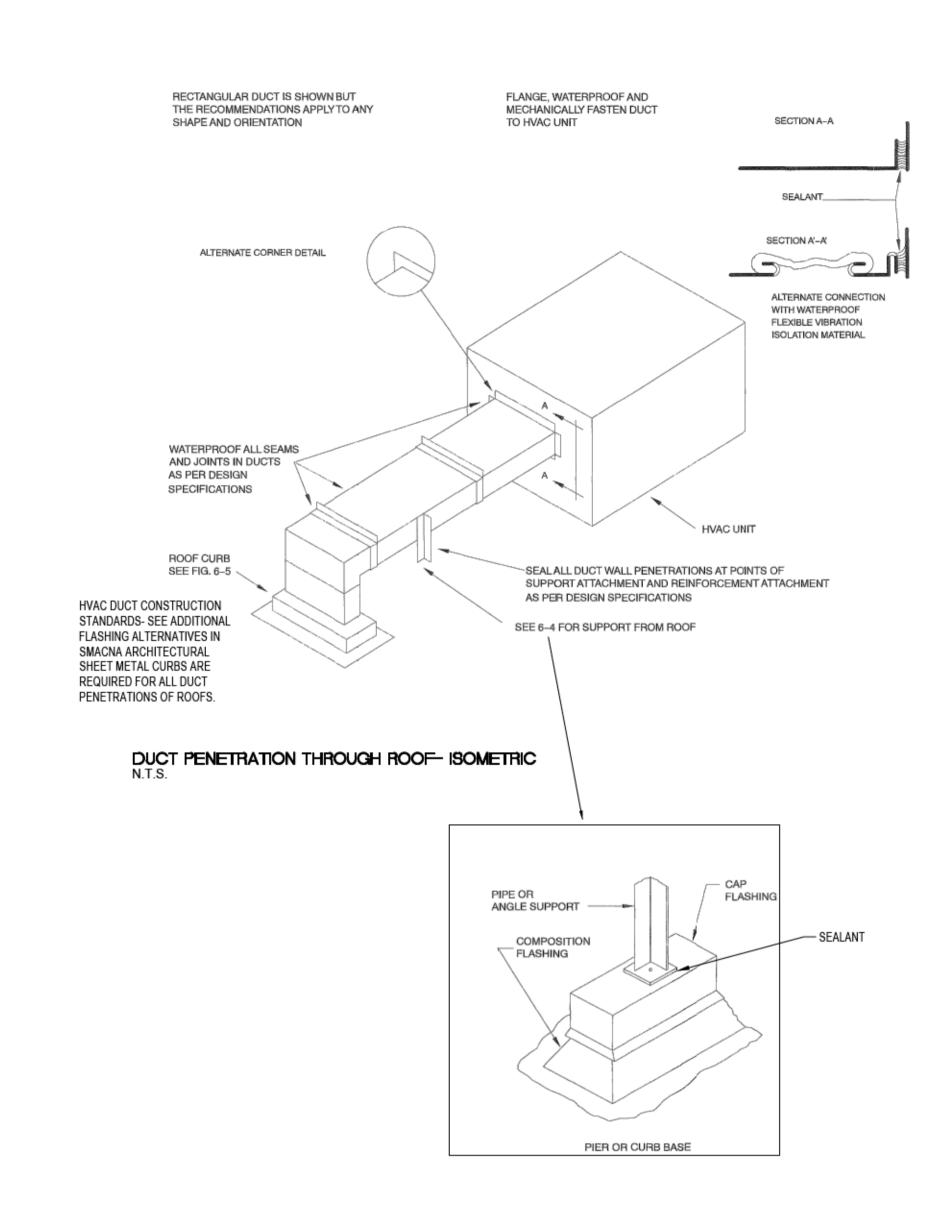

Government Services Services gouvernemental
Canada

REAL PROPERTY SERVICES
Pacific Region
SERVICES IMMOBILIERS
Région de Pacifique





5	RE-ISSUED FOR TENDER	2020.12.14		
4	ISSUED FOR TENDER	2020.11.18		
3	ISSUED FOR 99% SUBMISSION	2020.10.02		
N	ISSUED FOR 99% REVIEW	2020.09.24		
1	ISSUED FOR REVIEW	2020.09.15		
0	50% OF 66% SUBMISSION	2020.03.31		
Revision/ Revision	Description/Description	Date/Date		
Client/client				

CORRECTIONAL SERVICE CANADA

Project title/Titre du projet
ABBOTSFORD, BRITISH COLUMBIA
33344 KING ROAD
MATSQUI INSTITUTION BUILDING LU5

MATSQUI LIVING UNIT 5 UNDERSLAB SUPPLY VENTING

Consultant Signature Only

Designed by/Concept par
Ivan Nikolic

Drawn by/Dessine par
Dean Whaley

PWGSC Project Manager/Administrateur de Projets TPSGC
Ken Wendt

Regional Manager, Architectural and Engineering Services
Gestionnaire régionale, Services d'architectural et de génie, TPSGC
Preetipal Paul

Preetipal Paul

Drawing title/Titre du dessin

MECHANICAL - DETAILS CONTINUED

Project No./No. du projet Sheet/Feuille M209

Revision no. La Révision no.

PWGSC - A1 - 841X594

0 10 20 30 40 50 60 70 80 90 100mm

A