



Services gouvernementaux

REAL PROPERTY SERVICES Pacific Region SERVICES IMMOBILIERS Région de Pacifique



WSP Canada Group Limited.

Project 20M-00305-00

RE-ISSUED FOR TENDER 2020.12.14 2020.11.18 ISSUED FOR TENDER ISSUED FOR 99% SUBMISSION 2020.10.02 ISSUED FOR 80% REVIEW 2020.09.2 ISSUED FOR 66% REVIEW 2020.09.18

Description/Description

Date

Client/client CORRECTIONAL SERVICE CANADA

Project title/Titre du projet

MATSQUI INSTITUTION ABBOTSFORD, BC 33344 KING ROAD

MATSQUI LIVING UNIT 5 UNDERSLAB SUPPLY VENTING

Consultant Signature Only

Designed by/Concept par Drawn by/Dessine par

PWGSC Project Manager/Administrateur de Projets TPSGC

Preetipal Paul

Drawing title/Titre du dessin

TOTAL X

M2d 2ND LEVEL FLOOR PLAN - POWER/LIGHTING LAYOUT

R.111315.001

Revision na La Révisior 2 of 5

PANEL 'EB-2'

SPARE

TOTAL X

CORRIDOR AND REPLACE WITH 7 NEW TYPE-L LED LUMINAIRES,

RELOCATE LUMINAIRES AS SHOWN ON MECHANICAL DRAWINGS TO

REMOVE 7 EXISTING TYPE-A FLUORESCENT LUMINAIRES IN

RELOCATE EMERGENCY LIGHTS AS SHOWN ON MECHANICAL

DRAWINGS TO FREE UP SPACE FOR MECHANICAL EQUIPMENT.

SEAL IN AROUND ALL NEW AND RELOCATED LUMINAIRES WITH

REMOVE AND REPLACE CONDUIT AS SHOWN ON MECHANICAL DRAWINGS TO FREE UP SPACE FOR MECHANICAL EQUIPMENT.

WHERE CONDUITS ARE RUN ON THE CEILING IN THE CORRIDORS

BETWEEN CELLS, FIX THE CONDUITS TO THE UNDERSIDE OF EACH

PRE-CAST CONCRETE BEAM. USE TWO HOLE STRAPS TO SUPPORT THE CONDUIT ON EACH SIDE OF EACH BEAM. PROVIDE UNISTRUT IN THE MIDDLE BETWEEN EVERY TWO BEAMS TO PROPERLY SUPPORT

THE CONDUITS. ATTACH TO THE UNDERSLAB. MOUNT ALL JUNCTION

BETWEEN CELLS, FIX THE CONDUITS AT MAXIMUM 1200MM (4'-0")

WHERE CONDUITS ARE RUN ON THE WALLS IN THE CORRIDORS

CONDUIT RUN INSIDE CELLS SHALL BE FIXED ON 600MM (2'-0") CENTERS WITH TWO HOLE STRAPS. ALL NEW CONDUITS IN THE

PICK-PROOF SECURITY SEALANT. FOLLOWING INSTALLATION, PAINT

OVERSIZED. DO NOT KNOCK OUT LARGE OPENINGS. GET APPROVED

BE USED IN CELLS FOR CONDUIT FIXINGS AND BOX COVER PLATES

CELLS TO RUN PARALLEL TO EXISTING CONDUITS WITHOUT

9. SEAL IN BEHIND ALL CONDUITS IN CELLS BY TROWELLING IN THE

■ 10. SEAL CONDUIT PENETRATIONS THROUGH WALLS INTO CELLS FROM CORRIDOR OUTSIDE CELLS. DRILL HOLES ONLY SLIGHTLY

BY DEPARTMENTAL REPRESENTATIVE. SEAL WITH PICK-PROOF

■ 11. TORX HEAD TAMPER PROOF SCREWS WITH CENTRE PIN REJECT TO

12. CONDUITS IN INMATE ACCESSIBLE AREAS TO BE RIGID GALVANIZED

STEEL. CONDUITS IN CONTROL POST AND OTHER AREAS NOT

PERFORM ANY WORKS FOR SECURITY CAMERAS. HOULE ELECTRIC AND PALADIN SECURITY COMPANIES ARE KNOWN TO BE CERTIFIED AND THERE

ETC. AND REGULAR ROBERTSON HEAD ELSEWHERE.

13. HIRE AND PAY FOR GENETEC/PIVOT3 CERTIFIED CONTRACTORS TO

MAY BE OTHER CERTIFIED COMPANIES/CONTRACTORS AS WELL.

ACCESSIBLE BY INMATES TO BE EMT.

FREE UP SPACE FOR MECHANICAL EQUIPMENT.

GENERAL NOTES:

USING EXISTING CIRCUITS.

PICK-PROOF SECURITY SEALANT.

BOXES ON THE BEAMS.

CENTERS. USE TWO HOLE STRAPS.

CROSSING/OVERLAPPING THEM.

SECURITY SEALANT.

EXISTING DESCRIPTION kW BKR CIRCUIT NO. BKR kW DESCRIPTION RECEPTACLE SCU 14 RECEPTACLE SCU 02 RECEPTACLE SCU 15 RECEPTACLE SCU 03 RECEPTACLE SCU 16 RECEPTACLE SCU 04 RECEPTACLE SCU 17 RECEPTACLE SCU 05A RECEPTACLE SCU 19 RECEPTACLE SCU 07 RECEPTACLE SCU 08 RECEPTACLE SCU 09 RECEPTACLE SCU 10

RECEPTACLE SCU 21 RECEPTACLE SCU 22 RECEPTACLE SCU 23 RECEPTACLE SCU 24 RECEPTACLE SCU 25 RECEPTACLE SCU 12 RECEPTACLE SCU 26 RECEPTACLE SCU 13 NIGHT LIGHT LEFT NIGHT LIGHT RIGHT SHOWER SCU 18 SHOWER SCU 5B CORRIDOR LTG SPARE CORRIDOR ENTRANCE LTO SPARE

SPARE DOOR LOCK AND BELL DDC- GUARD BUBBLE CEILING CONTROL POST LTG + EMERGENCY CONTROL POST PLUGS

CONTROL POST PLUGS 59 60 15 EXIT & EMERGENCY LTG.

EXISTING RELAY PANEL 'RP-EB2' DESCRIPTION CCT. # RELAY NO. CCT. # DESCRIPTION

DESCRIPTION	001.#	KELA	I NO.	001.#	DESCRIPTION
RECEPTACLE SCU 01	EB2-1	1	2	EB2-2	RECEPTACLE SCU 14
RECEPTACLE SCU 02	EB2-3	3	4	EB2-4	RECEPTACLE SCU 15
RECEPTACLE SCU 03	EB2-5	5	6	EB2-6	RECEPTACLE SCU 16
RECEPTACLE SCU 04	EB2-7	7	8	EB2-8	RECEPTACLE SCU 17
RECEPTACLE SCU 05A	EB2-9	9	10	EB2-10	RECEPTACLE SCU 19
RECEPTACLE SCU 06	EB2-11	11	12	EB2-12	RECEPTACLE SCU 20
RECEPTACLE SCU 07	EB2-13	13	14	EB2-14	RECEPTACLE SCU 21
RECEPTACLE SCU 08	EB2-15	15	16	EB2-16	RECEPTACLE SCU 22
RECEPTACLE SCU 09	EB2-17	17	18	EB2-18	RECEPTACLE SCU 23
RECEPTACLE SCU 10	EB2-19	19	20	EB2-20	RECEPTACLE SCU 24
RECEPTACLE SCU 11	EB2-21	21	22	EB2-22	RECEPTACLE SCU 25
RECEPTACLE SCU 12	EB2-23	23	24	EB2-24	RECEPTACLE SCU 26
RECEPTACLE SCU 13	EB2-25	25	26	EB2-26	NIGHT LIGHT LEFT
NIGHT LIGHT RIGHT	EB2-27	27	28	EB2-28	SHOWER SCU 18
SHOWER SCU 5B	EB2-29	29	30	EB2-30	CORRIDOR LTG
SPARE	EB2-31	31	32	EB2-32	CORRIDOR LTG
SPARE	EB2-33	33	34	EB2-34	CORRIDOR ENTRANCE LTG
SPARE	EB2-35	35	36		
SPARE	EB2-37	37	38		
SPARE	EB2-39	39	40		
SPARE	EB2-41	41	42		
					1

RELOCA	ATE LUMINAIRES			
SCU18 EB2-8 EB2H28ER	SCU19 SCU20 EB2-12 A A		SCU24 B EB2-20	J26 /
	-1 1/2"C -1 1/2"	1 1/4"C	1 1/4"C	1/2"C TYPICAL 3/4"C TYPICAL
				NEW TYPE-L 600 X 600 LED LUMINAIRE TO BE INSTALLED (TYPICAL FOR 7 IN CORRIDOR)
A				EXISTING TYPE—A 300 X 1200 FLUORESCENT LUMINAIRE TO BE DEMOLISHED (TYPICAL FOR 7 IN CORRIDOR)
EB2-9 EB2-29 SCU05A SCU05B SHOWER RELOCATE LUMINAIRE		EB2-15 EB2-17 EB2-1 SCU10	9 EB2-21 EB2-23 EB2-2: SCU12 SCU	J / / k7



--- PANEL 'EB'

EB2-1

SCU01

RELOCATE LUMINAIRES EB2-5 | EB2-7

PANEL 'EB-2' -120/208V 3P4W

RELAY PANEL

EXERCISE YARD

'RP-EB2'

DRAWING KEY NOTES:

- 400mm x 400mm x 150mm JUNCTION BOX. ② 350mm x 350mm x 150mm JUNCTION BOX. 300mm x 300mm x 150mm JUNCTION BOX.
- 4 300mm x 300mm x 150mm JUNCTION BOX.
- 5 250mm x 250mm x 150mm JUNCTION BOX. 6 200mm x 200mm x 150mm JUNCTION BOX.
- 150mm x 150mm x 150mm JUNCTION BOX. 8 RELOCATE EXISTING CAMERA TO ACCOMMODATE MECHANICAL INSTALLATION AND LINE OF SIGHT

M2d 2ND LEVEL FLOOR PLAN (SCU) - POWER/LIGHTING LAYOUT SCALE: 1:100

(9) EXISTING CAMERA TO REMAIN IN PLACE

EXTERNAL VIDEO CAMERA RELOCATIONS

SCU08

SCU07


DETAIL #1: TYPICAL CELL PLAN

DETAIL #2: SWITCHING PANEL FOR BUILDING M2d (SCU)


* PRODUCTS SPECIFIED ARE MINIMUM ACCEPTABLE STANDARD.

NEW LUMINAIRE SCHEDULE VOLT/BALLAST NO. TYPE (EACH) TYPE DESCRIPTION CATALOGUE NO. MOUNTING REMARKS PROVIDE 14 LUMINAIRES, 7 FOR EACH LED NIGHT SURFACE FLOOR. SURFACE MOUNT LED LUMINAIRE COMPLETE WITH LED NIGHT LIGHT. SUITABLE FOR SURFACE CONDUIT. SDD2-9/9-25L40K-DCC-120-1/J-1-DLN

PWGSC - A1 - 841X594

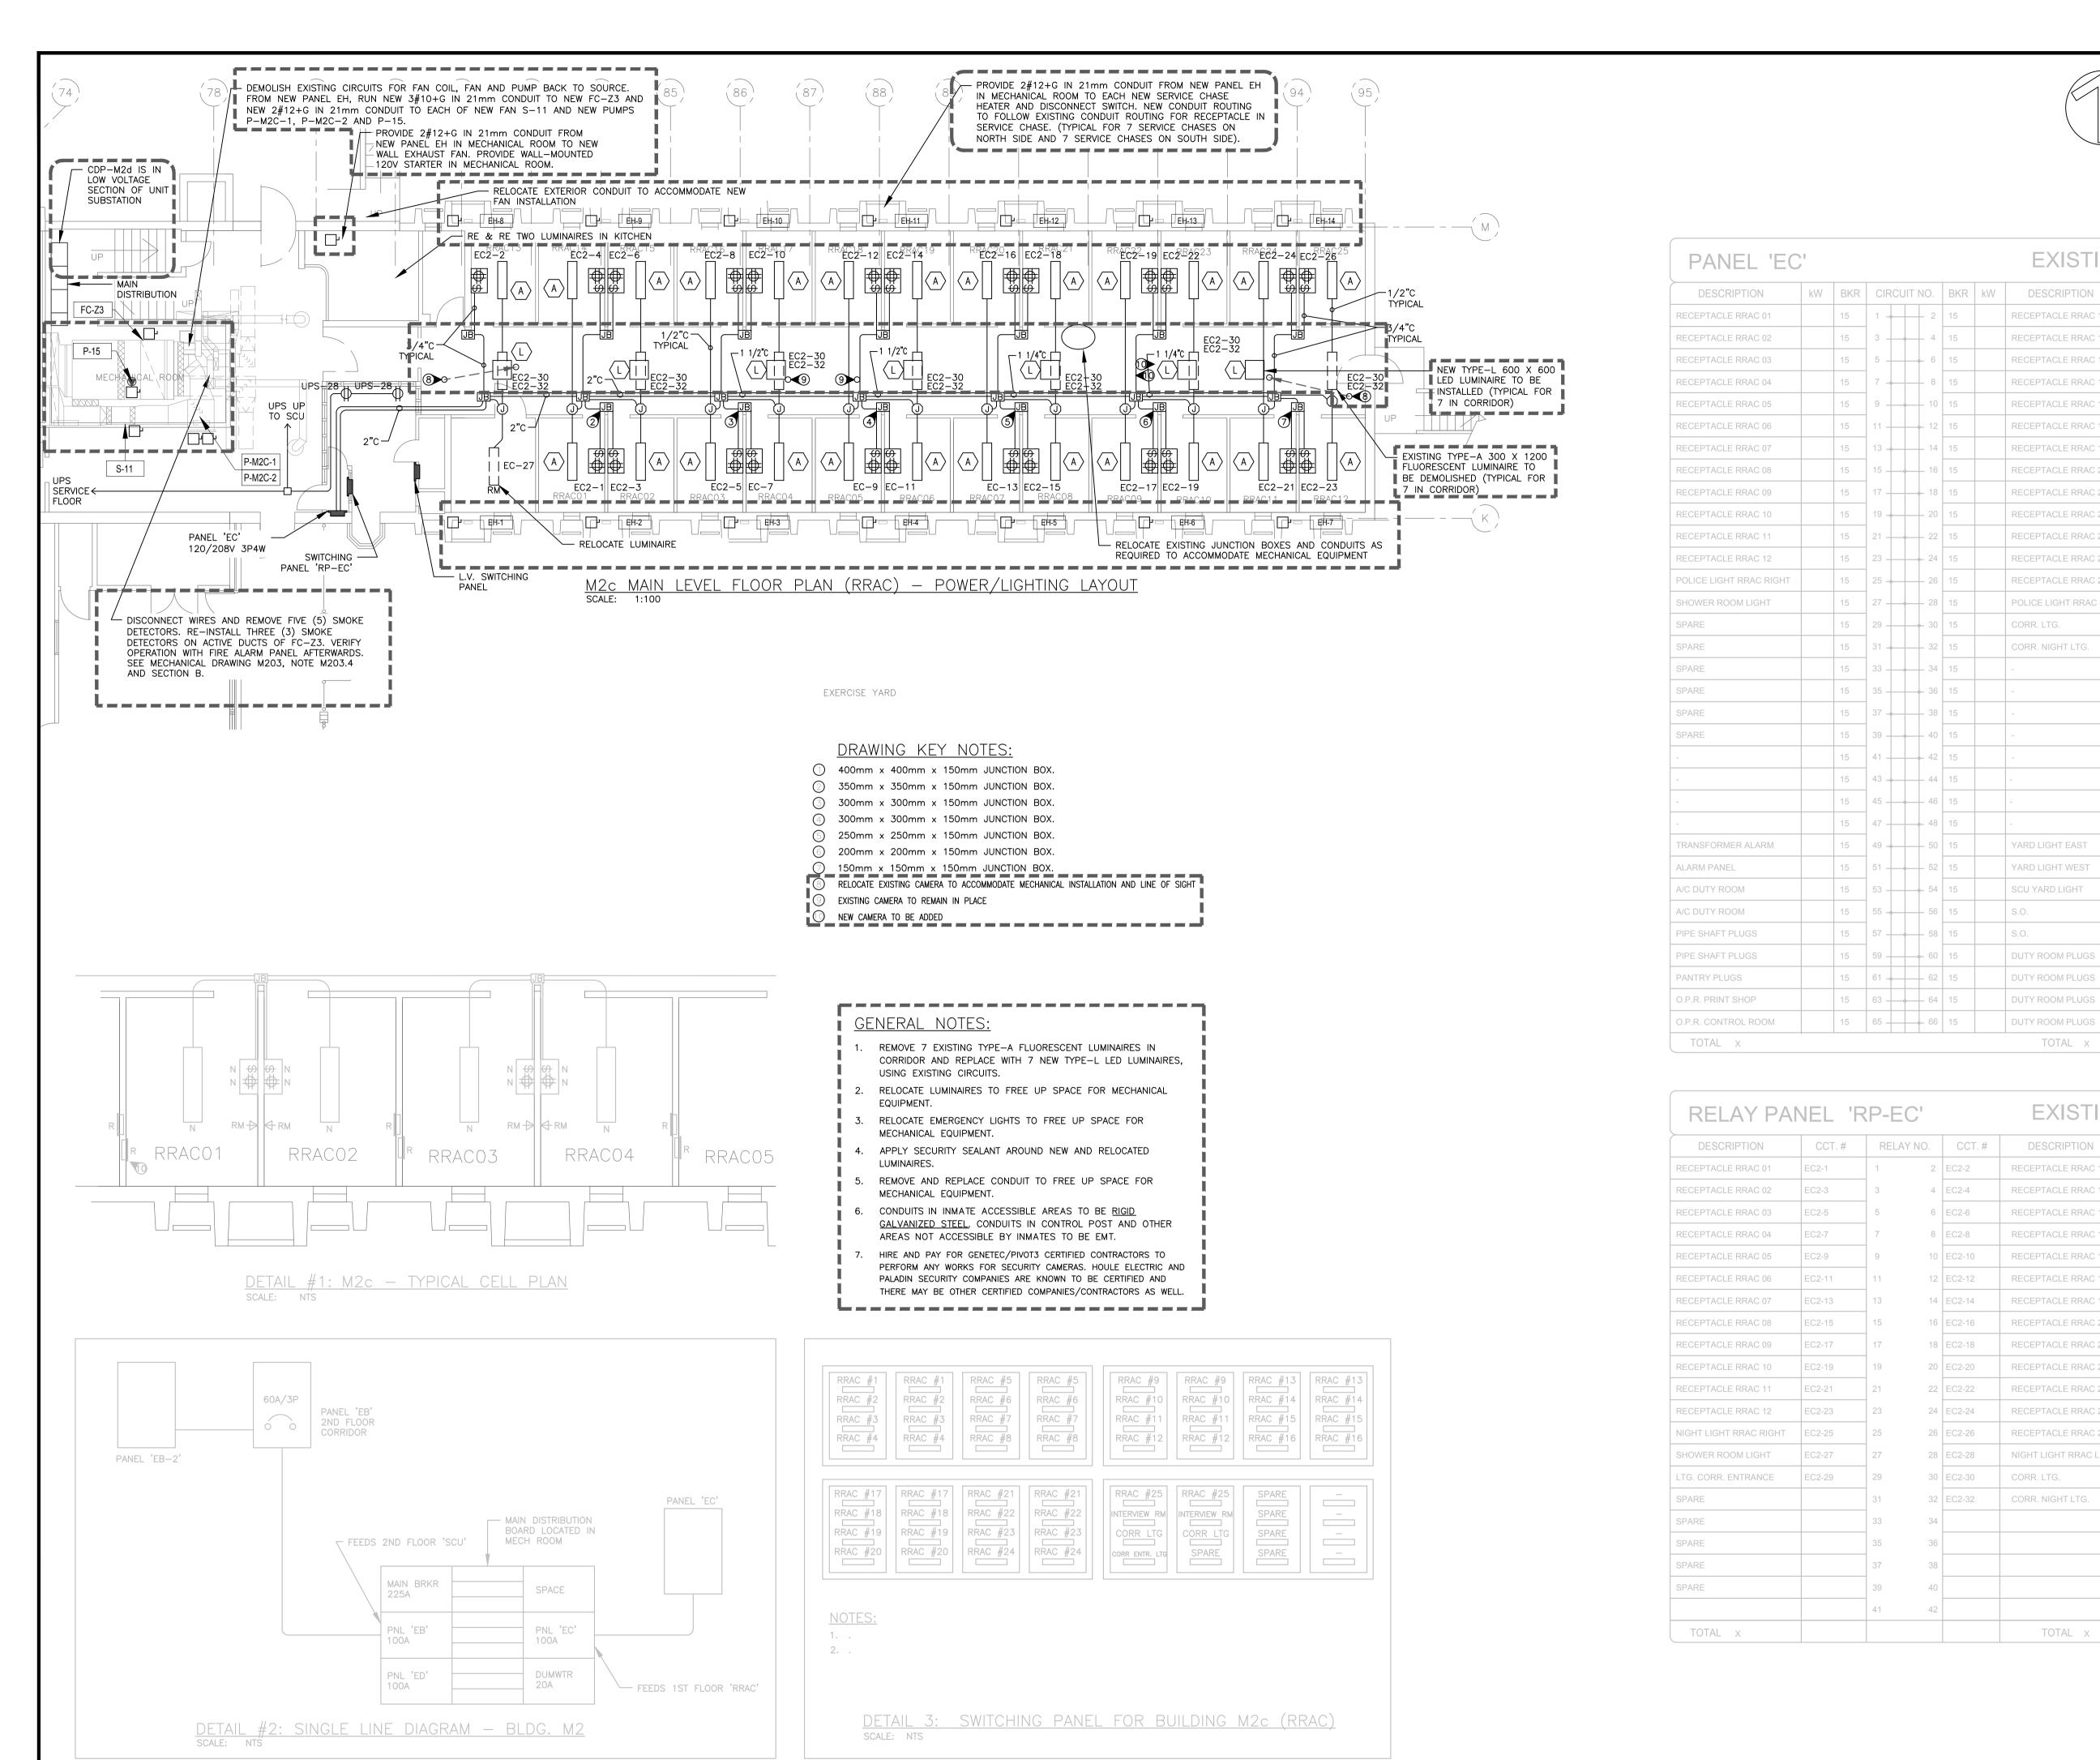

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EXISTING

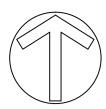RECEPTACLE RRAC 13

RECEPTACLE RRAC 14

RECEPTACLE RRAC 15

RECEPTACLE RRAC 16

RECEPTACLE RRAC 17

RECEPTACLE RRAC 18

RECEPTACLE RRAC 19

RECEPTACLE RRAC 20

RECEPTACLE RRAC 21

RECEPTACLE RRAC 23

RECEPTACLE RRAC 24

RECEPTACLE RRAC 25

CORR NIGHT LTG

SCU YARD LIGHT

DUTY ROOM PLUGS

DUTY ROOM PLUGS

DUTY ROOM PLUGS

TOTAL X

EXISTING

DESCRIPTION

RECEPTACLE RRAC 14

RECEPTACLE RRAC 15

RECEPTACLE RRAC 16

RECEPTACLE RRAC 17

RECEPTACLE RRAC 18

RECEPTACLE RRAC 19

RECEPTACLE RRAC 20

RECEPTACLE RRAC 21

RECEPTACLE RRAC 22

RECEPTACLE RRAC 23

RECEPTACLE RRAC 24

RECEPTACLE RRAC 25

NIGHT LIGHT RRAC LEFT

TOTAL X

CORR. NIGHT LTG.

15 29 30

15 | 33 | 34 | 15

15 | 39 | 40 | 15

15 41 42 15

15 | 43 | 44 | 15

15 | 47 | 48 | 15

15 | 49 | 50 | 15

15 | 63 | 64 | 15

2 EC2-2

6 EC2-6

8 EC2-8

12 EC2-12

4 EC2-14

6 EC2-16

18 EC2-18

26 EC2-26

28 EC2-28

2 EC2-32

15 65 66

POLICE LIGHT RRAC LEFT

Public Works and Government Services

Travaux publics et Services gouvernementaux

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MATSQUI INSTITUTION ABBOTSFORD, BC 33344 KING ROAD

MATSQUI LIVING UNIT 5 **UNDERSLAB SUPPLY VENTING**


Designed by/Concept par Norman Wong				
Drawn by/Dessine par Thang Cao				
PWGSC Project Manager/Administrateur de Projets TPSGC Ken Wendt				
Regional Manager, Architectural and Engineering Services Gestionnaire régionale, Services d'architectural et de génie, TPSGC				

Drawing title/Titre du dessin

M2c MAIN LEVEL FLOOR PLAN - POWER/LIGHTING LAYOUT

R.111315.001

Revision no La Révision Sheet/Feuille 5 3 o 5

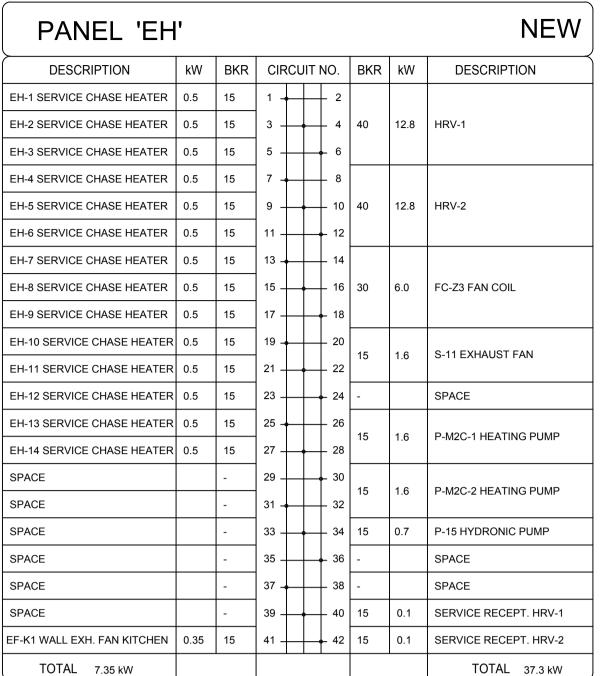

SPECIFICATIONS

• 100A MAIN CIRCUIT BREAKER

• 225A BUS, 120/208V • SEE SECTION 26 24 17


INSTALL NEW PANEL EH -

IN MECHANICAL ROOM

GENERAL NOTES:

1. ARRANGE FOR ARC FLASH AND SHOCK HAZARD WARNING LABELS TO BE PUT ON ALL NEW PANELS.

Mechanic	al Equipment Schedule										
Tag No.	Unit Description	Location	Volts	Phase	FLA	HP	Panel	Circuit No.	Conduit Size	Wire Size	Disc. Sw
EF-K1	Kitchenette wall exhaust fan	Kitchenette - 1st floor	120	1	2.9	1/4	EH	41	21mm	2#12+G	E, 30A
HRV-1	Heat Recovery Unit - 2nd floor	Roof, straddling GL '86'	208	3	35.6	1+2	EH	2, 4, 6	27mm	3#6+G	М
HRV-2	Heat Recovery Unit - 1st floor	Roof, straddling GL '91'	208	3	35.6	1+2	EH	8, 10, 12	27mm	3#6+G	М
P-M2C-1	Hydronic heating secondary pum	Mechanical Room - 1st Floo	208	1	7.6	3/4	EH	26, 28	21mm	2#12+G	E, 30A
P-M2C-2	Hydronic heating secondary pum	Mechanical Room - 1st Floo	208	1	7.6	3/4	EH	30, 32	21mm	2#12+G	E, 30A
FC-Z3	Fan Coil	Mechanical Room - 1st Floo	208	3	16.7	5	EH	14, 16, 18	21mm	3#10+G	E, 30A
S-11	Exhaust Fan	Mechanical Room - 1st Floo	208	1	7.6	3/4	EH	20, 22	21mm	2#12+G	E, 30A
P-15	Hydronic pump	Mechanical Room - 1st Floo	120	1	5.8	1/4	EH	34	21mm	2#12+G	E, 30A
EH-1	Electrical heater	Exterior service chase	120	1	4.2		EH	1	21mm	2#12+G	E, 30A
EH-2	Electrical heater	Exterior service chase	120	1	4.2		EH	3	21mm	2#12+G	E, 30A
EH-3	Electrical heater	Exterior service chase	120	1	4.2		EH	5	21mm	2#12+G	E, 30A
EH-4	Electrical heater	Exterior service chase	120	1	4.2		EH	7	21mm	2#12+G	E, 30A
EH-5	Electrical heater	Exterior service chase	120	1	4.2		EH	9	21mm	2#12+G	E, 30A
EH-6	Electrical heater	Exterior service chase	120	1	4.2		EH	11	21mm	2#12+G	E, 30A
EH-7	Electrical heater	Exterior service chase	120	1	4.2		EH	13	21mm	2#12+G	E, 30A
EH-8	Electrical heater	Exterior service chase	120	1	4.2		EH	15	21mm	2#12+G	E, 30A
EH-9	Electrical heater	Exterior service chase	120	1	4.2		EH	17	21mm	2#12+G	E, 30A
EH-10	Electrical heater	Exterior service chase	120	1	4.2		EH	19	21mm	2#12+G	E, 30A
EH-11	Electrical heater	Exterior service chase	120	1	4.2		EH	21	21mm	2#12+G	E, 30A
EH-12	Electrical heater	Exterior service chase	120	1	4.2		EH	23	21mm	2#12+G	E, 30A
EH-13	Electrical heater	Exterior service chase	120	1	4.2		EH	25	21mm	2#12+G	E, 30A
EH-14	Electrical heater	Exterior service chase	120	1	4.2		EH	27	21mm	2#12+G	E, 30A
	E - sup	plied, installed and wired by	[,] Electrical	, M - suppl	ied, install	ed and wir	ed by Med	chanical			

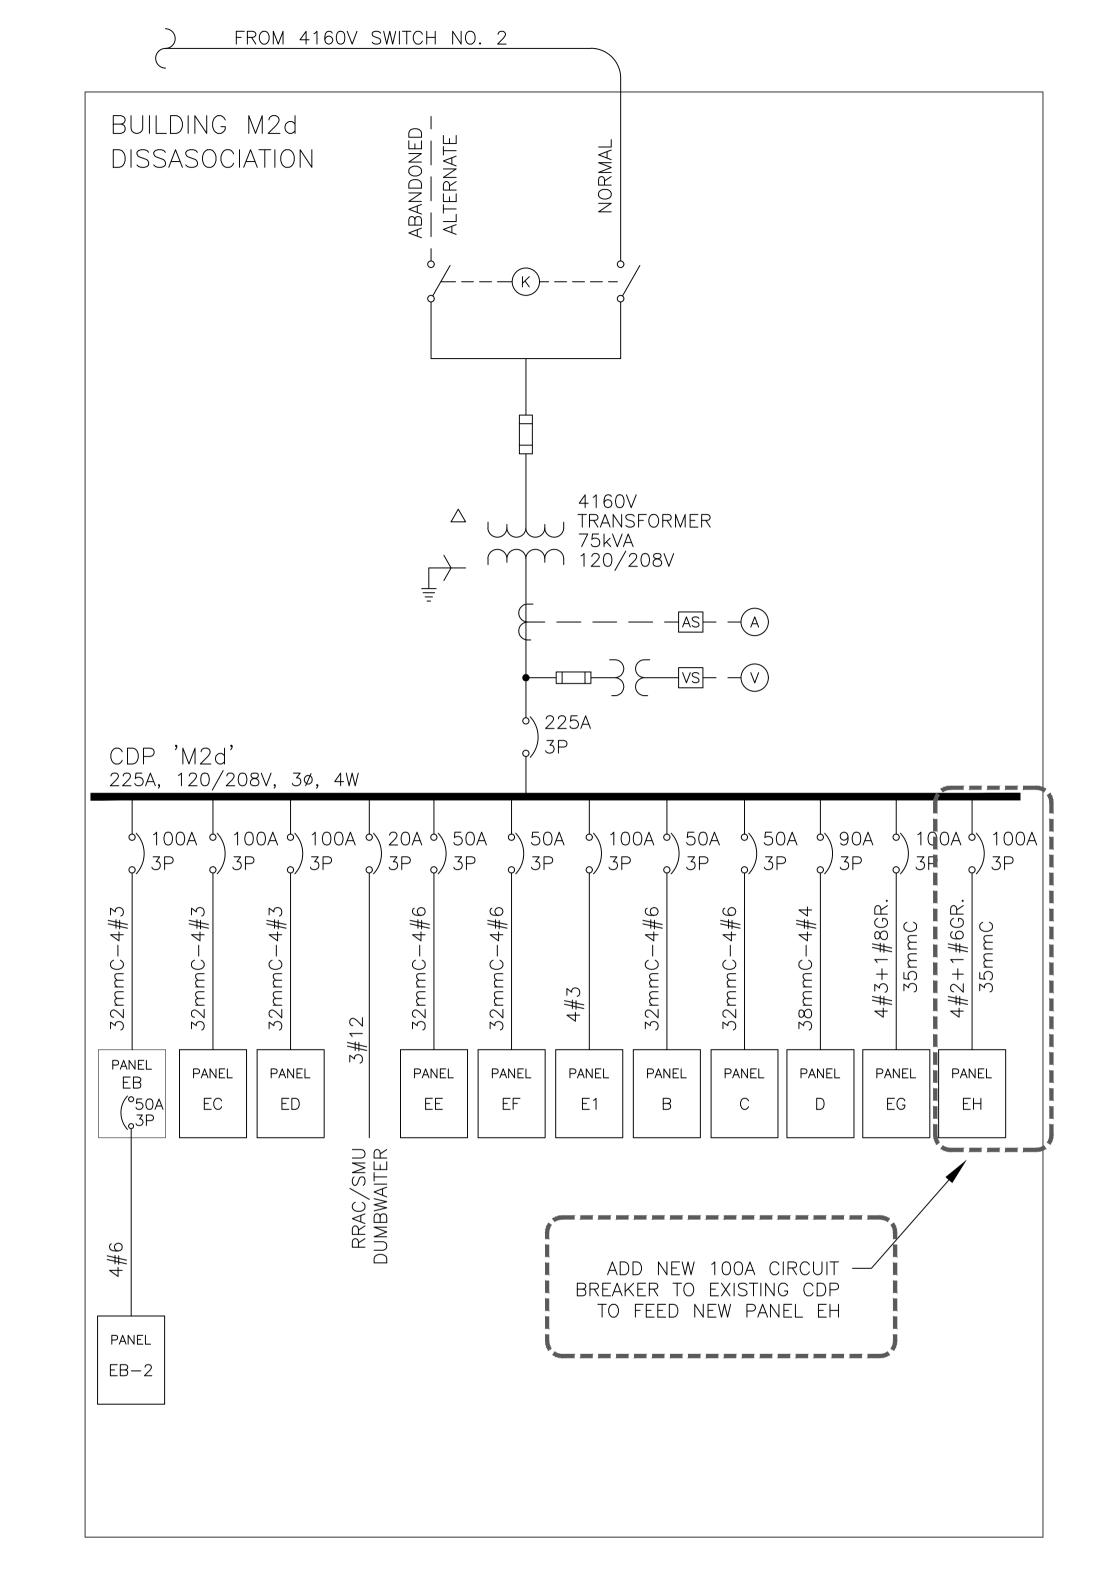

Public Works and Government Services Canada

Public Works and Travaux publics et Services gouvernementaux Canada

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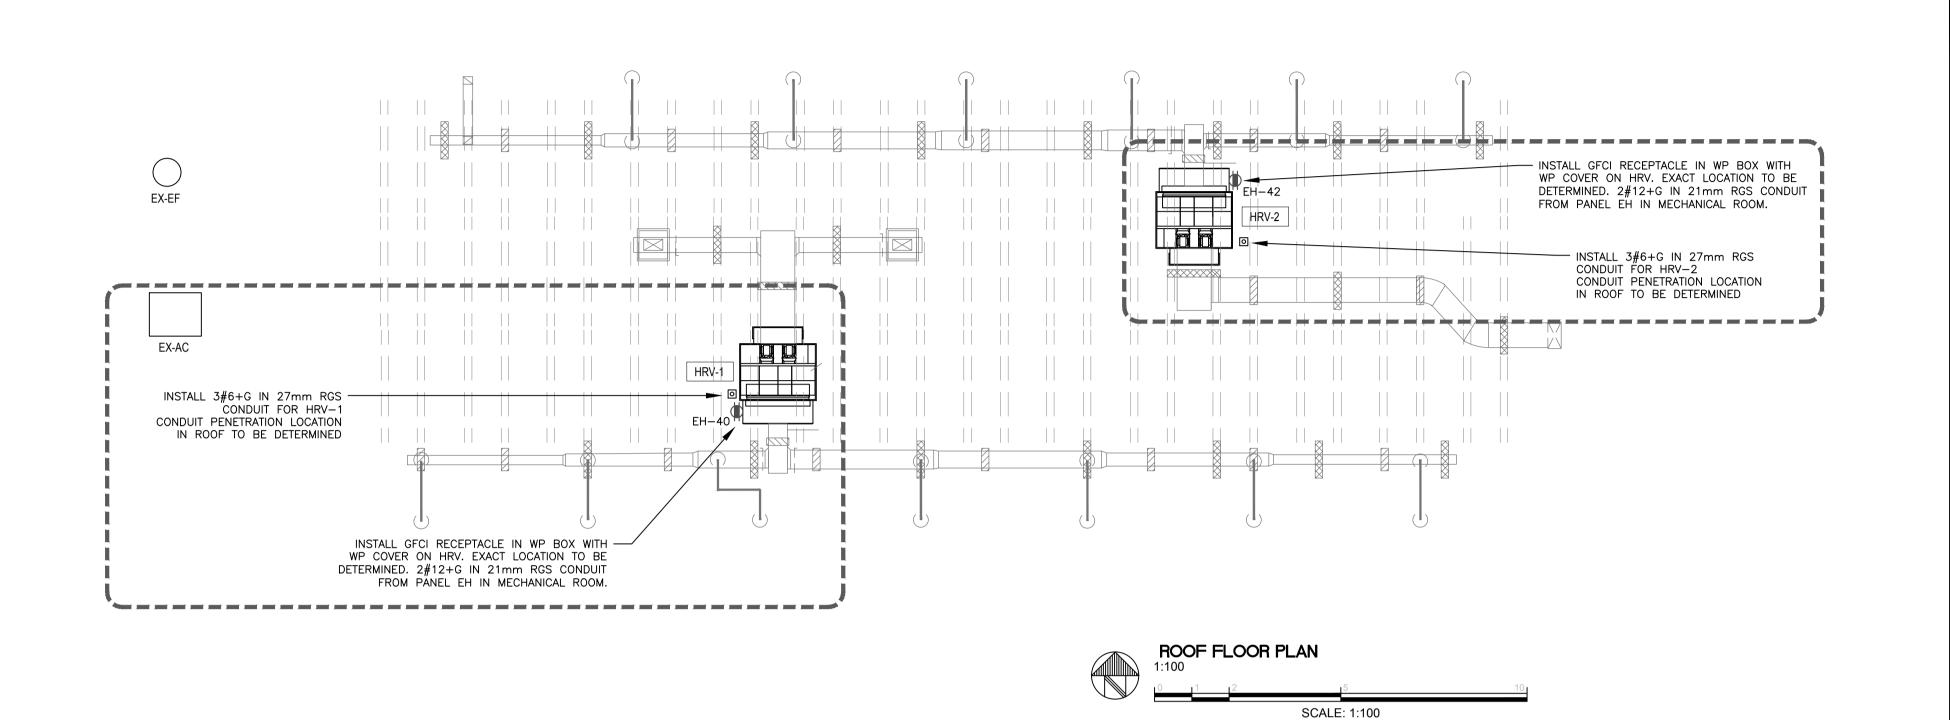
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M2c & M2d - PANEL 'EH' SCHEDULE/SINGLE LINE DIAGRAM

R.111315.001

Revision no La Révision E119 4 4 o_F 5

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Public Works and Government Services Services gouvernementaux Canada

REAL PROPERTY SERVICES
Pacific Region
SERVICES IMMOBILIERS Région de Pacifique





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PWGSC Project Manager/Administrateur de Projets TPSGC

Regional Manager, Architectural and Engineering Services Gestionnaire régionale, Services d'architectural et de génie, TPSGC Preetipal Paul

Drawing title/Titre du dessin

ROOF PLAN - NEW POWER/LIGHTING LAYOUT

R.111315.001

E120 5 o_F 5

PWGSC - A1 - 841X594

0 10 20 30 40 50 60 70 80 90 100mm

Revision no. La Révision