



CONTRACTOR SHALL REMOVE ALL ELECTRICAL EQUIPMENT INCLUDING, BUT NOT LIMITED TO, EXISTING WIRING DEVICES, RECEPTACLES, MOTORS, DATA AND TELEPHONE OUTLETS, CLOCKS, SECURITY SYSTEM DEVICES, PUBLIC ADDRESS AND INTERCOM SYSTEM DEVICES, ELECTRIC HEATERS, THERMOSTATS, HEATER RELAYS AND TRANSFORMERS, MECHANICAL EQUIPMENT DISCONNECTS, FEEDERS AND CONTROLS, FANS, FAN CONTROLS, HAND DRYERS, GAS DETECTION DEVICES, CABLE TELEVISION OUTLETS, ZONE CONDUITS, ELEVATOR CONTROLS, DISTRIBUTION PANELS, DISCONNECT SWITCHES, CIRCUIT BREAKERS, PANELS, SWITCHBOARDS, SERVICE ENTRANCE EQUIPMENT, TRANSFORMERS, WIRING AND CONDUIT. ALL ASSOCIATED WIRING AND CONDUIT TO BE REMOVED BACK TO SOURCE. THIS DEMOLITION PLAN MAY NOT INDICATE THE EXACT NUMBER OF ALL DEVICES TO BE REMOVED, BUT THE CONTRACTOR IS RESPONSIBLE TO REMOVE ALL DEVICES.

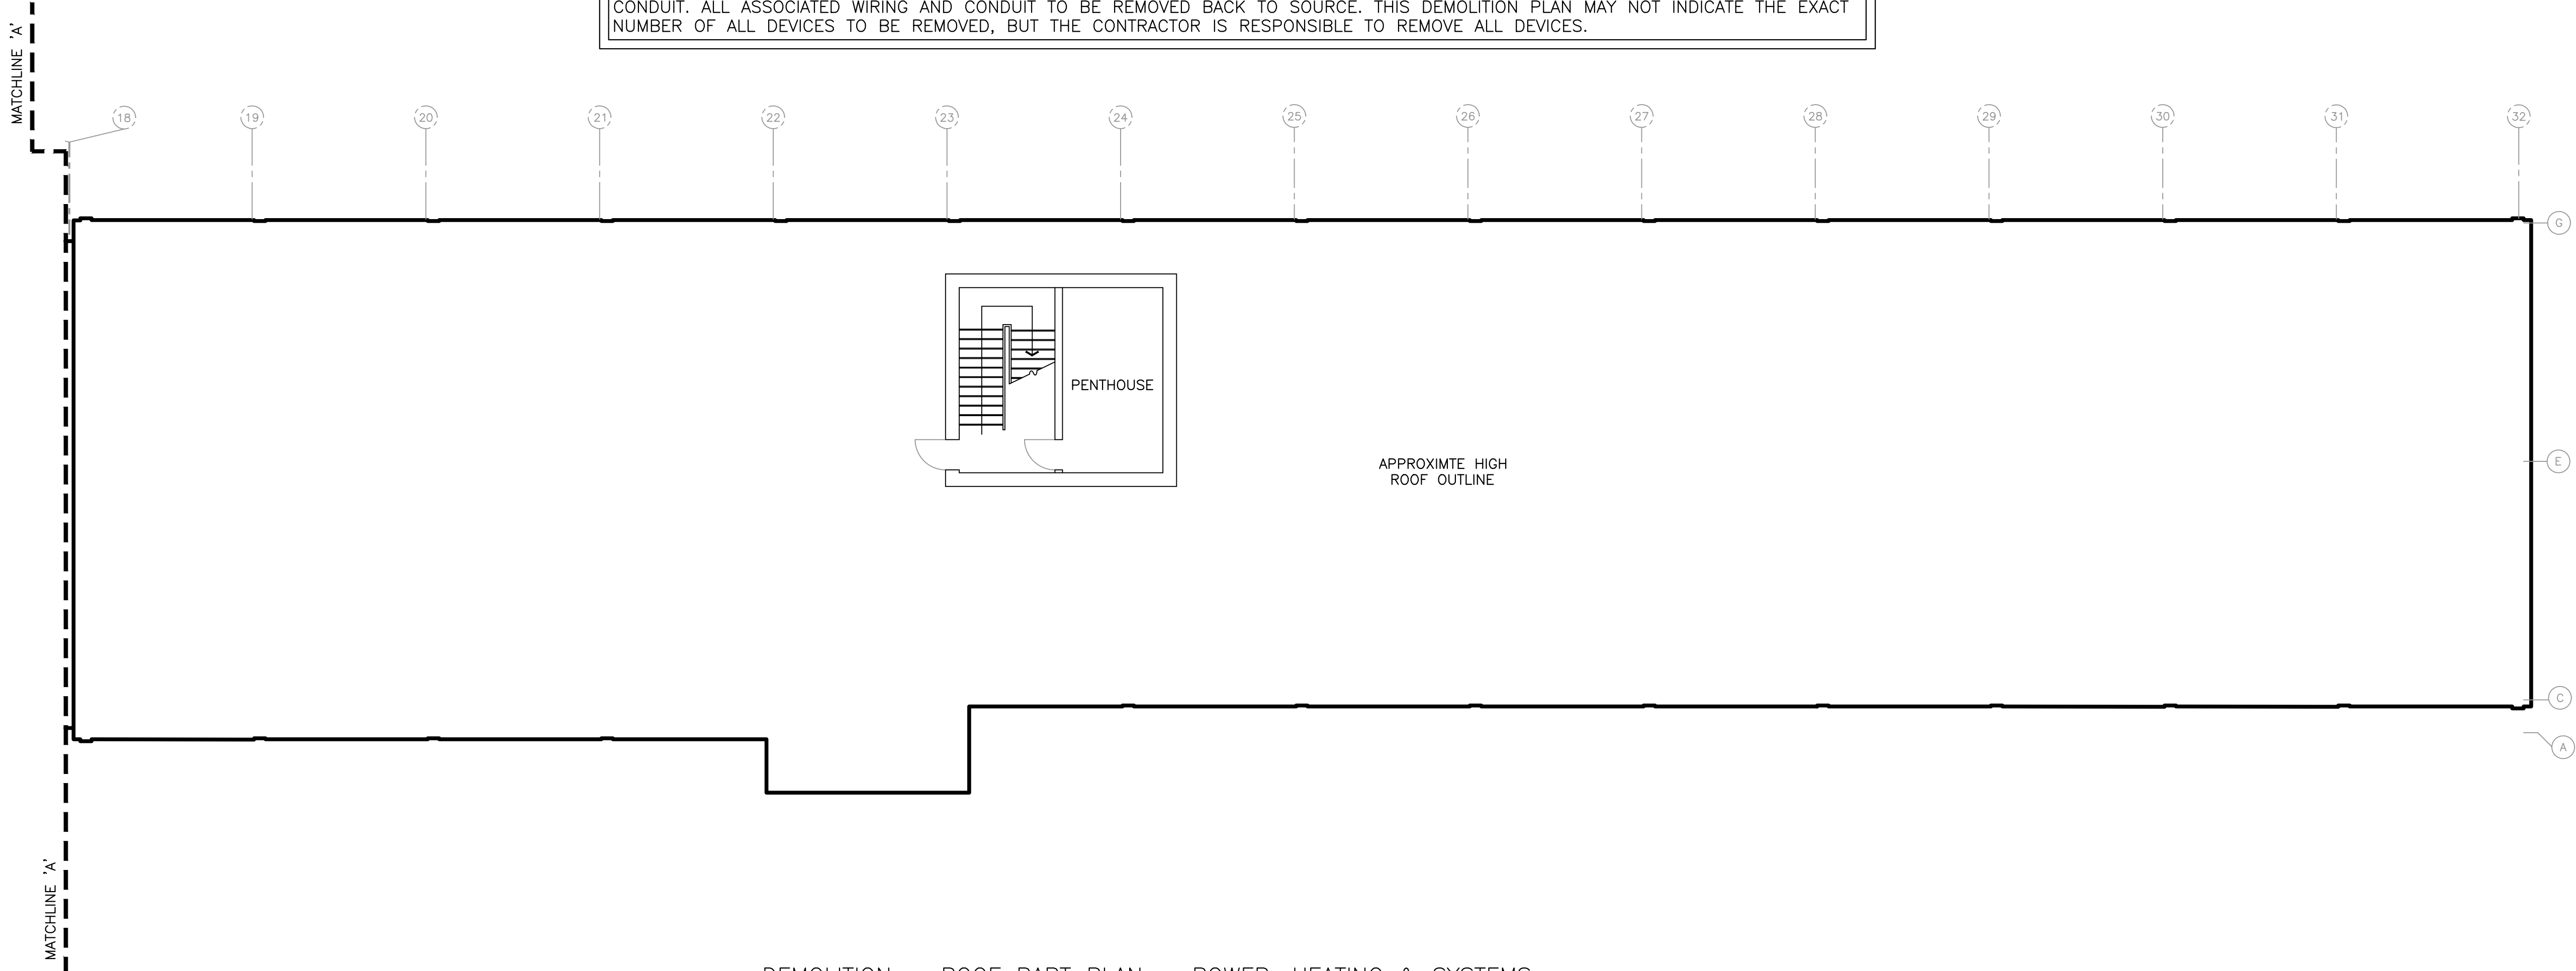

DEMOLITION - ROOF PART PLAN - POWER, HEATING & SYSTEMS
SCALE : 1:100
0m 1m 2m 3m 4m 5m 6m 7m 8m 9m 10m

CONTRACTOR SHALL REMOVE ALL ELECTRICAL EQUIPMENT INCLUDING, BUT NOT LIMITED TO, EXISTING WIRING DEVICES, RECEPTACLES, MOTORS, DATA AND TELEPHONE OUTLETS, CLOCKS, SECURITY SYSTEM DEVICES, PUBLIC ADDRESS AND INTERCOM SYSTEM DEVICES, ELECTRIC HEATERS, THERMOSTATS, HEATER RELAYS AND TRANSFORMERS, MECHANICAL EQUIPMENT DISCONNECTS, FEEDERS AND CONTROLS, FANS, FAN CONTROLS, HAND DRYERS, GAS DETECTION DEVICES, CABLE TELEVISION OUTLETS, ZONE CONDUITS, ELEVATOR CONTROLS, DISTRIBUTION PANELS, DISCONNECT SWITCHES, CIRCUIT BREAKERS, PANELS, SWITCHBOARDS, SERVICE ENTRANCE EQUIPMENT, TRANSFORMERS, WIRING AND CONDUIT. ALL ASSOCIATED WIRING AND CONDUIT TO BE REMOVED BACK TO SOURCE. THIS DEMOLITION PLAN MAY NOT INDICATE THE EXACT NUMBER OF ALL DEVICES TO BE REMOVED, BUT THE CONTRACTOR IS RESPONSIBLE TO REMOVE ALL DEVICES.

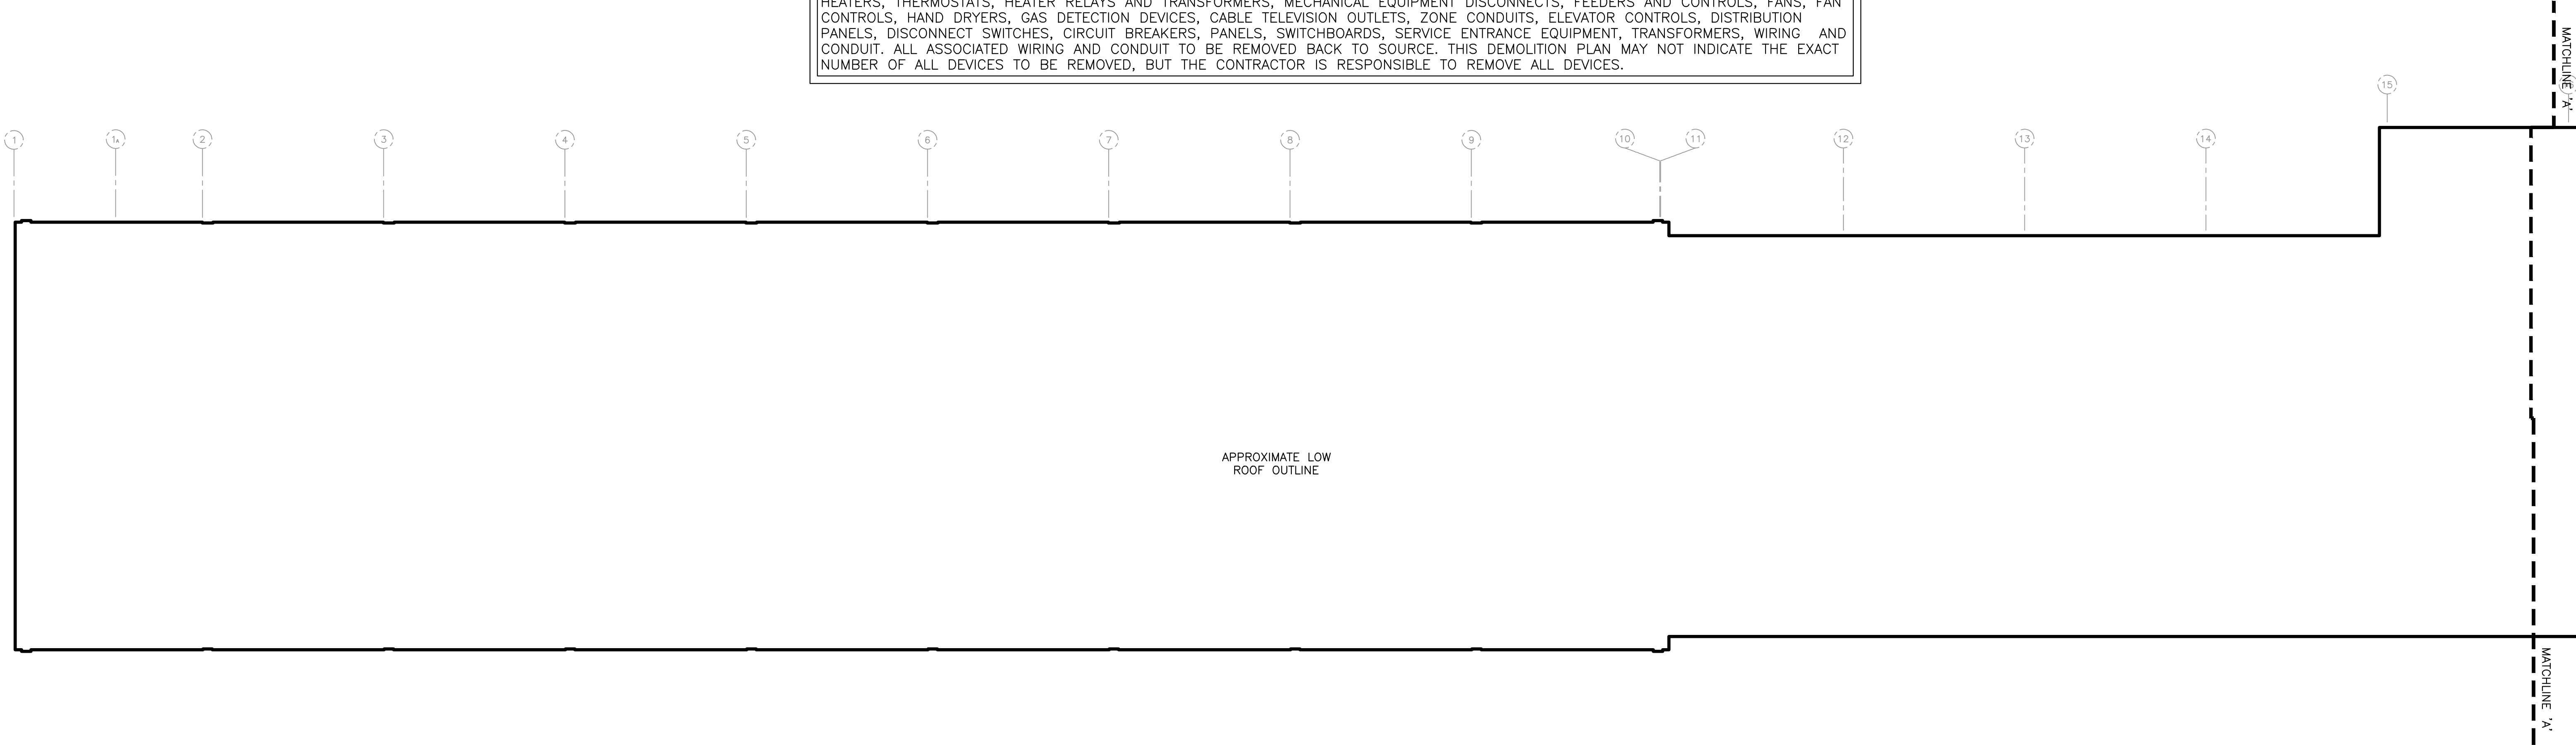

DEMOLITION - ROOF PART PLAN - POWER, HEATING & SYSTEMS
SCALE : 1:100
0m 1m 2m 3m 4m 5m 6m 7m 8m 9m 10m

0	ISSUED FOR TENDER	12/16/21
revisions		date

project
DECOMMISSIONING, DEMOLITION AND SITE RESTORATION SSB HQ
SOUTHSIDE ROAD
ST. JOHN'S, NL

drawing
DEMO
dessein
DEMOLITION
ROOF PLAN
POWER, HEATING
& SYSTEMS

designed K.N.	conçu
date DECEMBER 2021	
drawn B.C.	dessiné
date DECEMBER 2021	
approved K.N.	approuvé
date DECEMBER 2021	
Tender	Submission
PWSC Project Manager	Administrateur de projets TPSC
project number	no. du projet
R.111146.001	
drawing no.	no. du dessin