



NORR

NORR Architects & Engineers Limited
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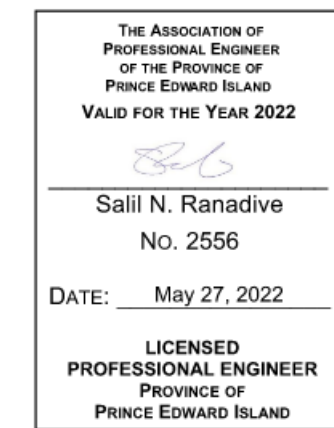
Key plan

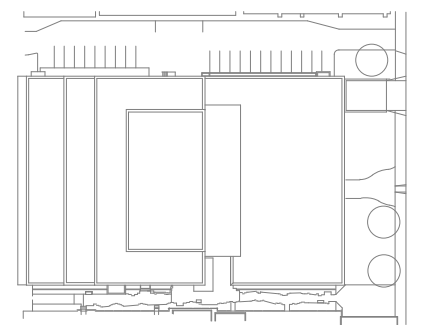

Project and True North



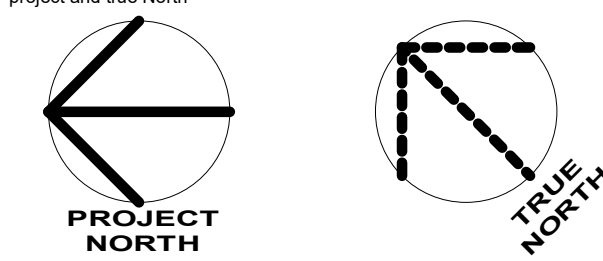Project legend



0 ISSUED FOR TENDER 2022-05-27

revisions date

project project

DANIEL J MACDONALD
MODERNIZATION

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drawing dessin

COMMUNICATIONS
PLAN - THIRD FLOOR

designed NORR compu

date 01/02/19

drawn NORR dessin

date 01/02/19

approved SR approuvé

date 2022-05-27

Tender Soumission

PWGSC Project Manager Administrateur de projets TPSC


project number no. du projet

R.056687.005

drawing no. no. du dessin

E40-03

E-OPM/ODD-E: 553185 v1

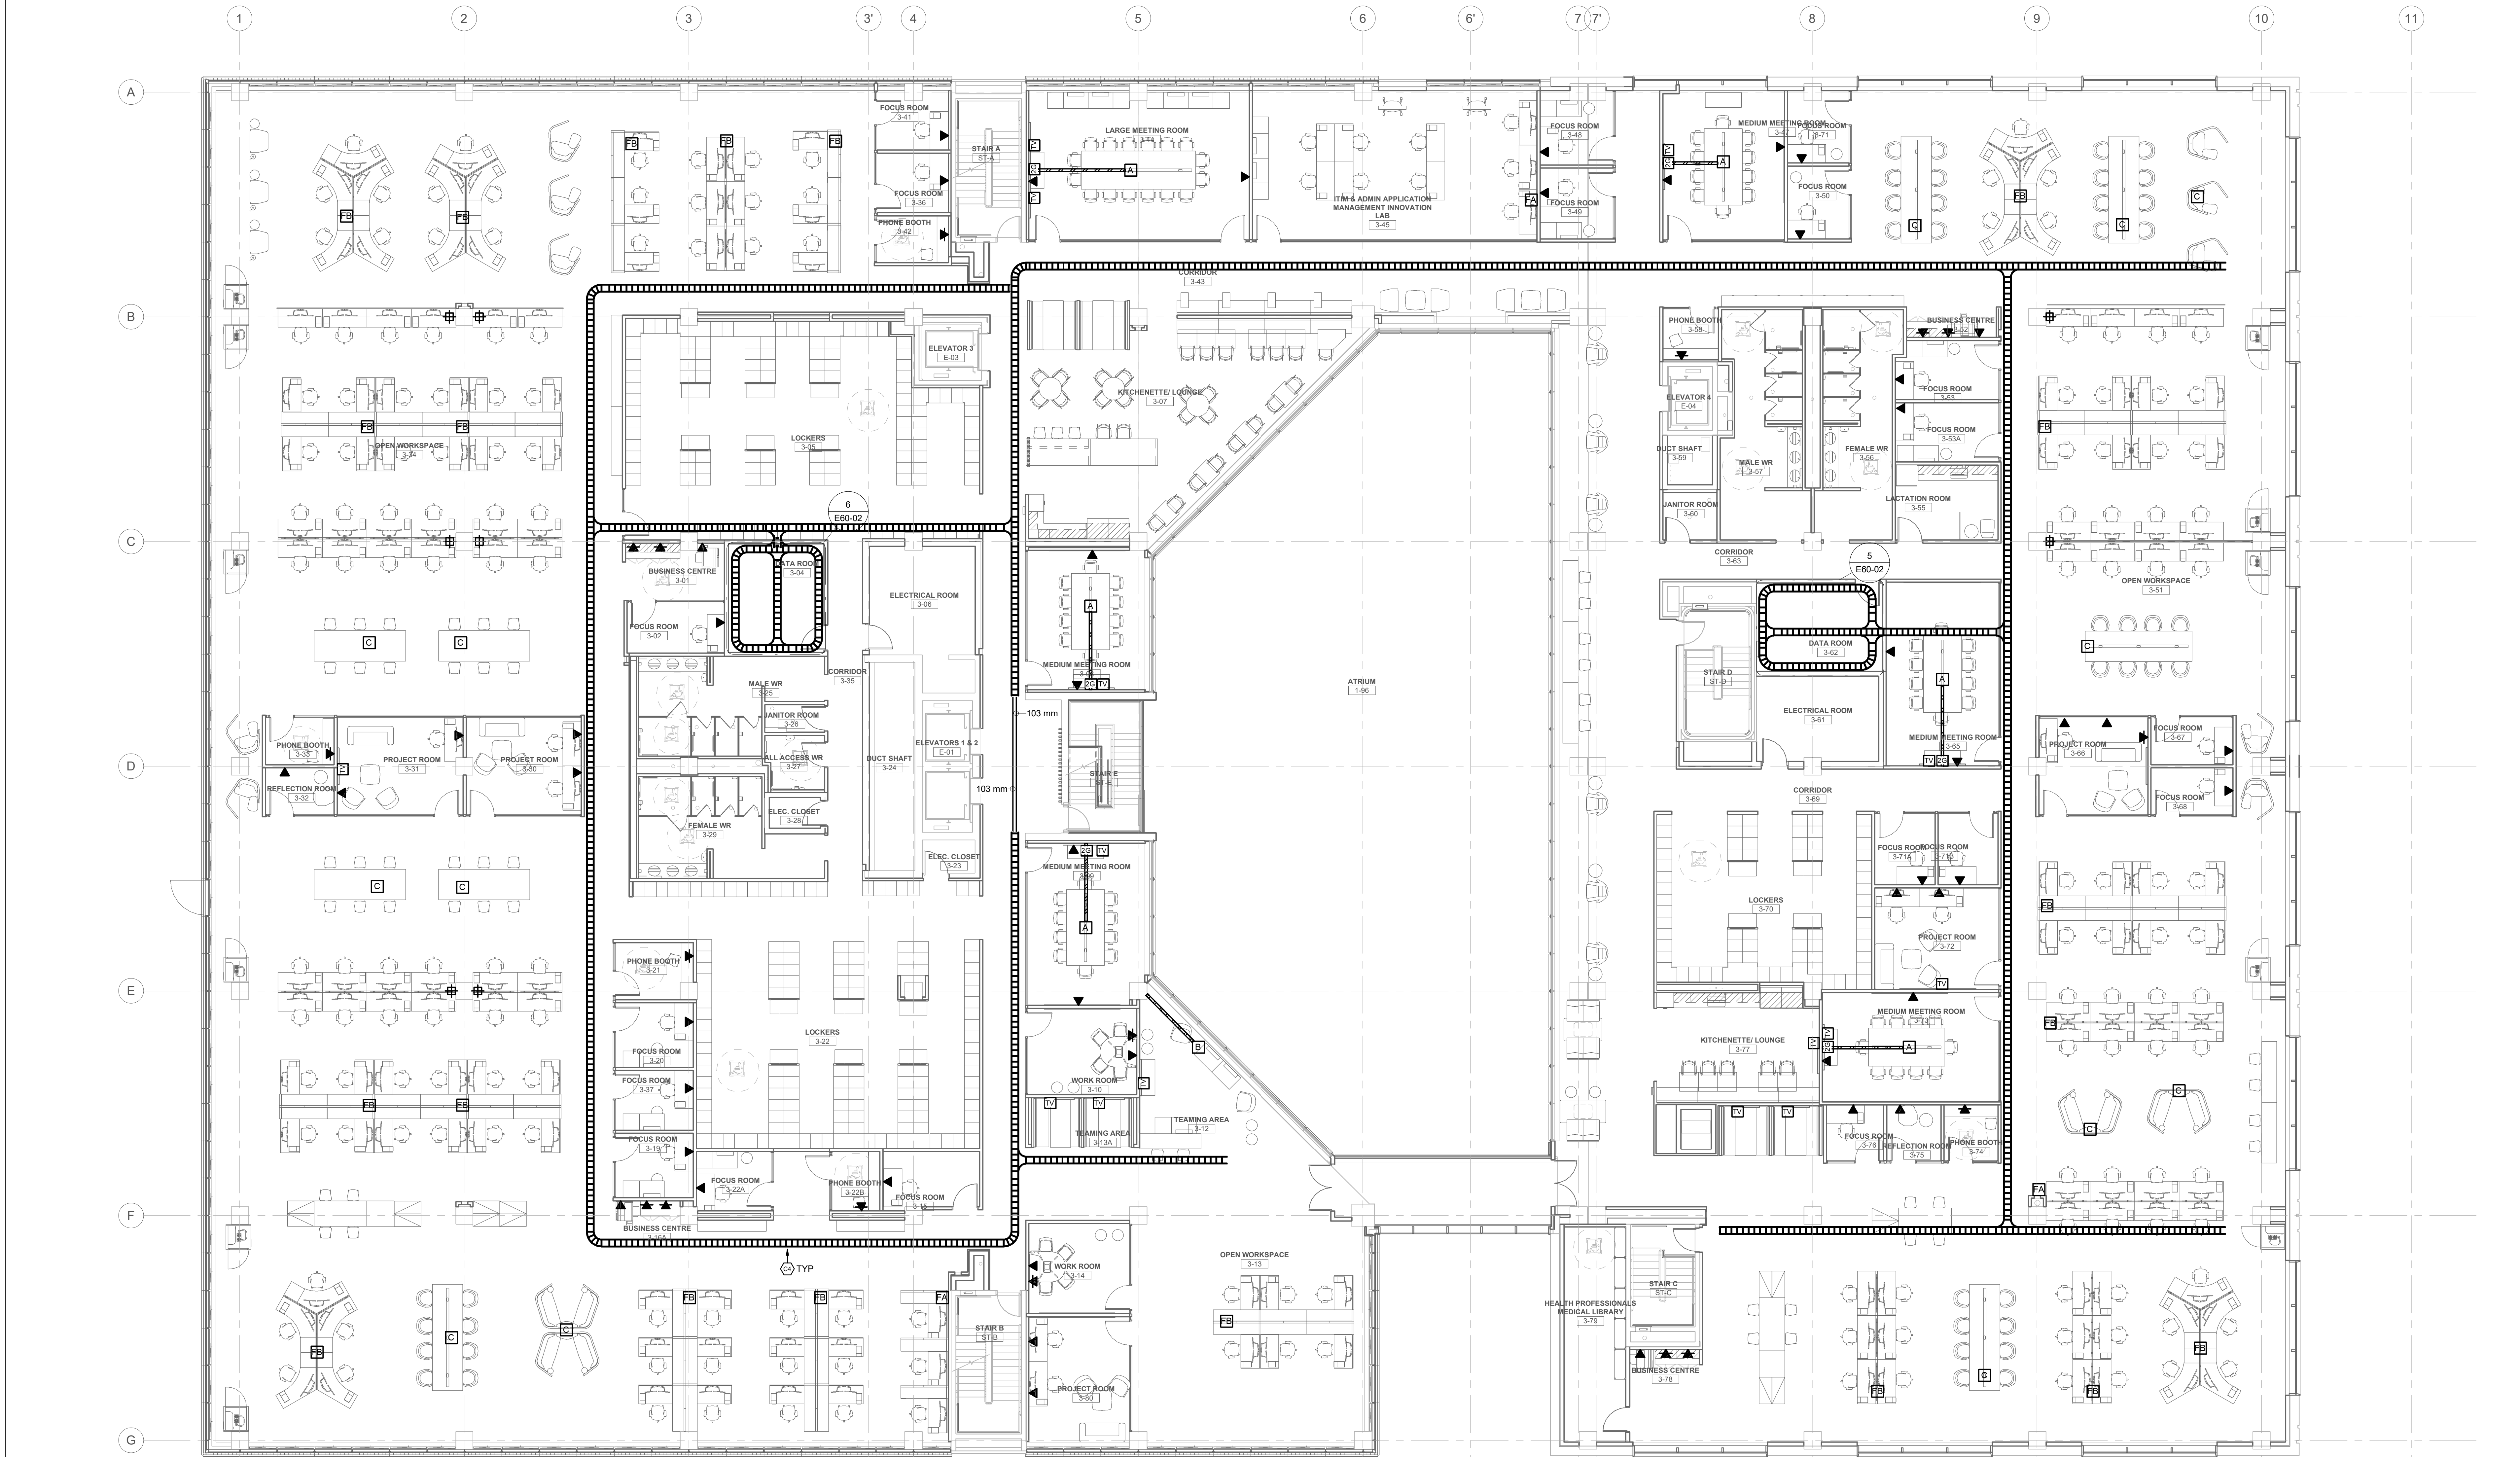

SCALE : 1:100
0m 1m 2m 3m 4m 5m 6m 7m 8m 9m 10m

GENERAL NOTES - COMMUNICATIONS

- A THESE DRAWINGS AND SPECIFICATIONS TO BE READ IN CONJUNCTION WITH ARCHITECTURAL, STRUCTURAL, INTERIOR DESIGNER'S, MECHANICAL, AND OTHER DIVISIONS DRAWINGS. ALL ELECTRICAL WORK SHALL COMPLY WITH OWNER'S REQUIREMENTS AND BASE BUILDING STANDARDS.
- B REFER TO COMMUNICATION RISER DIAGRAM FOR ALL CONDUIT SLEEVE QUANTITIES AND REQUIREMENTS.
- C COMMUNICATION (VOICE AND/OR DATA) SYSTEM CABLES AND COVERPLATES WITH CONNECTORS ARE NOT IN THIS CONTRACT AND WILL BE SUPPLIED AND INSTALLED BY OTHERS. UNLESS NOTED OTHERWISE, THIS CONTRACTOR TO PROVIDE SYSTEM OF EMPTY CONDUITS AND OUTLET BOXES: DOUBLE GANG BOX (101mm X 101mm X 54mm) COMPLETE WITH 27mm EMPTY CONDUIT WITH PULL WIRE SPECIFIED FOR EACH VOICE/DATA OUTLET TERMINATED AT THE COMMUNICATION CABLE TRAY.
- D COMMUNICATION TRAY TO BE WIRE BASKET TYPE, 100 MM (4") DEEP, WIDTH AS SHOWN ON THE DRAWINGS, AND COMPLETE WITH COUPLINGS, FITTINGS, BENDS, CONNECTORS, REDUCERS, COVER, ETC., AND ALL NECESSARY MOUNTING ACCESSORIES.

DRAWING KEYNOTES

- C4 COMMUNICATIONS CABLE TRAY TO BE MOUNTED 3000mm AFF. REFER TO DRAWING E03-04 FOR DETAILS AND SPECIFICATION FOR CLEARANCE REQUIREMENTS IN CEILING SPACE.