# NRC BUILDING M7 - CHILLER AND HEAT PUMP REPLACEMENTS

1200 MONTREAL ROAD, OTTAWA, ON. MECHANICAL

	GENERAL LEGEND
SYMBOL	DESCRIPTION
	EXISTING PIPING/DUCTWORK/EQUIPMENT
	EXISTING PIPING/DUCTWORK/EQUIPMENT TO BE REMOVED/RELOCATED
	NEW/RELOCATED PIPING/DUCTWORK/EQUIPMENT
	EXISTING PIPING/DUCTWORK/EQUIPMENT BELOW SLAB
	NEW PIPING/DUCTWORK/EQUIPMENT BELOW SLAB
(E)	DENOTES EXISTING EQUIPMENT
(R)	DENOTES RELOCATED EQUIPMENT
(N)	DENOTES NEW EQUIPMENT
(X)	DENOTES EQUIPMENT TO BE REMOVED
.,	

	DRAWING LIST
SYMBOL	DESCRIPTION
5988-M01	MECHANICAL - LEGENDS & SCHEDULES
5988-M02	MECHANICAL - DETAILS
5988-M03	MECHANICAL - CHILLER REPLACEMENT - DEMO & NEW WORK
5988-M04	MECHANICAL - CHILLER REPLACEMENT - SCHEMATICS
5988-M05	MECHANICAL - HEAT PUMP REPLACEMENTS - DEMO & NEW WORK
5988-M06	MECHANICAL - CONTROL VALVE REPLACEMENTS

	CONTROLS LEGEND
SYMBOL	DESCRIPTION
/***\	LOW VOLTAGE CONTROL WIRING
T	TEMPERATURE SENSOR

PL	UMBING & UTILITIES LEGEND
SYMBOL	DESCRIPTION
——CGS——	CHILLED GLYCOL SUPPLY PIPING
——CGR——	CHILLED GLYCOL RETURN PIPING
CHWS	CHILLED WATER SUPPLY
CHWR	CHILLED WATER RETURN
——CTS——	COOLING TOWER SUPPLY PIPING
——CTR——	COOLING TOWER RETURN PIPING
ρ <sup>τ</sup>	THERMOMETER
<b>⊘</b> PG	PRESSURE GAUGE C/W VALVE
X AAV	AUTOMATIC AIR VENT C/W VALVE
<del></del>	PIPING OFFSET
<del></del>	BRANCH PIPING DOWN
<b>—</b> ∋	PIPING DOWN
<u> </u>	PIPING UP
<b>→</b>	REDUCER
-	FLOW
Г	CAP
$\bowtie 3$	ISOLATION VALVES
×	PRESSURE REDUCING VALVE (PRV)
<b>₩</b> \$4	CIRCUIT BALANCING VALVE (CBV)
吳	2-WAY CONTROL VALVE (DDC)
虽	3-WAY CONTROL VALVE (DDC)
$\Rightarrow$	STRAINER
	CHECK VALVE
$\bowtie$	FLEXIBLE CONNECTION
ф	UNION
⊳≵	RELIEF VALVES
$\bowtie \!$	DRAIN VALVE C/W CAP & CHAIN
$\triangleright \bigcirc \!$	PUMP (P)

			CON	TROL \	VALVE S	SCHEDU	JLE	
EQUIPMENT	FLUID TYPE	VALVE TYPE	MAXIMUM FLUID FLOW (L/S)	VALVE SIZE (ØMM)	VALVE MAX FLUID PRESSURE DROP (FT.WC)	MAX SYSTEM PRESSURE (kPa)	CONTROL TYPE	VALVE FAILURE POSITION
07FCU01	CHW	2-WAY	0.95	40	5.75	1034	MODULATING	FAIL CLOSED
07FCU02	CHW	2-WAY	0.95	40	5.75	1034	MODULATING	FAIL CLOSED
07FCU03	CHW	2-WAY	0.36	25	5.75	1034	MODULATING	FAIL CLOSED
07FCU04	CHW	2-WAY	0.36	25	5.75	1034	MODULATING	FAIL CLOSED
07FCU05	CHW	2-WAY	1.0	40	5.75	1034	MODULATING	FAIL CLOSED
07FCU06	CHW	2-WAY	0.15	20	5.75	1034	MODULATING	FAIL CLOSED
07FCU07	CHW	2-WAY	0.15	20	5.75	1034	MODULATING	FAIL CLOSED
07AHU07	CHW	2-WAY	1.62	50	5.75	1034	MODULATING	FAIL CLOSED
07AHU05	CHW	2-WAY	0.67	50	5.75	1034	MODULATING	FAIL CLOSED
NOTES: 1.	FOR DETAIL	S REFER TO	SPECIFICATIONS	S.				

NOTES: 1. FOR DETAILS REFER TO SPECIFICATIONS.

			CHILLI	ED WATER	R BUFFER TANK	
UNIT NO.	VOLUME (L)	INLET SIZE (MM)	OUTLET SIZE (MM)	SHIPPING WEIGHT (KG)	BASIS OF DESIGN	REMARKS
07PVE04	568	75	75	232	TACO BTL0150F02-125N	* TOP VENT, BOTTOM DRAIN, 450°F MAX OPERATING TEMP, 125 PSI MAX WORKING PRESSURE.

		G	LYCOL	FEED	STAT	TON SCHE	DULE		
			FLUID	PUMP	DATA	ELECTRIC	CAL DATA		
TAG	LOCATION	SYSTEM	CAPACITY (L)	FLOW (L/S)	HEAD (kPa)	MOTOR SIZE (HP)	V/PH/Hz	BASIS OF DESIGN	REMARKS
07GLP01	GROUND FLOOR MECH ROOM	CHILLED GLYCOL	65	0.06	310	-	115/1/60	AXIOM DMF300	* C/W RIA10-1-SAA LOW LEVEL ALARM MONITORING PANEL

					<b>EXPANS</b>	ION TANK	SCHEDU	LE				
TAG	LOCATION	FUNCTION	TYPE	OPERATING	PRESSURE	OPERATING 1	remperature	TANK VOLUME	ACCEPTANCE	ORIENTATION (HORIZONTAL/	BASIS OF DESIGN	REMARKS
IAG	LOCATION	FUNCTION	(DIAPHRAGM/ BLADDER)	MIN (kPa)	MAX (kPa)	MIN (°C)	MAX (°C)	(L)	VOLUME (L)	VERTICAL)	BASIS OF DESIGN	KEMAKNO
07PVE05	GROUND FLOOR MECH RM	CHILLED GLYCOL	DIAPHRAGM	93	414	4.4	23.9	211	86	VERTICAL	BELL & GOSSETT - D-100V	* ASME - NON-POTABLE, 50% P.G.

								PUMP SC	HEDULE											
							Pl	UMP DATA					5. 5. 5. 5. 5.							
TAG	LOCATION	FUNCTION	TYPE		DUTY POIN	T #1			DUTY PO	NT #2		END SUCTION DIFFUSER (YES/NO)	ELECTRICAL DATA		ELECTRICAL DATA		ELECTRICAL DATA		BASIS OF DESIGN	REMARKS
				DESIGN FLOW (L/S)	DESIGN HEAD (kPa)	RPM	EFFICIENCY (%)	DESIGN FLOW (L/S)	DESIGN HEAD (kPa)	RPM	EFFICIENCY (%)	(123/110)	MOTOR SIZE (HP)	V/PH/Hz						
07CWP01	GROUND FLOOR MECH ROOM	CHILLED WATER CIRC	INLINE CENTRIFUGAL	6.31	225	1765	56.49	5.55	225	1800	55.1	Y	5	575/3/60	ARMSTRONG 4380 2x2x10	C/W REMOTE MOUNT VFD				
07CWP02	GROUND FLOOR MECH ROOM	CHILLED WATER CIRC	INLINE CENTRIFUGAL	6.31	225	1765	56.49	5.55	225	1800	55.1	Y	5	575/3/60	ARMSTRONG 4380 2x2x10	C/W REMOTE MOUNT VFD				

								HEAT EX	XCHANGE	R SCHEDU	LE							
		CAPACITY		HEAT EXCHANGER				PRIMARY PASS	;				SECONDARY PAS	S		NOMINAL SIZE		
TAG	FUNCTION	(BTUH)	TYPE	SURFACE AREA (sq. M)	DUTY POINT	INLET TEMP	OUTLET TEMP	FLOW (L/S)	FLUID TYPE	PD (kPa)	INLET TEMP (*C)	OUTLET TEMP	FLOW (L/S)	FLUID TYPE	PD (kPa)	(mmH x mmL x mmW)	BASIS OF DESIGN	
07115701	CHILLED WATER	441,191	DDA7ED DLATE	38.74	1	5.56	11.11	6.23	50% PG	73.23	12.10	7.22	6.31	WATER	39.99	685 x 490 x 255	NO 10170 200MPD 25	
07HEX01	CHILLED WATER	441,191	BRAZED PLATE	38.74	2	5.56	11.11	6.23	1 50% PG	73.08	12.78	7.22	5.55	WATER	31.68	1 680 X 490 X 200	AIC LC170-200MBR-2P	

													CHILLI	ER SCH	IEDULE												
		CHILLER					EVAPORATOR			EER (BTU/W.h)	IPLV.IP (BTU/W.h)	ELECTR	ICAL	STAGE	AMBIENT (°C)				SOUND	POWER LEVE	ELS (dB)				PAR	T LOAD RATING [	)ATA
UNIT NO.	LOCATION	SYSTEM	CAPACITY (TONS)	WEIGHT (KG)	FLOW (L/S)	PD (kPa)	EWT (°C)	LWT (°C)	FLUID	(210))		V/PH/Hz	MCA			63	125	250	500	1000	2000	4000	8000	LWA	CAPACITY (TON.R)	TOTAL KW	EFFICIENCY (BTU/W.H)
														1	35	96	95	92	92	88	84	81	79	93	36.74	40.24	10.96
7001101	ROOF	CHILLED	76 74	2484	6 10	EO 49	11 11	F F C	E0% D0	10.06	10 56	575 /3 /60	75	2	28.83	94	93	90	90	86	82	79	77	91	29.89	24.88	14.41
7CCH01	ROOF	WATER	36.74	2484	6.18	59.48	11.11	5.56	50% PG	10.96	18.56	575/3/60	75	3	21.67	90	88	85	85	81	77	74	73	87	21.97	14.25	18.50
														4	12.78	8785	8	2	82	78	74	71	70	84	11.31	6.557	20.69

										CHI	ILLER S	CHEDUL	E, CONT'D				
			HYDF	OKIT							ECONOM	IZER DATA					
FLOW (L/S)	HEAD (kPa)	PUMP QTY.	MOTOR HP	MOTOR RPM	HYDROKIT REMARKS	CAPACITY (KW)	PD (kPa)	FLOW (L/S)	EWT (°C)	LWT (°C)	EAT (°C)	COMBINED PD (kPa)	COMBINED FLUID VOLUME (L)	ACCESSORIES	BASIS OF DESIGN	REMARKS	
6.18	279.8	1	5	2940	SERIES 4380 DESIGN ENVELOPE PUMP C/W VSD	129.21	144	6.18	11.11	5.56	2.33	207.73	118	C/W 3-WAY ON/OFF CONTROL VALVE, BALANCING VALVE, LOOP ISOLATION VALVE, BACNET COMPATIBLE CONTROLS	YORK YLAA0041HE58XCBSXTQ	* C/W HYDRO KIT PUMP PACKAGE, ECONOMIZER COILS AND ASSOCIAT CONTROLS AND ACCESSORIES. R410A REFRIGERANT	

													HE	EAT PL	IMP SC	CHEDU	JLE							
								COOLIN	NG						HEA	TING			WATER		ELECTRICAL I	DATA		
TAG	LOCATION	TYPE	AIR FLOW (L/S)	ESP (Pa)	SENSIBLE (KW)	TOTAL (BTUH)	EAT (DB/WB)(*F)	LAT (°F)	EWT (°F)	PD (kPa)	HEAT REJECTION (BTUH)	EER	CAPACITY (KW)	EAT (°C)	LAT (°C)	EWT (°C)	PD (kPa)	HEAT EXTRACTION (KW)	FLOW (L/S)	MOTOR HP	FLA/MCA	V/PH/Hz	BASIS OF DESIGN	REMARKS
07HEP01	TRIBOLOGY LAB G31B	HEAT PUMP	823	132	13.17	19.17	26.67/19.44	13.44	29.44	10.16	23.65	14.6	23.79	21.11	45.0	29.44	10.16	18.93	0.5	1	24.1/28.2	208-230/3/60		* LEFT DISCHARGE, RIGHT RETURN, FILTER RACK, OPTIONAL CONTROLLER FOR CONNECTION TO BAS
07HEP02	TRIBOLOGY LAB G31C	HEAT PUMP	696	190	9.8	14.5	26.67/19.44	15.0	29.44	5.38	18.1	13.9	18.57	21.11	43.2	29.44	5.38	14.77	0.38	0.5	20/24	208-230/3/60		* LEFT DISCHARGE, RIGHT RETURN, FILTER RACK, OPTIONAL CONTROLLER FOR CONNECTION TO BAS
07HEP03	TRIBOLOGY LAB G31D	HEAT PUMP	823	132	13.17	19.17	26.67/19.44	13.44	29.44	10.16	23.65	14.6	23.79	21.11	45.0	29.44	10.16	18.93	0.5	1	24.1/28.2	208-230/3/60		* LEFT DISCHARGE, RIGHT RETURN, FILTER RACK, OPTIONAL CONTROLLER FOR CONNECTION TO BAS

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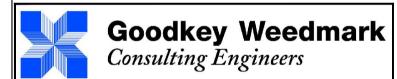
Planning Planification et gestion



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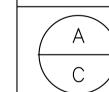


GOODKEY WEEDMARK & ASSOCIATES LIMITED

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1	2022-01-25	ISSUED FOR TENDER
-	2021-12-15	ISSUED FOR 100% REVIEW
-	2021-11-17	ISSUED FOR 99% REVIEW
-	2021-10-13	ISSUED FOR 66% REVIEW
-	2021-08-27	ISSUED FOR 33% REVIEW
No.	Date	Revision

- Verify all dimensions and site conditions and be responsible for same
- o Vérifier toutes les dimensions et l'etat des liéux et en assumer la responsabilité



A Detail no.

No. du détail

B Location drawing no.

sur dessin no.

sur dessin no.
C Drawing no.
dessin no.

M7 CHILLER AND HEAT PUMP REPLACEMENTS


MONTREAL ROAD CAMPUS

MECHANICAL LEGENDS AND SCHEDULES


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	K.N.			-	
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	K.N.			AS NOTED	
checked		vérifié	sheet		feuille
	R.L.			of/de _	
approved		approuvé	W.O.no.		D.T.no
	R.L.			_	
			I		

<sup>9.no.</sup> 5988-M01


0 10 20mm 40 60 90 100 120 140 160 190 200

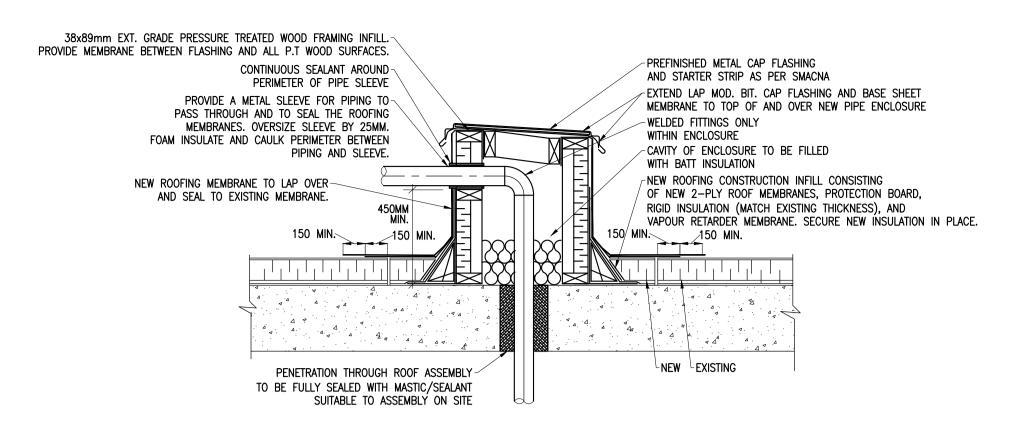


ROOFTOP PIPE PENETRATION ENCLOSURE DETAIL M02 N.T.S.

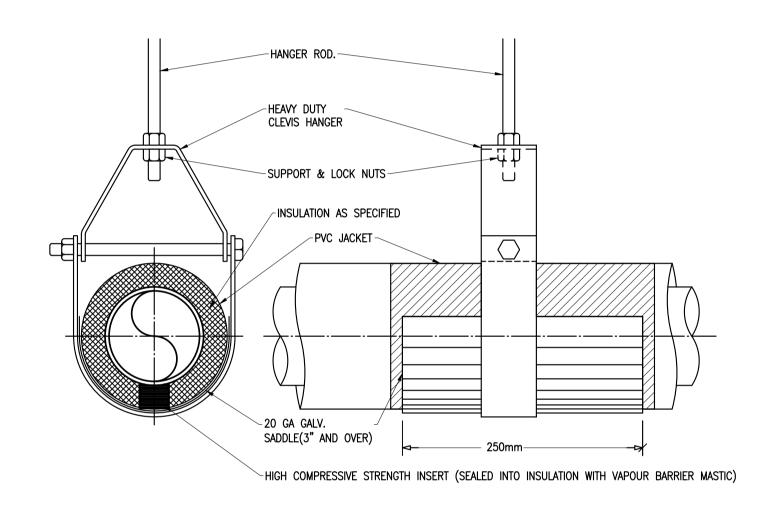



CHILLED WATER - PIPE HANGAR DETAIL

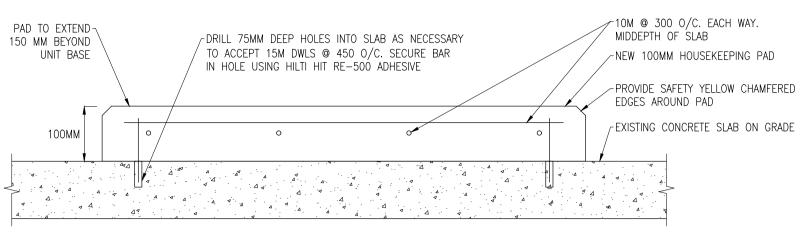



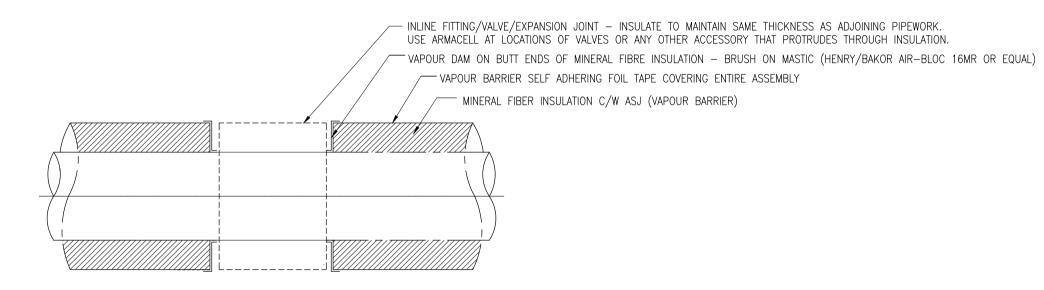

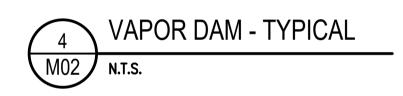

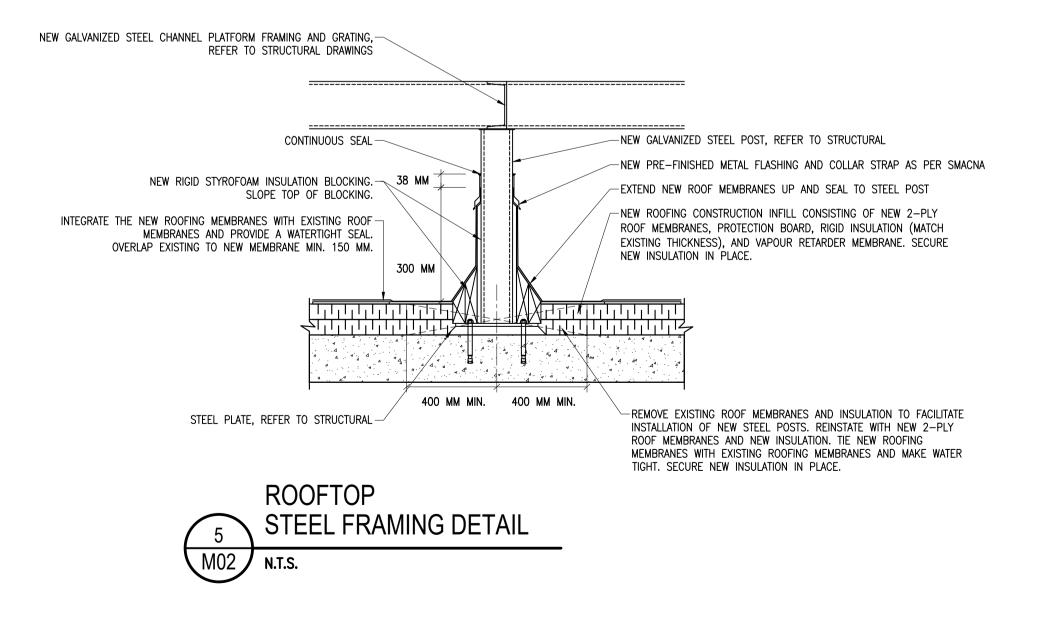

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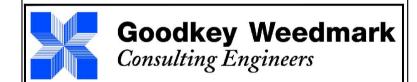
Conseil national de recherches Canada



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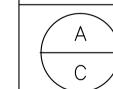





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A Detail no. No. du détail B Location drawing no. sur dessin no.



dessin no.

M7 CHILLER AND HEAT PUMP REPLACEMENTS


MONTREAL ROAD CAMPUS

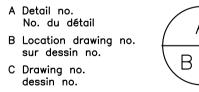MECHANICAL **DETAILS** 

K.N. **AS NOTED** vérifié sheet checked of/de \_ approuvé | W.O.no. D.T.no.


5988-M02

ASPM A1 (841x594)

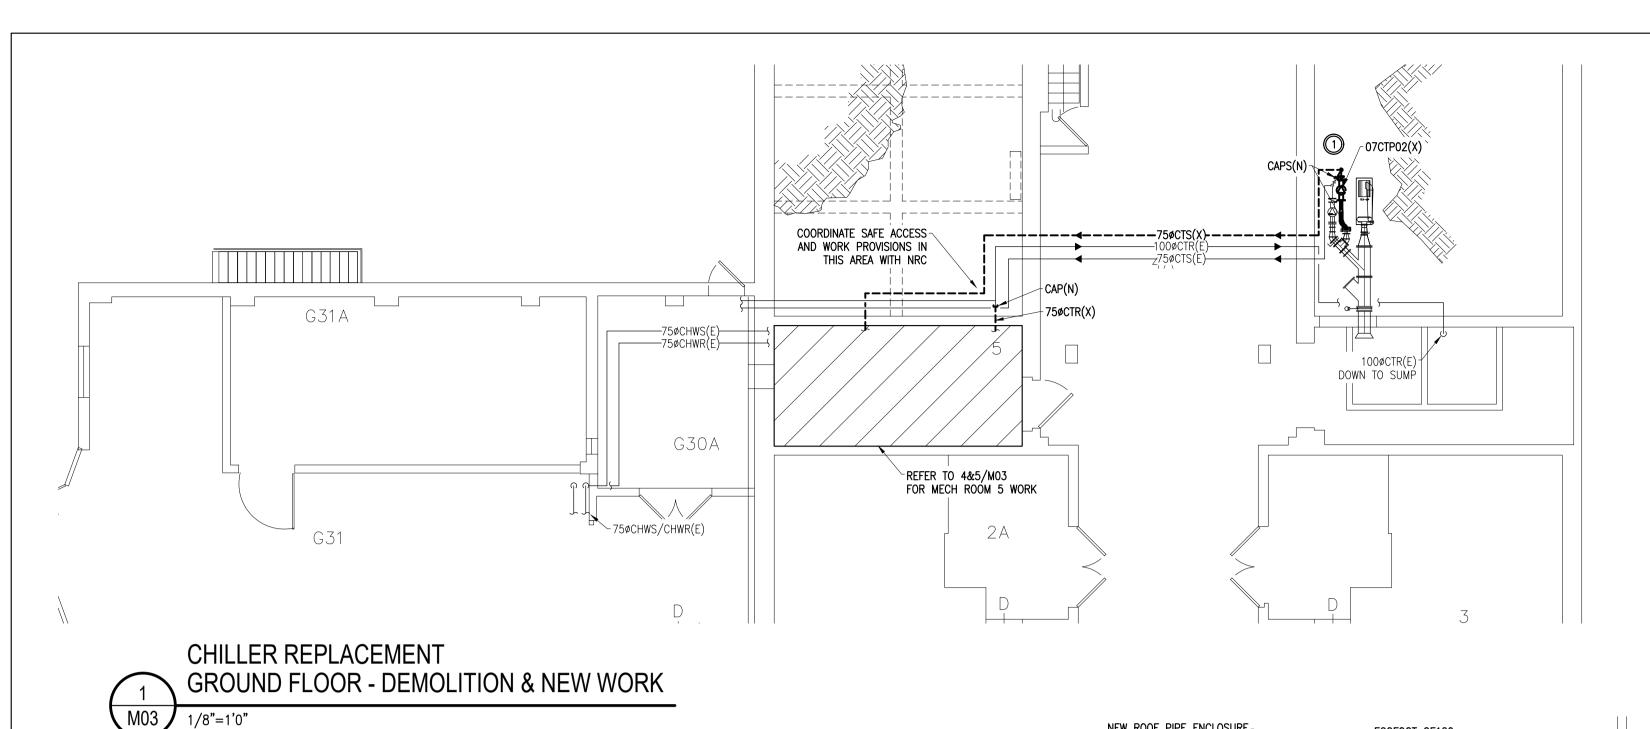

#### ALLOW FOR SCANNING/CORING OF ROUTE PIPING ALONG WALL TO AVOID-EXISTING FOUNDATION WALL FROM WITHIN INTERFERENCE WITH MOVEABLE CRAWLSPACE TO LOW LEVEL IN ADJACENT MECHANICAL ROOM CRANES IN THIS AREA G31A √ 75øCHWS/R UP TO ROOF **┌───**∙75øCHWS(N)**───**├**┴**┴ RUN PIPING EXPOSED -OVER LAB G31A ON PIPE STANDS FASTENED PIPING TO BE RAN+ REFER TO 5/MO3 ✓ TO CONCRETE SLAB FOR CONTINUATION WITHIN CRAWLSPACE BELOW ROOM G30A 75øCHWS/R∼ **5** G30A DN TO SUB-BASEMENT ·----<del>-</del>--------G31 **COORDINATE PIPE ROUTING-**AROUND EXISTING DUCTWORK AND SERVICES IN SUB-BASEMENT



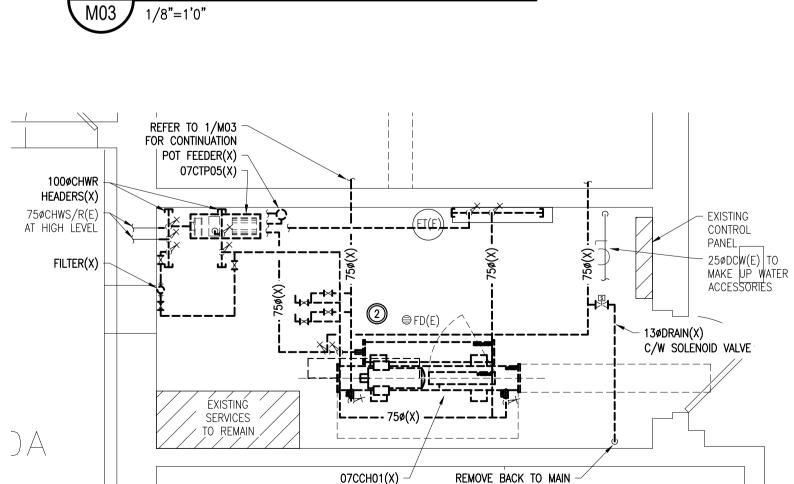


AND CAP


CHILLER REPLACEMENT **GROUND FLOOR - MECH ROOM DEMO WORK** M03 1/4"=1'0"

MCQUAY WATER COOLED CHILLÈR

MODEL# WHR030EW37-ER10

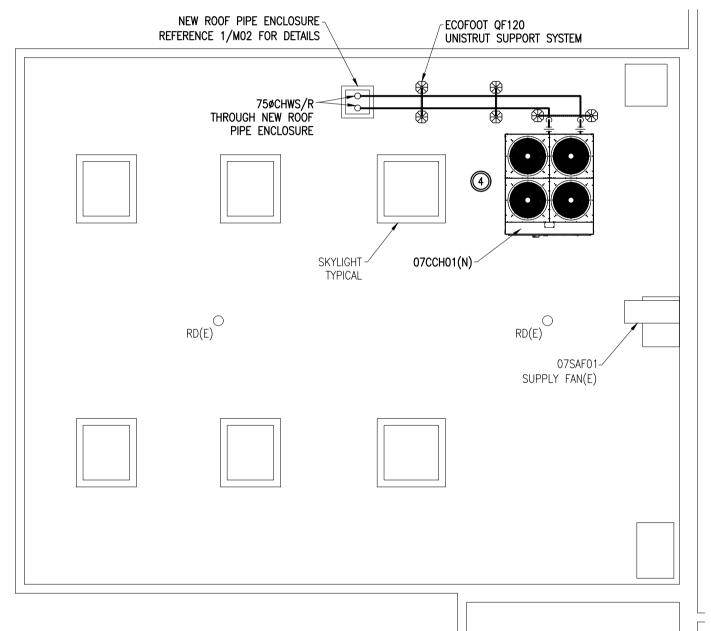

CHILLER REPLACEMENT **ROOF - NEW WORK** 

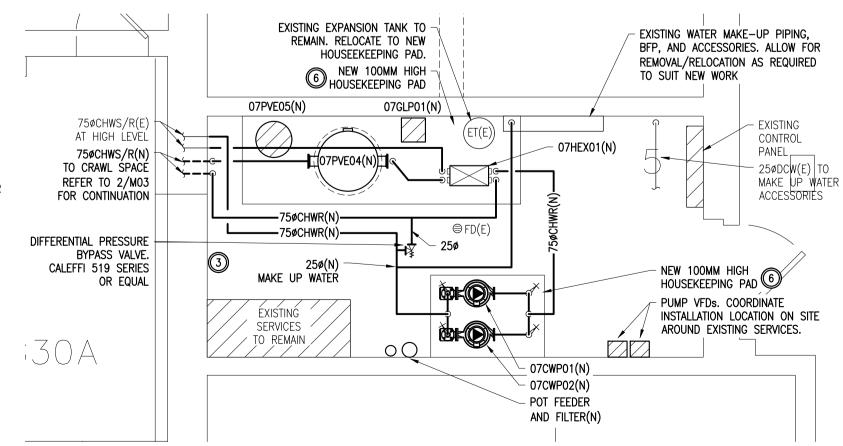

CHILLER REPLACEMENT GROUND FLOOR - MECH ROOM NEW WORK M03 1/4"=1'0"

#### DESCRIPTION OF WORK

- REMOVE EXISTING CONDENSER WATER PUMP (CTP02) AS INDICATED C/W ASSOCIATED PIPING AND ACCESSORIES. CAP WHERE INDICATED. ENSURE SAFE WORK PRACTICES ARE FOLLOWED WHILE CARRYING OUT REMOVAL OF PUMP PIPING AND ACCESSORIES.
- 2 REMOVE EXISTING CHILLER AND CHILLED WATER CIRC PUMP AS INDICATED C/W ASSOCIATED PIPING, CONTROLS, AND ACCESSORIES SERVING CHILLER/CHILLED WATER SYSTEM LOCATED IN MECH ROOM THAT DO NOT ALSO SERVE EXISTING SYSTEMS TO REMAIN.
- (3) PROVIDE NEW CHILLED WATER PUMPS, HEAT EXCHANGER, BUFFER TANK, GLYCOL FEED STATION, AND EXPANSION TANK AS INDICATED C/W ALL ASSOCIATED PIPING AND ACCESSORIES. REFERENCE CHILLED WATER SCHEMATIC ON DRAWING MO3 FOR SYSTEM PIPING AND ACCESSORY DETAILS.
- PROVIDE NEW CHILLER ON ROOF IN LOCATION INDICATED C/W ASSOCIATED PIPING AND ACCESSORIES. COORDINATE EXACT PLACEMENT AND PIPE ROUTING TO ROOF AROUND EXISTING EQUIPMENT AND TO RESPECT MANUFACTURERS RECOMMENDED CLEARANCE REQUIREMENTS. REFERENCE STRUCTURAL DRAWINGS FOR CHILLER PLATFORM/FRAMING REQUIREMENTS AND DETAILS. REFERENCE 1/M02 FOR NEW ROOFTOP PIPE ENCLOSURE DETAILS. PROVIDE NEW INSULATION AND JACKETING ON INTEGRAL CHILLER PIPING AND PUMP PACKAGE.
- 8 ROUTE CHILLED WATER PIPING TO NEW CHILLER THROUGH SUB-BASEMENT ALONG APPROXIMATE ROUTING SHOWN. ENSURE SAFE WORK PRACTICES ARE FOLLOWED WHEN ROUTING PIPING THROUGH CRAWLSPACE BELOW COMPRESSOR ROOM G30A. ROUTE PIPING UP FROM SUB-BASEMENT AND OVER LAB G31A UP TO NEW ROOF PIPE PENETRATION ENCLOSURE. COORDINATE EXACT ROUTING ON SITE AND ALLOW FOR OFFSETS AS REQUIRED TO AVOID INTERFERENCE WITH EXISTING SERVICES.
- © PROVIDE NEW 100MM HIGH HOUSEKEEPING PADS AND REPAIR OF EXISTING MECH ROOM CONCRETE FLOOR FOLLOWING REMOVALS. REFERENCE DETAIL 2/M02 FOR TYPICAL HOUSEKEEPING PAD DETAILS. PROVIDE SLAB PREPARATION, AND NEW GREY EPOXY FLOOR FINISH TO MEET NRC REQUIREMENTS. ACCEPTABLE MATERIAL: STONEHARD STONKOTE GS4, HT PRIMER OR APPROVED EQUIVALENT.

#### DESCRIPTION OF WORK CHILLED WATER SYSTEM FLUSHING & CLEANING

THE CONTRACTOR SHALL:

- 1. PRIOR TO COMMENCING WORK: CALL A PRELIMINARY CONSTRUCTION MEETING IN WHICH HE/SHE WILL OUTLINE THE CONSTRUCTION SCHEDULES. DATES ARE NOT TO BE CHANGED WITHOUT NOTIFICATION AND ACCEPTANCE FROM NRC. CARRY THE COST AND COORDINATE THE SERVICES OF A SPECIALIZED WATER TREATMENT COMPANY TO PROVIDE CHILLED WATER SYSTEM WATER CONDITION AND CHEMICAL ANALYSIS.
- \*\*IT IS IMPERATIVE THIS IS DONE BEFORE THE SYSTEM IS DRAINED\*\*

PROVIDE TEST RESULTS TO NRC DEPARTMENTAL REPRESENTATIVE AS SOON AS THEY ARE AVAILABLE.

- 2. AFTER WATER QUALITY ANALYSIS TESTS HAVE BEEN PERFORMED. DRAIN THE ENTIRE CHILLED WATER SYSTEM TO PERFORM VALVE REPLACEMENTS AS INDICATED ON DRAWING M05.
- 3. PROVIDE A COMPLETE CHILLED WATER SYSTEM CHEMICAL FLUSH. ALL PARTS OF THE SYSTEM NEED TO BE OPEN/BYPASSED FOR THIS PROCEDURE. FILL AND FLUSH UNTIL THE WATER QUALITY IS WITHIN BEST OPERATIONAL PARAMETERS FOR A CHILLED WATER SYSTEM. FOLLOWING THE FLUSHING, CHILLED WATER SYSTEM TO BE FILLED WITH FRESH WATER AND CHEMICALLY TREATED. CONTRACTOR TO EMPLOY THE SERVICES OF A SPECIALIZED WATER TREATMENT COMPANY FOR THESE OPERATIONS. A REPORT ON WATER CONDITION AND CHEMICAL ANALYSIS AFTER TREATMENT TO BE FORWARDED TO NRC DEPARTMENTAL REPRESENTATIVE IMMEDIATELY AFTER THE RESULTS ARE AVAILABLE.

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Conseil national

des biens immobiliers

NRC - CNRC

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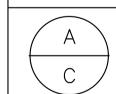




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A Detail no. No. du détail B Location drawing no.

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dessin no.

M7 CHILLER AND HEAT PUMP REPLACEMENTS


MONTREAL ROAD CAMPUS


**MECHANICAL** CHILLER REPLACEMENT DEMOLITION AND NEW WORK

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	K.N.			AS NOTED	
checked		vérifié	sheet		feuille
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approved		approuvé	W.O.no.		D.T.no.
	R.L.			_	

5988-M03

ASPM A1 (841x594)

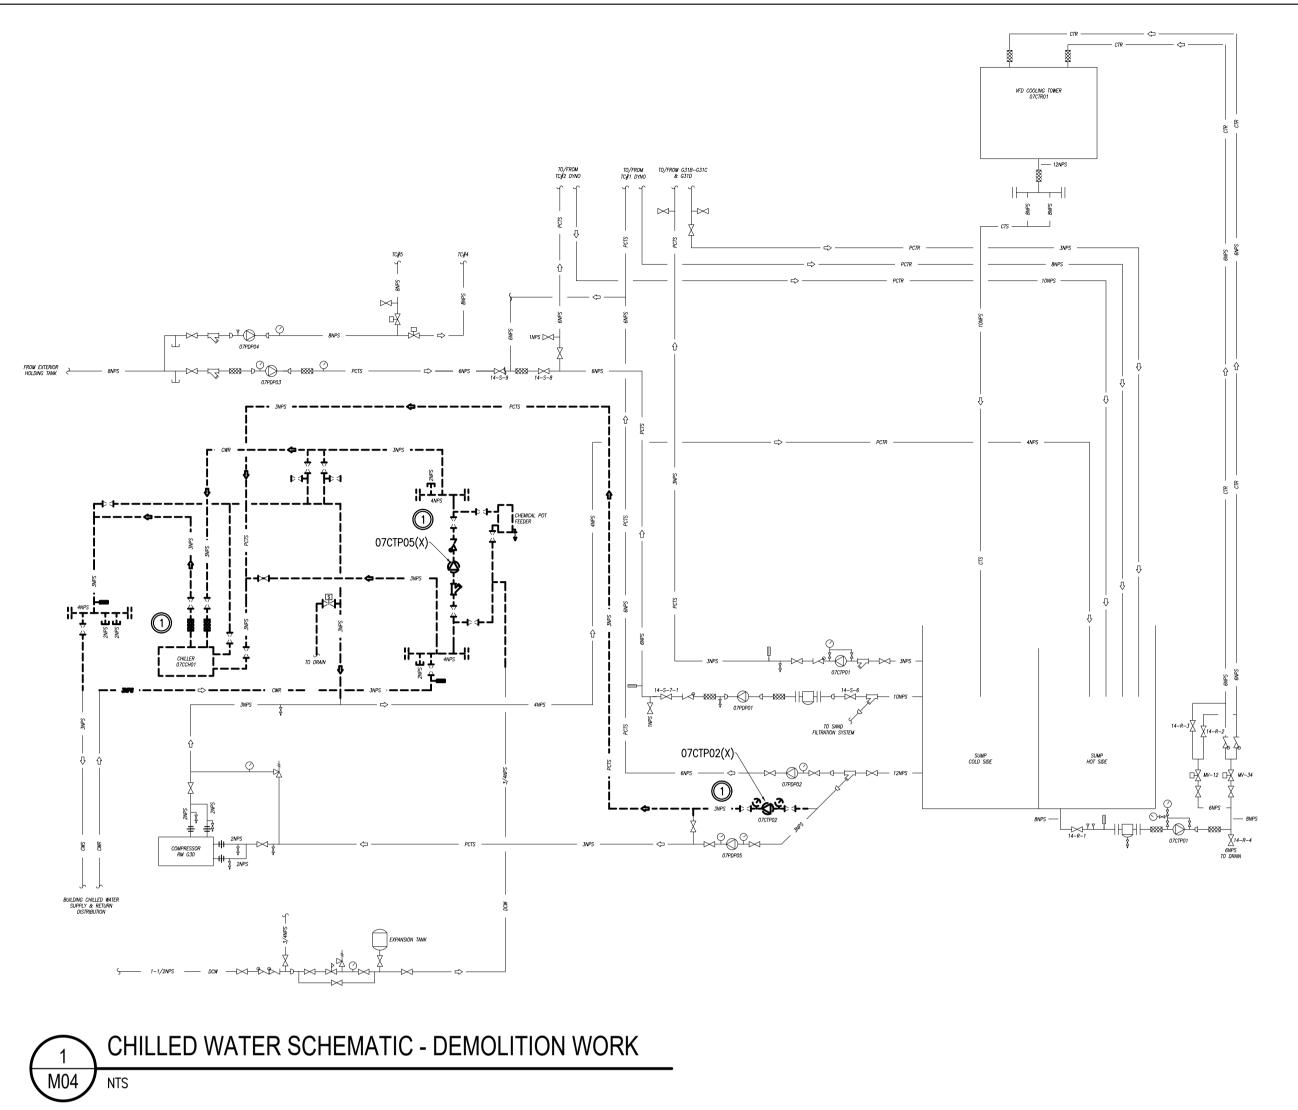

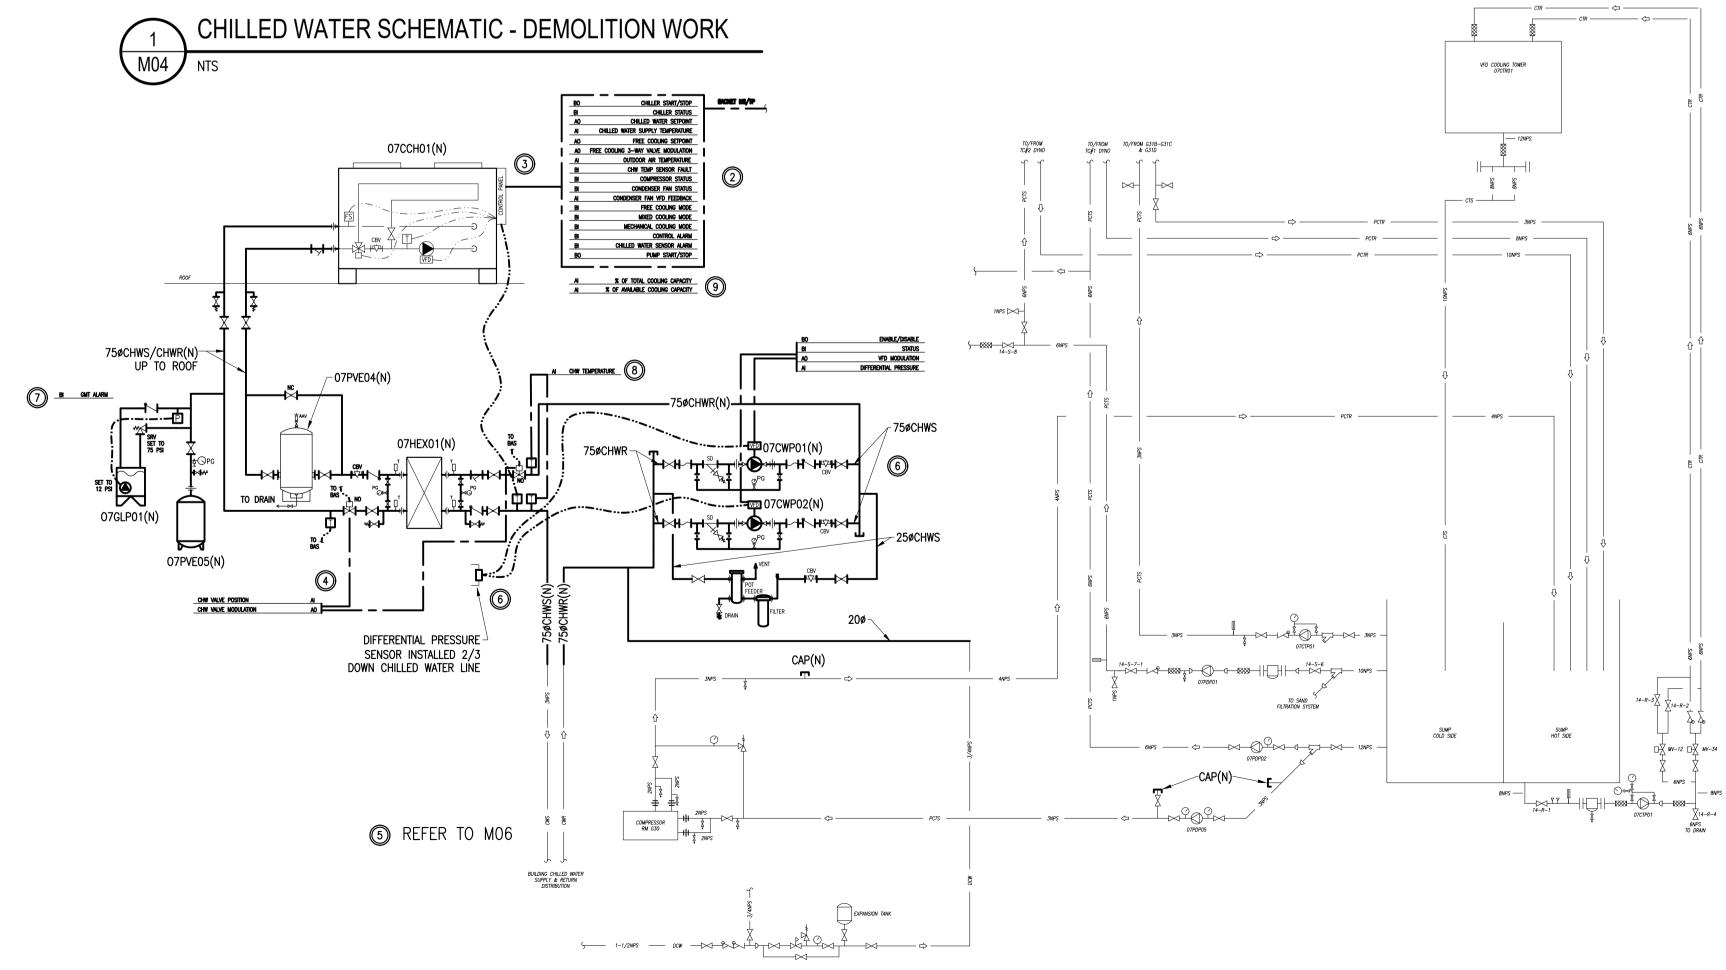

CHILLED WATER SCHEMATIC - NEW WORK

ASPM A1 (841x594)

## CONTROLS NOTES

- REMOVE EXISTING CONTROLS ASSOCIATED WITH REMOVED EQUIPMENT AND UPDATE GRAPHICS.
- ② 07CCH01(N) TO BE SUPPLIED WITH PACKAGED CONTROLLER WITH BACNET INTEGRATION. BAS TO MONITOR OPERATION THROUGH BACNET MAPPING. PACKAGED CONTROLLER TO PROVIDE ALL CONTROL FEATURES, DEVICES, SAFETIES, PROGRAMMING, AND COMMISSIONING TO MAINTAIN CHILLED WATER SUPPLY TEMPERATURE, LIMIT CYCLING, AND MAXIMIZE USE OF FREE COOLING. ON BOARD CONTROLLER TO MODULATE CHILLER CAPACITY AND PUMP SPEED TO OPTIMIZE SYSTEM EFFICIENCY AND LIMIT CYCLING.
- 3 PROVIDE ALL FIELD WIRING, CONDUIT, AND COORDINATION TO ACCOMMODATE PACKAGED CONTROLS FROM CHILLER MANUFACTURER
- PROVIDE TWO-WAY FLOW ISOLATION CONTROL VALVES (FULL PORT NORMALLY OPEN) ON EITHER SIDE OF HEAT EXCHANGER C/W BAS CONTROL AS PER NRC REQUEST. PROVIDE INTERLOCK TO SHUTDOWN CHILLER AND/OR ASSOCIATED PUMPS ON VALVE CLOSURE.
- © PROVIDE NEW CONTROL VALVES AND ASSOCIATED WIRING AND ACCESSORIES TO ACCOMMODATE REPLACEMENT OF EXISTING 3-WAY VALVES WITH 2-WAY VALVES AS INDICATED ON MO6.
- (6) PROVIDE NEW CHILLED WATER PRESSURE DIFFERENTIAL SENSOR AND VARIABLE SPEED CONTROL OF NEW PUMPS AS INDICATED. PROVIDE DUTY STANDBY PUMP OPERATION AND DUTY CYCLING BASED ON RUNTIME.
- 7 PROVIDE ALARM MONITORING ON NEW GLYCOL MAKEUP
- PROVIDE CHILLED WATER SUPPLY AND CHILLED WATER RETURN TEMPERATURE MONITORING.
- PROVIDE ALGORITHM TO PROVIDE BAS READOUT TO VISUALIZE CHILLER OPERATION AS PERCENT OF TOTAL AVAILABLE COOLING CAPACITY.
- PROVIDE RELOCATION OF EXISTING CONTROLS AND RELATED ACCESSORIES ASSOCIATED WITH HEAT PUMP REPLACEMENTS AS SHOWN ON MO5.

ALL DDC WORK TO BE CARRIED OUT BY AINSWORTH CANADA.

CONTACT: AARON DOBSON (613) 247-7938 AARON.DOBSON@AINSWORTH.COM

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Planification et gestion des biens immobiliers

## NRC - CNRC

GENERAL NOTES

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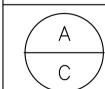
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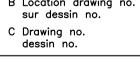
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Revision

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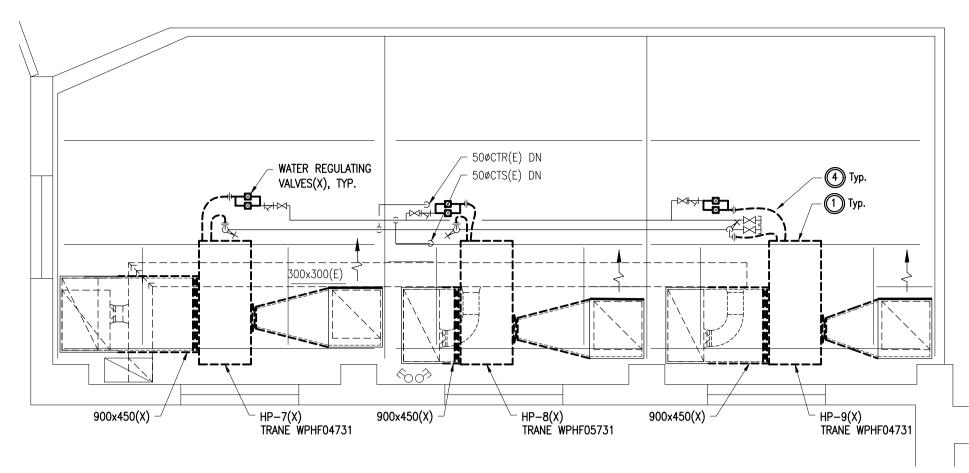
M7 CHILLER AND HEAT PUMP REPLACEMENTS

MONTREAL ROAD CAMPUS


MECHANICAL CHILLER REPLACEMENT SCHEMATICS

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5988-M04




TRIBOLOGY LAB HEAT PUMP REPLACEMENTS - DEMOLITION WORK M05 1/4"=1'0"

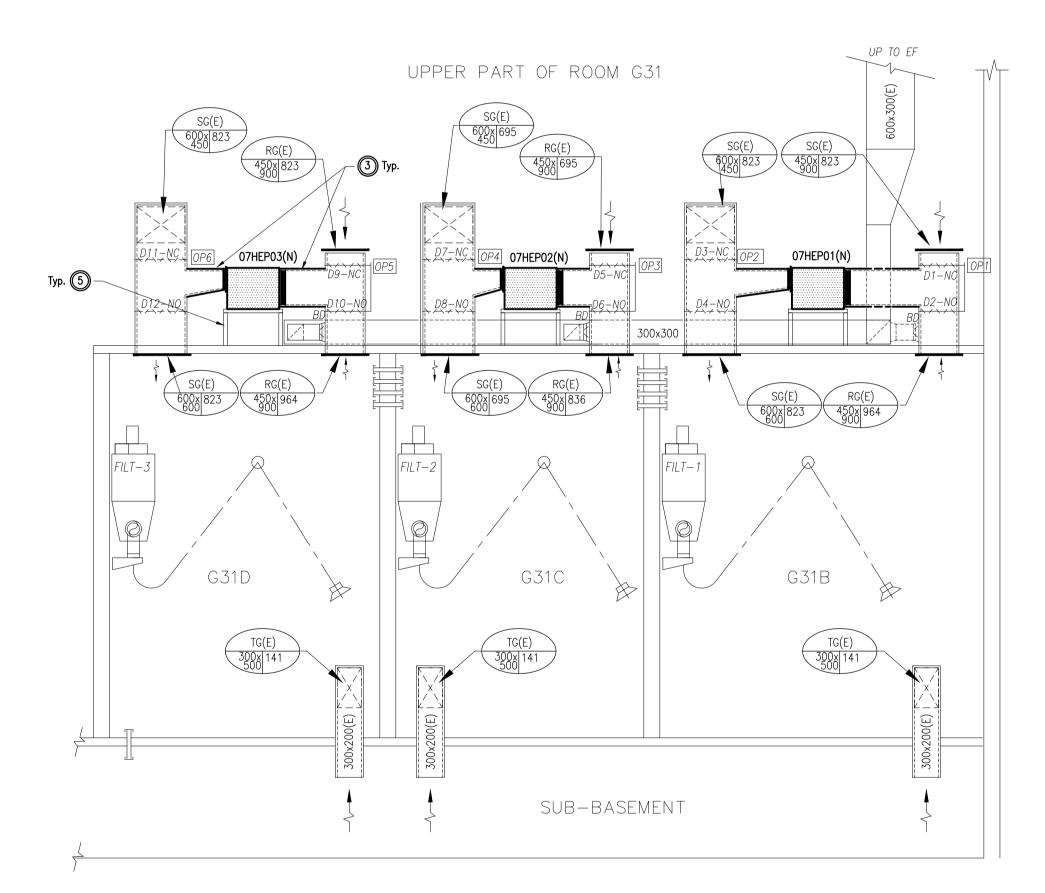

TRIBOLOGY LAB HEAT PUMP REPLACEMENTS - SECTION VIEW M05 NTS

ASPM A1 (841x594)

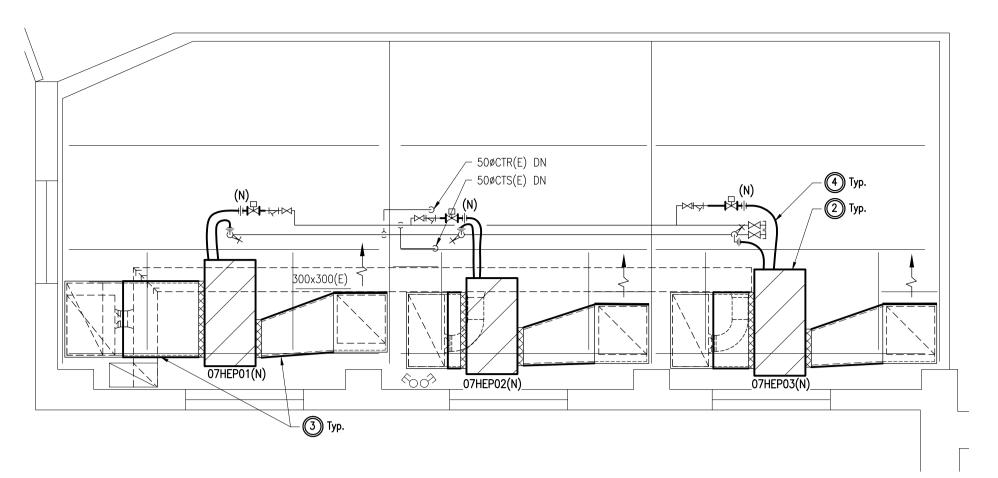

TRIBOLOGY LAB HEAT PUMP REPLACEMENTS - NEW WORK 1/4"=1'0"

DESCRIPTION OF WORK

- REMOVE EXISTING HEAT PUMPS AS INDICATED C/W ASSOCIATED DUCTWORK, PIPING, CONTROLS. & ACCESSORIES.
- ② PROVIDE NEW HEAT PUMPS AS INDICATED C/W ASSOCIATED ACCESSORIES.
- 3 PROVIDE NEW DUCT TRANSITIONS FROM NEW HEAT PUMP SUPPLY/RETURN OUTLETS AS REQUIRED TO CONNECT BACK TO EXISTING VERTICAL SUPPLY AND RETURN PLENUM OPENINGS C/W NEW FLEXIBLE CONNECTIONS, FILTER RACK, AND ACCESSORIES. BALANCE AIRFLOWS AS INDICATED IN 3/M05. EXISTING BALANCING/OPERATING DAMPERS, CONTROLS, DUCT TEMP SENSORS, AND OTHER CONTROLS ACCESSORIES ARE TO REMAIN AND BE REUSED. REMOVE/RELOCATE CONTROLS ACCESSORIES AS REQUIRED TO SUIT NEW UNIT/DUCT CONFIGURATION.
- REMOVE EXISTING FLEXIBLE PIPE CONNECTIONS AND PROVIDE NEW TO CONNECT BACK TO NEW HEAT PUMPS. PROVIDE ADDITIONAL PIPING/FITTINGS AS REQUIRED TO SUIT NEW INSTALLATION CONFIGURATION. EXISTING ISOLATION VALVES AND STRAINERS TO BE REUSED. PROVIDE NEW REGULATING VALVES AND BALANCE TO FLOWS INDICATED ON HEAT PUMP SCHEDULE.
- ⑤ NEW HEAT PUMPS TO BE INSTALLED ON EXISTING SUPPORT STANDS IN SAME ORIENTATION AS EXISTING UNITS. MODIFY STANDS AS REQUIRED TO ACCOMMODATE NEW UNITS. CONFIRM EXACT UNIT ORIENTATION ON SITE PRIOR TO ORDER.

Planification et gestion des biens immobiliers


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NRC - CNRC

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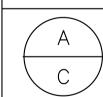




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M7 CHILLER AND HEAT PUMP REPLACEMENTS


MONTREAL ROAD CAMPUS

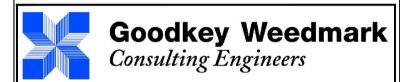MECHANICAL

HEAT PUMP REPLACEMENTS DEMOLITION AND NEW WORK


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checked	R.L.	vérifié	sheet	of/de _	feuille
approved	R.L.	approuvé	W.O.no.	-	D.T.no

5988-M05

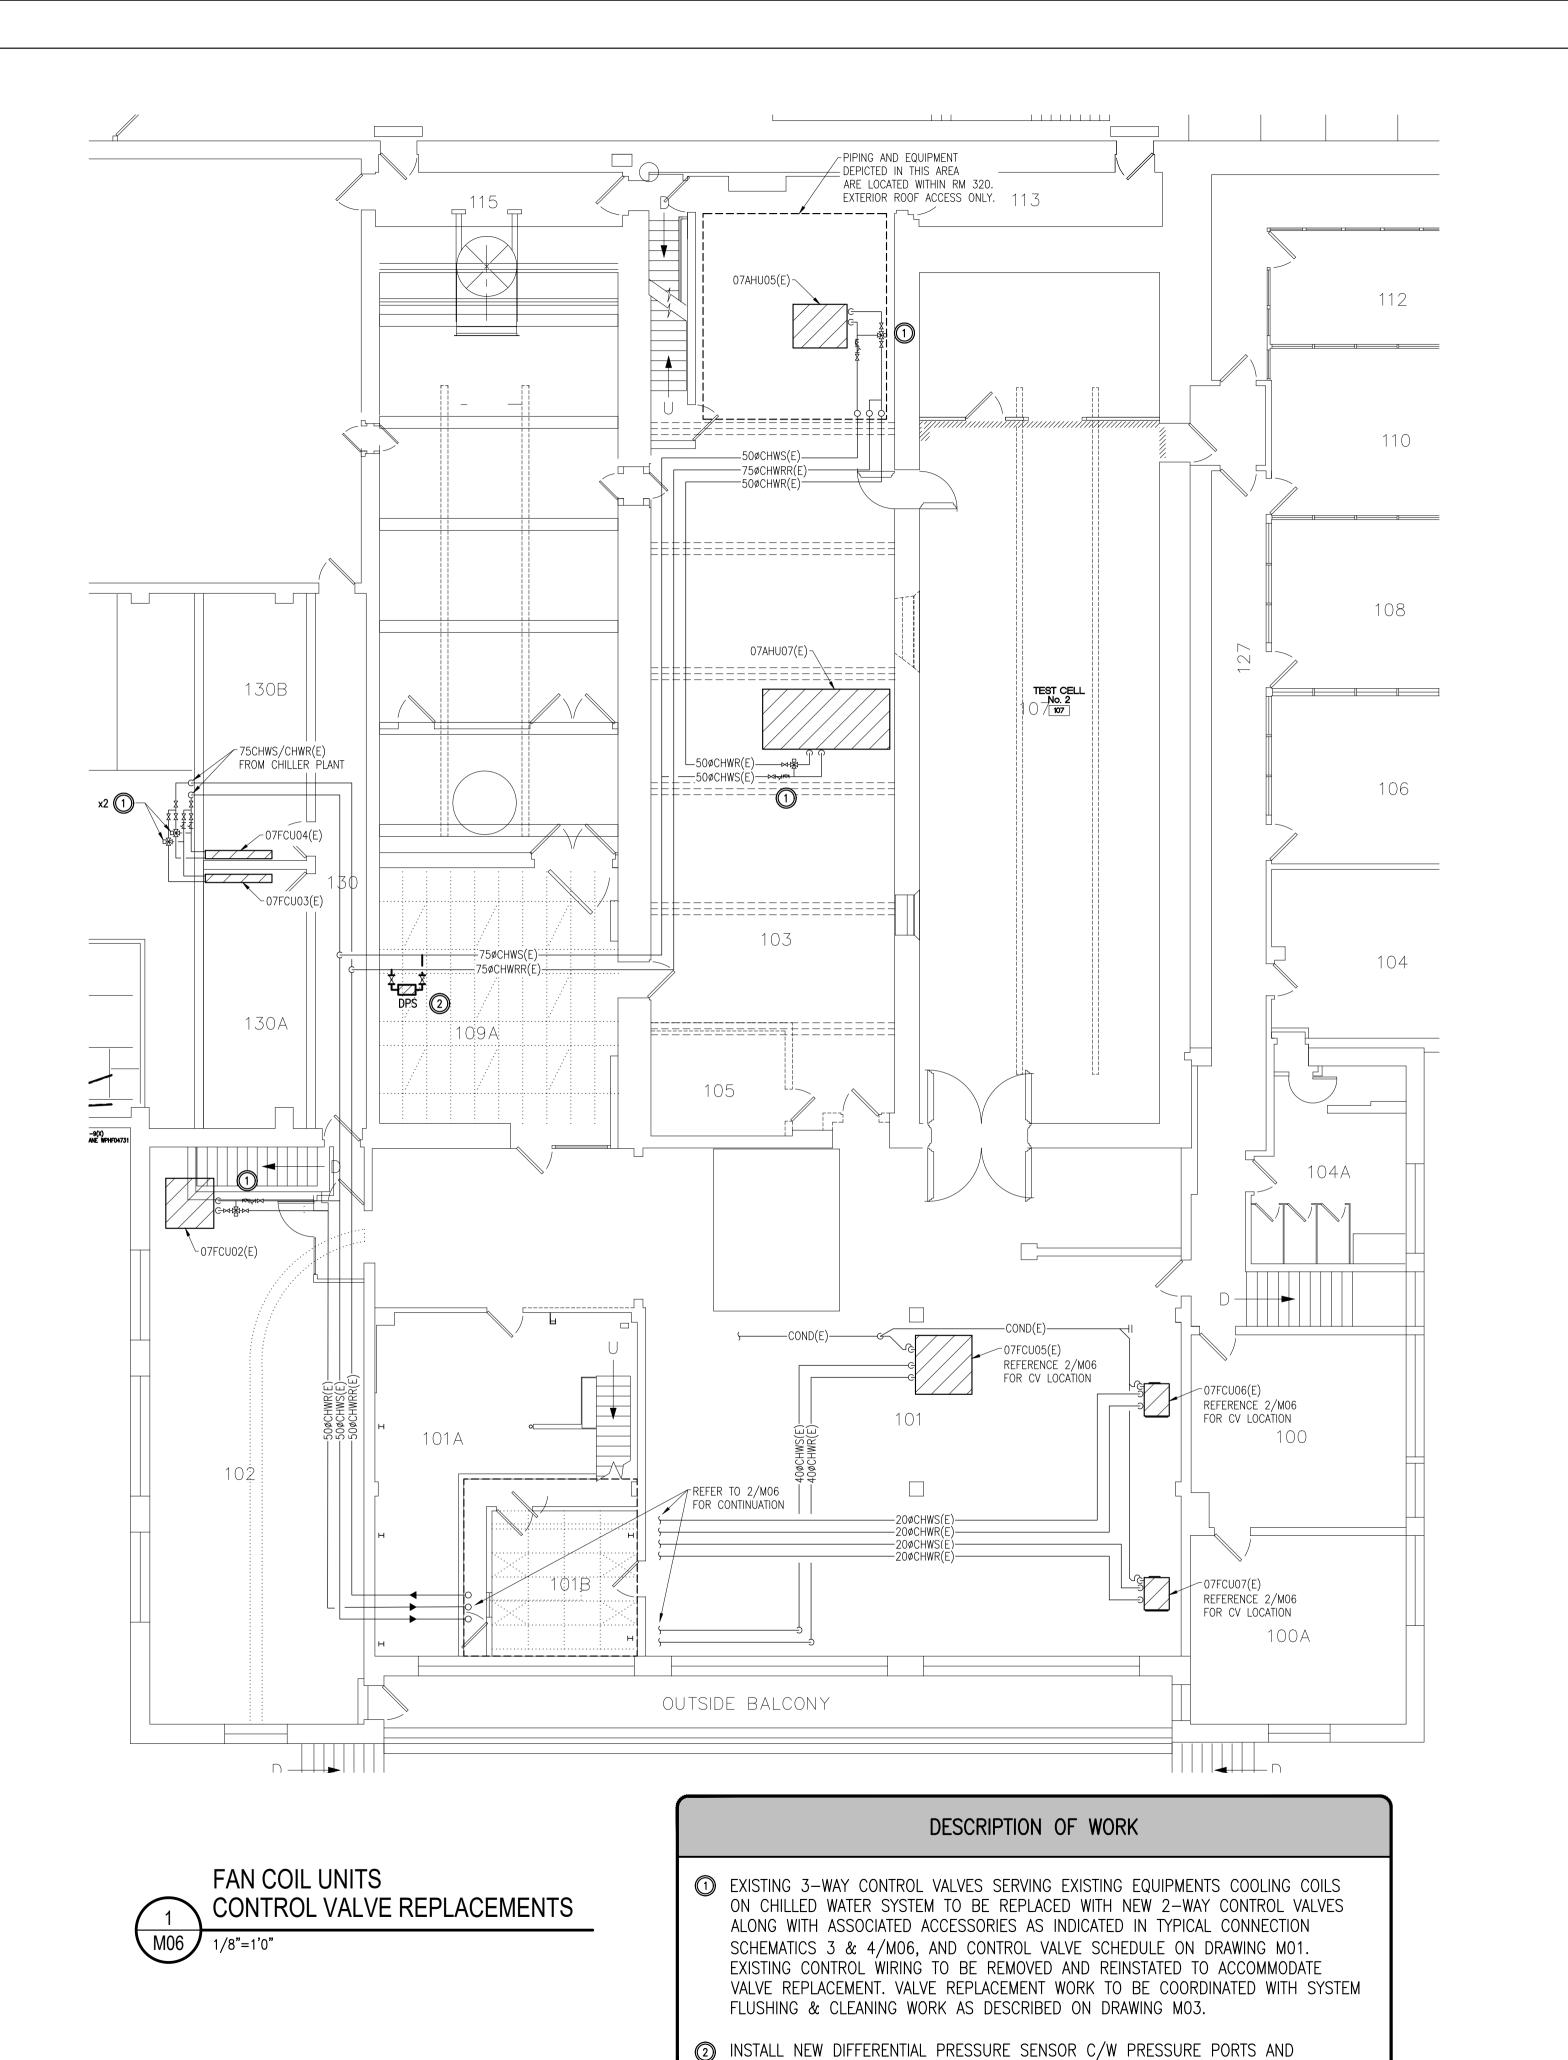

ISOLATION VALVES WHERE INDICATED.

ASPM A1 (841x594)

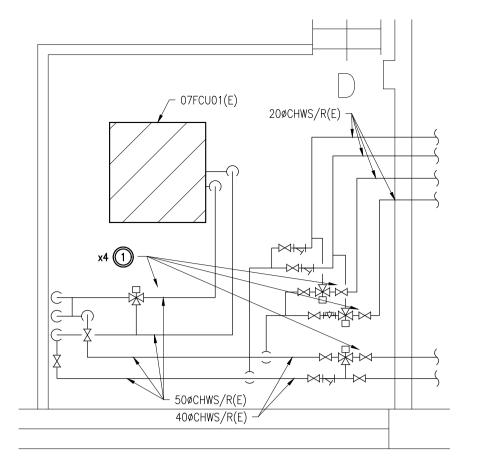


ROOM 101B - SECOND LEVEL


FAN COIL CONTROL VALVE LOCATIONS

 $\binom{2}{M06}$ 

NTS

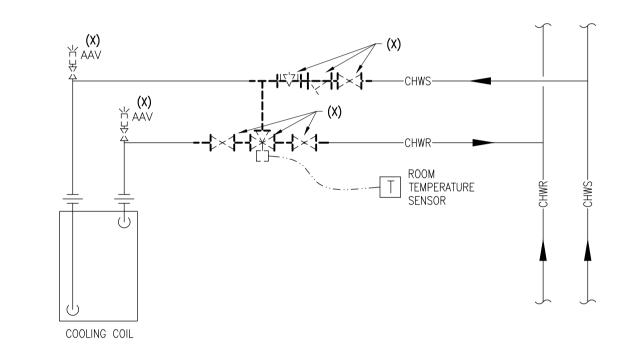

TYPICAL COOLING COIL
CONNECTION SCHEMATIC - DEMOLITION WORK

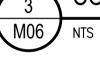

TYPICAL COOLING COIL
CONNECTION SCHEMATIC - NEW WORK

M06 NTS

National Council

Conseil national de recherches Canada

l Property Planning Planification et gestion Management Branch des biens immobiliers

## NRC - CNRC

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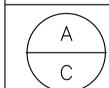


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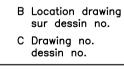
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B Location drawing no.



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M7 CHILLER AND HEAT PUMP REPLACEMENTS

MONTREAL ROAD CAMPUS

MECHANICAL
CONTROL VALVE REPLACEMENTS

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	K.N.			-	
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	K.N.			AS NOTED	
checked		vérifié	sheet		feuille
	R.L.			of/de _	
approved		approuvé	W.O.no.		D.T.no.
	R.L.			_	

5988-M06

## NRC BUILDING M7 - CHILLER AND HEAT PUMP REPLACEMENT 1200 MONTREAL ROAD, OTTAWA, ON. ELECTRICAL

### GENERAL NOTES

## **DEMOLITION NOTES:**

- UNLESS OTHERWISE NOTED, MATERIALS FOR REMOVAL BECOME THE CONTRACTOR'S PROPERTY AND SHALL BE TAKEN FROM SITE AND DISPOSED OF IN ACCORDANCE WITH ALL APPLICABLE CODES, STANDARDS AND REGULATIONS. . DISCONNECT AND MAKE SAFE ALL SYSTEMS TO BE DEMOLISHED INCLUDING PANELS, FEEDERS, BRANCH CIRCUITS AND EQUIPMENT
- BY OTHER DIVISIONS. COORDINATE WITH OTHER DIVISIONS. MAINTAIN EXISTING REMAINING CIRCUITS, SYSTEMS, ETC., WHICH PASS THROUGH AREA OF CONSTRUCTION AND IN CLOSE PROXIMITY.
- PROVIDE NECESSARY COMPONENTS TO MAINTAIN SYSTEMS. ENSURE COMPONENTS WILL BE CONCEALED WHEN CONSTRUCTION IS . REINSTATE IMMEDIATELY ANY REMAINING EXISTING SYSTEMS IN-ADVERTENTLY INTERRUPTED DURING CONSTRUCTION.
- THE DRAWINGS INDICATE KNOWN CONDITIONS AND MAY NOT INDICATE ALL DEMOLITION REQUIREMENTS, ELECTRICAL CONTRACTOR SHALL VISIT THE SITE PRIOR TO TENDER SUBMISSION AND VERIFY REQUIREMENTS AND INCLUDE ALL COSTS IN TENDER.
- REMOVE REDUNDANT CONDUIT AND WIRING BACK TO SOURCE UNLESS OTHERWISE NOTED, AND MAKE SAFE. '. DEVICES FROM DEMOLITION ARE NOT TO BE REUSED UNLESS NOTED OTHERWISE. NEW DEVICES SHALL BE SUPPLIED WHERE
- 8. ALL FIRE ALARM DEVICES TO REMAIN IN OPERATION. PROTECT SMOKE DETECTORS FROM DUST EXPOSURE DURING CONSTRUCTION. 9. ENSURE FIRE ALARM SYSTEM IS OPERATIONAL AT THE END OF EACH SHIFT.
- 10. AFTER DEMOLITION WORK IS COMPLETE AND MINIMUM THREE (3) WORKING DAYS PRIOR TO PROCEEDING WITH NEW WORK, NOTIFY

- ELECTRICAL WORK TO BE DONE IN ACCORDANCE WITH THE ELECTRICAL SAFETY CODE OF ONTARIO, AND WITH NEW ARCHITECTURAL/INTERIOR DESIGNER'S LAYOUT (LOCATION/MOUNTING HEIGHTS). CONTRACTOR TO OBTAIN ALL NECESSARY PERMITS.
- PAY ALL APPLICABLE FEES AND INSPECTION COSTS.
- 2. COORDINATE WORK WITH ALL OTHER TRADES TO AVOID INTERFERENCE. 3. ENSURE ELECTRICAL COMPONENTS (IE. WIRING, CONDUIT, ETC.) RELATING TO THE AREA OF WORK ARE INDEPENDENTLY SECURED TO COMPLY WITH CODE REQUIREMENTS. IT IS NOT ACCEPTABLE TO SECURE THE COMPONENTS TO DUCTWORK, DUCT WORK TO
- 4. ENSURE ALL EXISTING CEILING MOUNTED BOXES ARE CLOSED PRIOR TO COMPLETION OF PROJECT. PROVIDE LABELLED AND
- COLOUR CODED COVER PLATES (IE. PANEL NAME AND CIRCUIT NUMBER) AS REQUIRED. . MINIMUM THREE (3) WORKING DAYS PRIOR TO CLOSING CEILING, NOTIFY THE ENGINEER FOR CEILING INSPECTION.

1. ENSURE EXISTING REMAINING OUTLETS IN AFFECTED AREA ARE FUNCTIONAL.

2. DO NOT MOUNT WALL OUTLETS BACK TO BACK. LEAVE MINIMUM 300mm SPACE BETWEEN OUTLETS. STAGGER OUTLETS WITHIN ALTERNATE STUD CAVITIES. DO NOT ANCHOR BACK TO BACK OUTLETS TO THE SAME STUD.


APPLICABLE TO NEW OR RELOCATED WORK UNLESS OTHERWISE NOTED.

- . TO CONFORM TO CLIENT'S BUILDING CODING SYSTEM.
- 2. COLOUR CODE CONDUITS AND BOXES. 3. CODE WITH PLASTIC TAPE OR PAINT WHERE CONDUITS ENTER WALLS, CEILING, OR FLOOR AND AT 15 METER INTERVALS.
  4. COLOURS: 25mm WIDE PRIME COLOUR AND 20mm WIDE AUXILIARY COLOUR.
- 5. REFER TO SPECIFICATIONS FOR COLOR CODING.

I. EXACT LOCATION AND MOUNTING HEIGHTS OF OUTLETS TO BE COORDINATED WITH INTERIOR DESIGNER/ARCHITECTURAL DRAWINGS PRIOR TO ROUGH IN. REFER TO ARCHITECTURAL/DESIGNER DRAWINGS FOR MILLWORK, FURNITURE, SCREENS, COMPONENTS (I.E. TV, DRINKING FOUNTAIN,

2. BRING TO THE ATTENTION OF THE ARCHITECT / INTERIOR DESIGNER AND ENGINEER ANY CONFLICTS OR REQUIRED CLARIFICATION.

3. FAILING TO COORDINATE, THE CONTRACTOR WILL MODIFY THE INSTALLATION AT HIS EXPENSE, IF REQUIRED.

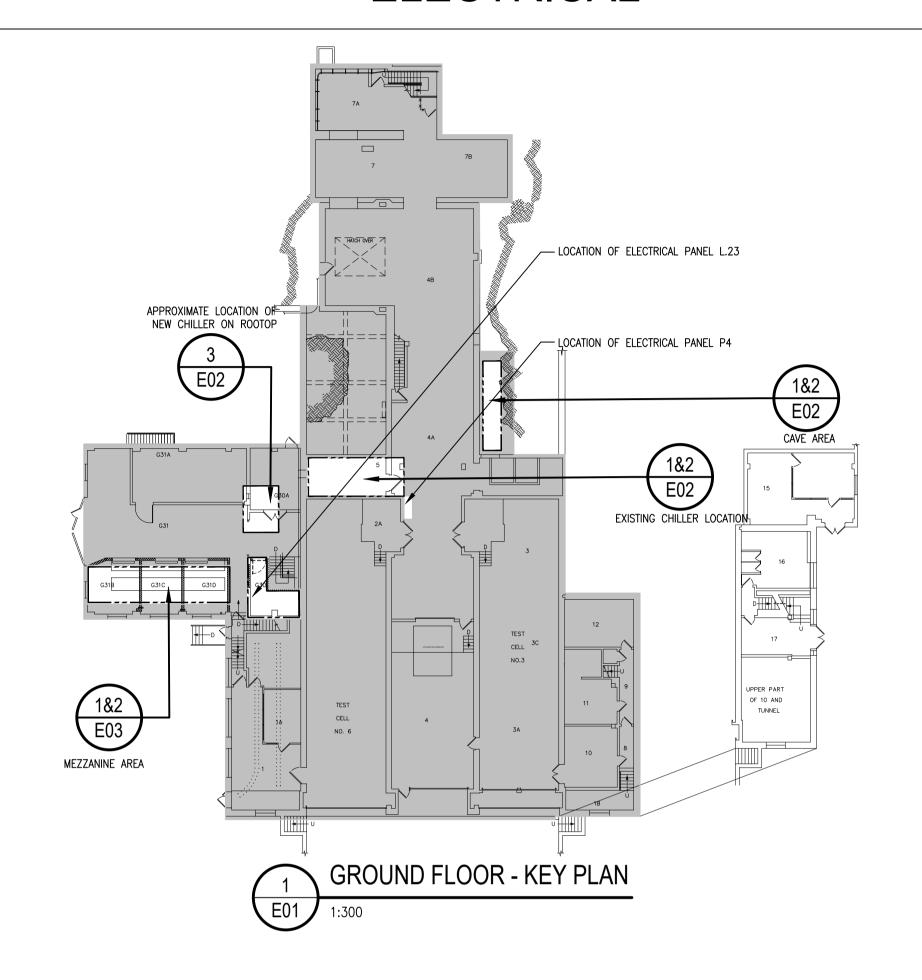

	ELECTRICAL LEGEND						
SYMBOL	DESCRIPTION						
E	SURFACE MOUNTED LIGHT FIXTURE						
(1///)	SURFACE MOUNTED ELECTRICAL PANEL						
	SAFETY SWITCH						
	MANUAL MOTOR STARTER						
VFD	VARIABLE FREQUENCY DRIVE						
<b>S</b>	120V, 15A SOLENOID VALVE						
\$	MOTOR RATED SWITCH						
<b>=</b>	THREE-PHASE ELECTRICAL MOTOR						
4	HARDWIRED CONNECTION						
GFCI W.P	GFCI, 5-20R, WEATHERPROOF MAINTENANCE RECEPTACLE						
Ф	120V, 15A DUPLEX RECEPTACLE						

DRAWING LIST

GROUND LEVEL AND ROOFTOP - POWER & SYSTEMS

MEZZANINE - TRIBOLOGY LAB - POWER & SYSTEMS

DEMOLITION & NEW WORK

GENERAL NOTES, ELECTRICAL LEGEND, DRAWING LIST, AND KEY PLAN

DWG No. | DESCRIPTION

DEMOLITION & NEW WORK			
ABBREVIATION LEGEND			
SYMBOL	DESCRIPTION		
С	CEILING MOUNTED		
Х	EXISTING, TO BE REMOVED		
Е	EXISTING, TO REMAIN		
N	NEW		
S	SURFACE MOUNTED		
W.P	WEATHERPROOF ENCLOSURE		

	LINETYPE LEGEND		
SYMBOL	SYMBOL DESCRIPTION		
	NEW WORK		
	EXISTING		
	DEMOLITION		

GROUND FAULT CIRCUIT INTERRUPTER

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Conseil national

des biens immobiliers

# NRC - CNRC

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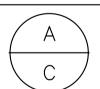
SURFACES AT COMPLETION.




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B Location drawing no.




M7 CHILLER AND HEAT PUMP REPLACEMENTS

MONTREAL ROAD CAMPUS

ELECTRICAL LEGENDS, DRAWING LIST, GENERAL NOTES AND KEY PLAN
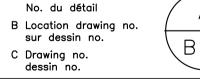
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	R.B			_	

5988-E01

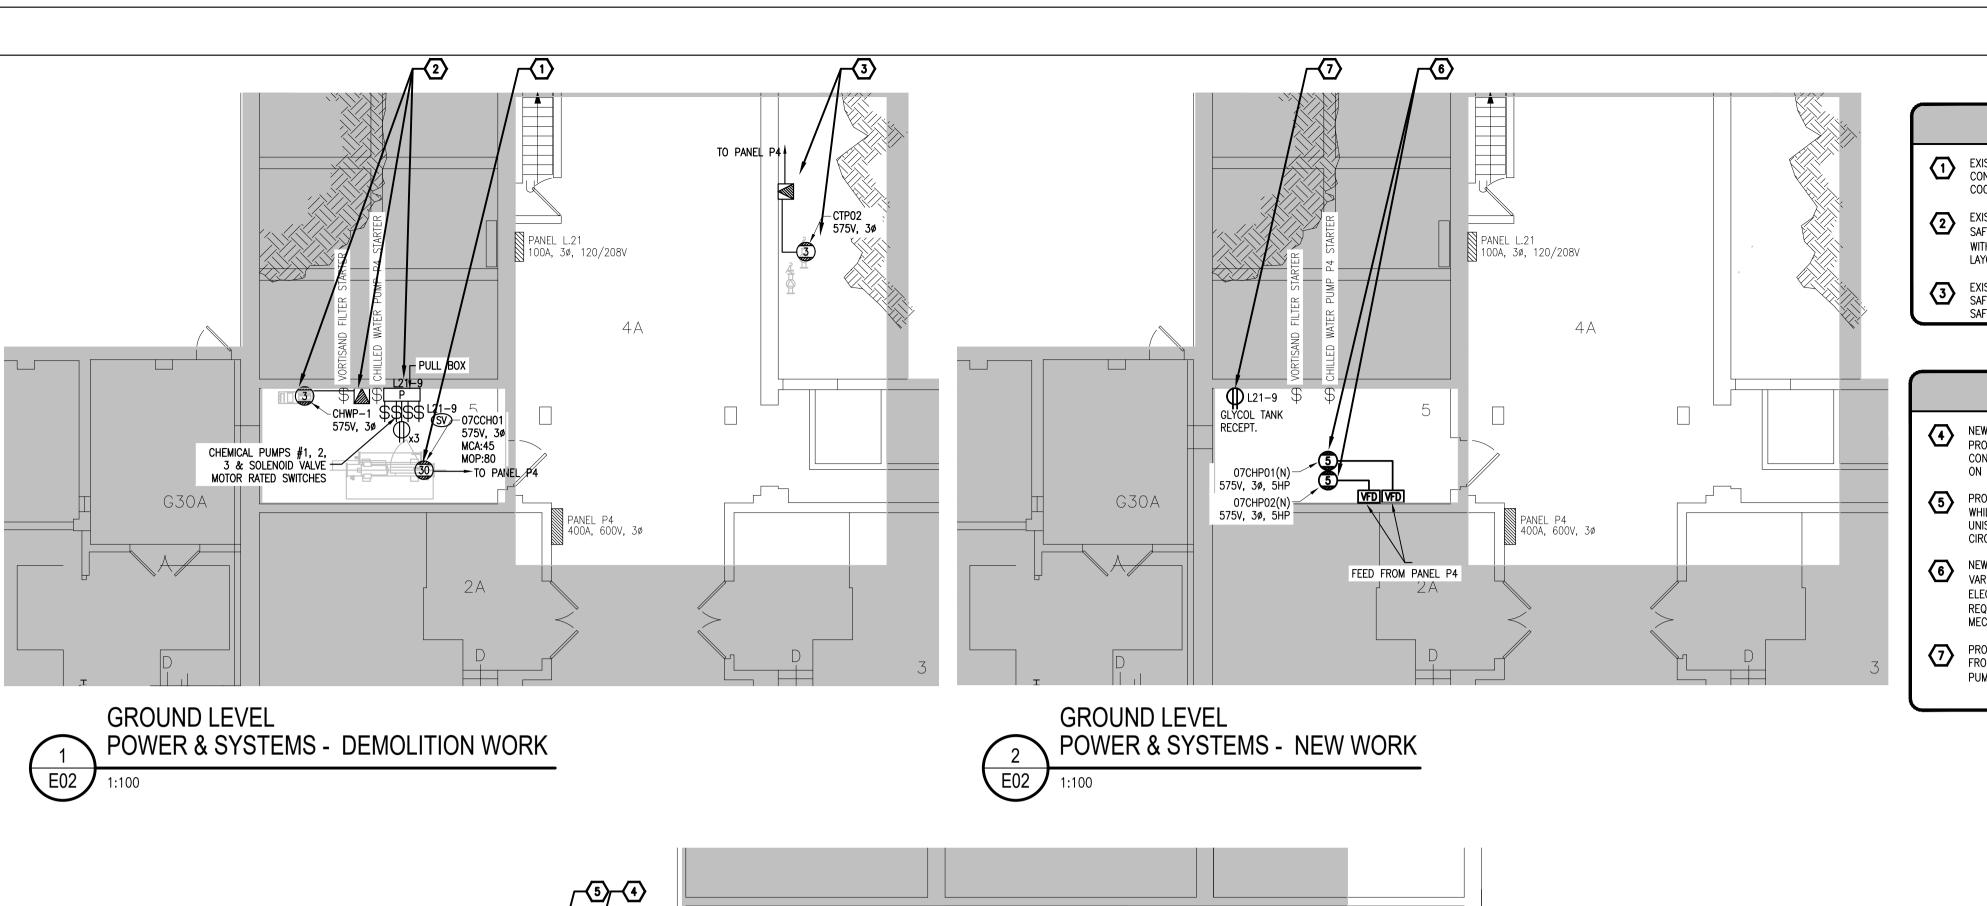

## DRAWING NOTES - DEMOLITION WORK

- EXISTING CHILLER (07CCH01) TO BE REMOVED BY MECHANICAL TRADES. DISCONNECT AND MAKE SAFE. REMOVE CONDUIT AND WIRING BACK TO THE SOURCE. RETURN 70A CIRCUIT BREAKER TO NRC FOR STORAGE. COORDINATE WORK ON SITE WITH MECHANICAL TRADES.
- EXISTING CHILLER WATER PUMP (CHWP01) TO BE REMOVED BY MECHANICAL TRADES. DISCONNECT AND MAKE SAFE. RETAIN FEEDER FOR RE—USE IN NEW LAYOUT. REMOVE 120V, RECEPTACLES(x3) AS INDICATED ALONG WITH CHEMICAL PUMPS #1, 2, 3 AND SOLENOID VALVE STARTERS. RETAIN CIRCUIT FOR RE—USE IN NEW LAYOUT. COORDINATE WORK ON SITE WITH MECHANICAL TRADES.
- EXISTING CIRCULATING WATER PUMP (CTP02) TO BE REMOVED BY MECHANICAL TRADES. DISCONNECT AND MAKE SAFE. REMOVE MOTOR STARTER AS INDICATED. REMOVE CONDUIT AND WIRING BACK TO THE SOURCE AND MAKE SAFE. MARK CIRCUIT BREAKER AS SPARE. COORDINATE WORK ON SITE WITH MECHANICAL TRADES.

### DRAWING NOTES - NEW WORK

- NEW AIR-COOLED CHILLER (07CCH01) ON ROOF TOP TO BE SUPPLIED AND INSTALLED BY MECHANICAL TRADES PROVIDE WEATHER-PROOF SAFETY SWITCH, AND CONNECTION AS INDICATED C/W CONDUIT AND WIRING. CONNECT TO INDICATED CIRCUITS. CONDUIT AND WIRING TO FOLLOW REFRIGERANT PIPING. COORDINATE WORK ON SITE WITH MECHANICAL TRADES.
- PROVIDE NEW SERVICE MAINTENANCE, DEDICATED, 120V, 5–20R GFCI RECEPTACLE C/W WEATHER-PROOF WHILE-IN-USE COVER PLATE, CONDUIT AND WIRING. MOUNT RECEPTACLE AT 750mm A.F.F. PROVIDE REQUIRED UNISTRUT ASSEMBLY. COORDINATE EXACT LOCATION ON-SITE WITH MECHANICAL TRADES. CONNECT TO INDICATED CIRCUIT. REFER TO PANEL L.23 ON DRAWING E03 FOR FURTHER INFORMATION.
- NEW CHILLER PUMPS 07CHP01 & 07CHP02 TO BE SUPPLIED AND INSTALLED BY MECHANICAL TRADES.

  VARIABLE FREQUENCY DRIVE (VFD) TO BE SUPPLIED BY MECHANICAL TRADES, INSTALLED AND WIRED BY ELECTRICAL. CONNECT NEW (07CHP01) RE—ROUTE EXISTING FEEDER AND EXTEND CONDUIT AND WIRING AS REQUIRED. PROVIDE NEW CONDUIT AND WIRING AS REQUIRED FOR (07CHP02). COORDINATE WORK ON SITE WITH MECHANICAL TRADES. REFER TO PANEL DIRECTORY ON THIS DRAWING FOR FURTHER DETAILS.
- PROVIDE NEW 120V, 15A (5-15R) RECEPTACLE AS INDICATED. EXTEND CONDUIT AND WIRING AS REQUIRED FROM PULLBOX. CONNECT TO EXISTING CIRCUIT THAT WAS FEEDING THE THREE RECEPTACLES FOR CHEMICAL PUMPS #1, 2, 3. COORDINATE EXACT LOCATION ON SITE WITH MECHANICAL TRADES.

National Research

de recherches Canada

Conseil national

Planification et gestion

and Management Branch des biens immobiliers



GENERAL NOTES

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- CONTRACTOR TO BE RESPONSIBLE FOR REINSTATEMENT AND REPAIR OF ANY DAMAGE CAUSED BY WORK.
- CONTRACTOR SHALL PREVENT THE SPREAD OF DUST AND DEBRIS BEYOND AREA OF WORK AND CLEAN ALL SURFACES AT COMPLETION.






GOODKEY WEEDMARK & ASSOCIATES LIMITED

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1	2022-01-25	ISSUED FOR TENDER
-	2021-12-15	ISSUED FOR 100% REVIEW
-	2021-11-17	ISSUED FOR 99% REVIEW
-	2021-10-13	ISSUED FOR 66% REVIEW
ı	2021-08-27	ISSUED FOR 33% REVIEW

- Verify all dimensions and site conditions and be responsible for same
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No. Date

A Detail no. No. du détail B Location drawing no.

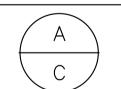B Location drawing of sur dessin no.
C Drawing no.
dessin no.

M7 CHILLER AND
HEAT PUMP REPLACEMENTS

MONTREAL ROAD CAMPUS

GROUND LEVEL AND ROOFTOP POWER AND SYSTEMS DEMOLITION WORK AND NEW WORK

designed		conçu	date		date
	D.A			_	
drawn		dessiné	scale		échelle
	D.A			AS NOTE	D
checked		vérifié	sheet		feuille
	R.B			of/de	_
approved		approuvé	W.O.no.		D.T.no.
	P P			_	

5988-E02

	VOLTAGE PHASE WIRE RATING AMPS TRIM	347/600V 3ø 4W 400A SURFACE	
	<u>SN</u>	2 4	
STARTER IN T.C #6 FOR T.C#1&2	5 7 9	6 70 8 10	CHILLER LOCATED IN RM05
CHILLED WATER PUMP LOCATED IN RM05	15 13 15	12 15 14 16	COOLING TOWER PUMP SOUTH CAVE CTP02
VORTISAND FILTER PUMP IN RM05	15 17 19	18 30	BAND SAW IN T.C #6
HUMIDIFIER RM111 TEST CELL#2	21 23 25	22 24 30 26	ARKTITE RECEPT. T.C #6
HUMIDIFIER RM220 TEST CELL#4	27 29 MANUFACTURER: SQUARE D -	28 30 40 CAT#HCM23644CCU	PLASMA CUTTER T.C #6
	EXISTING REVI	SED	


VOLTAGE

PHASE

RATING AMPS

**EXISTING** 

**PANEL** 

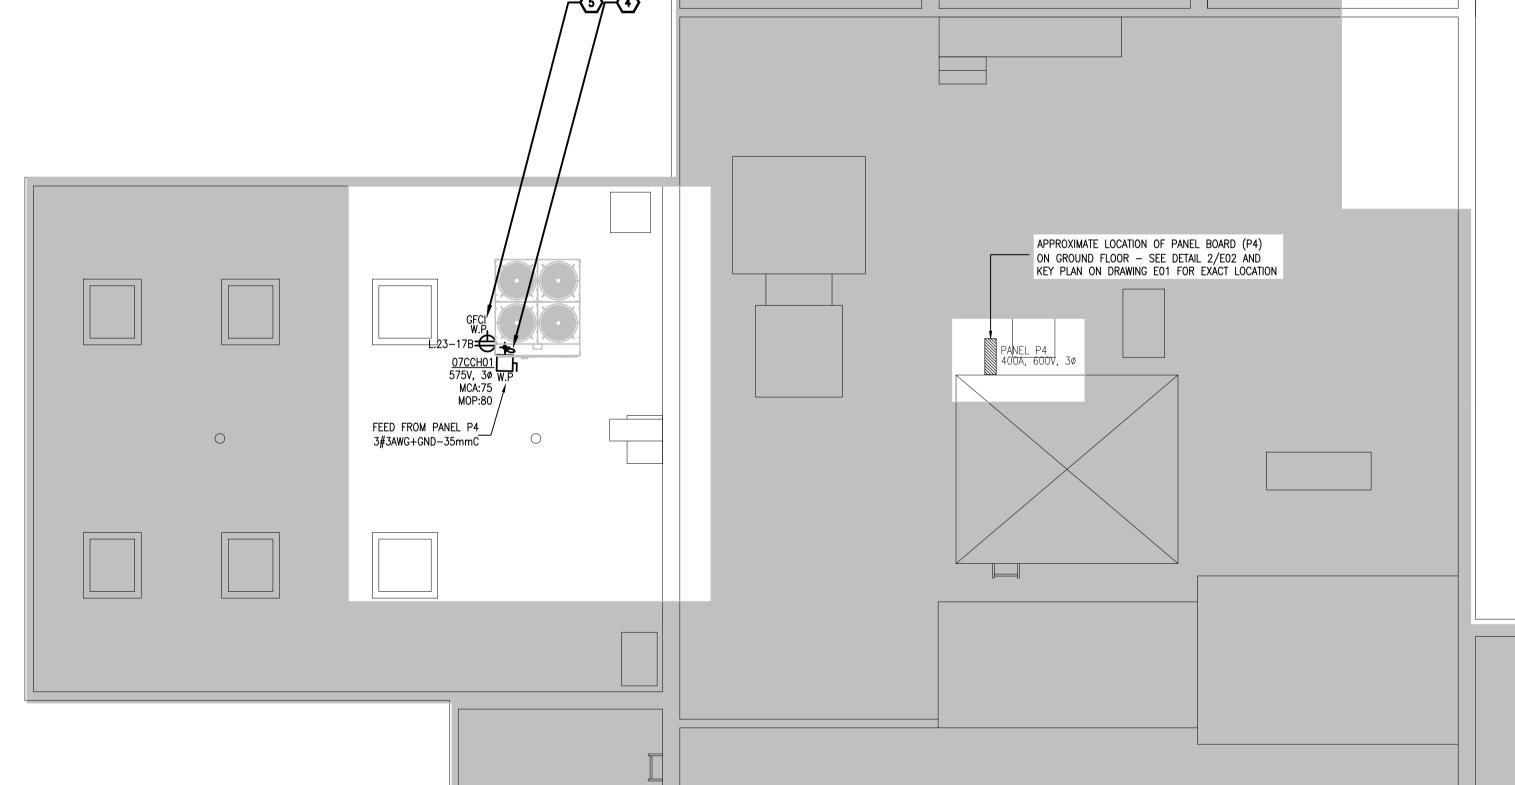


ROOFTOP POWER & SYSTEMS - NEW WORK

ASPM A1 (841x594)


MANUFACTURER: SQUARE D - CAT#HCM23644CCU

\* NEW THERMAL MAGNETIC CIRCUIT BREAKER

347/600V

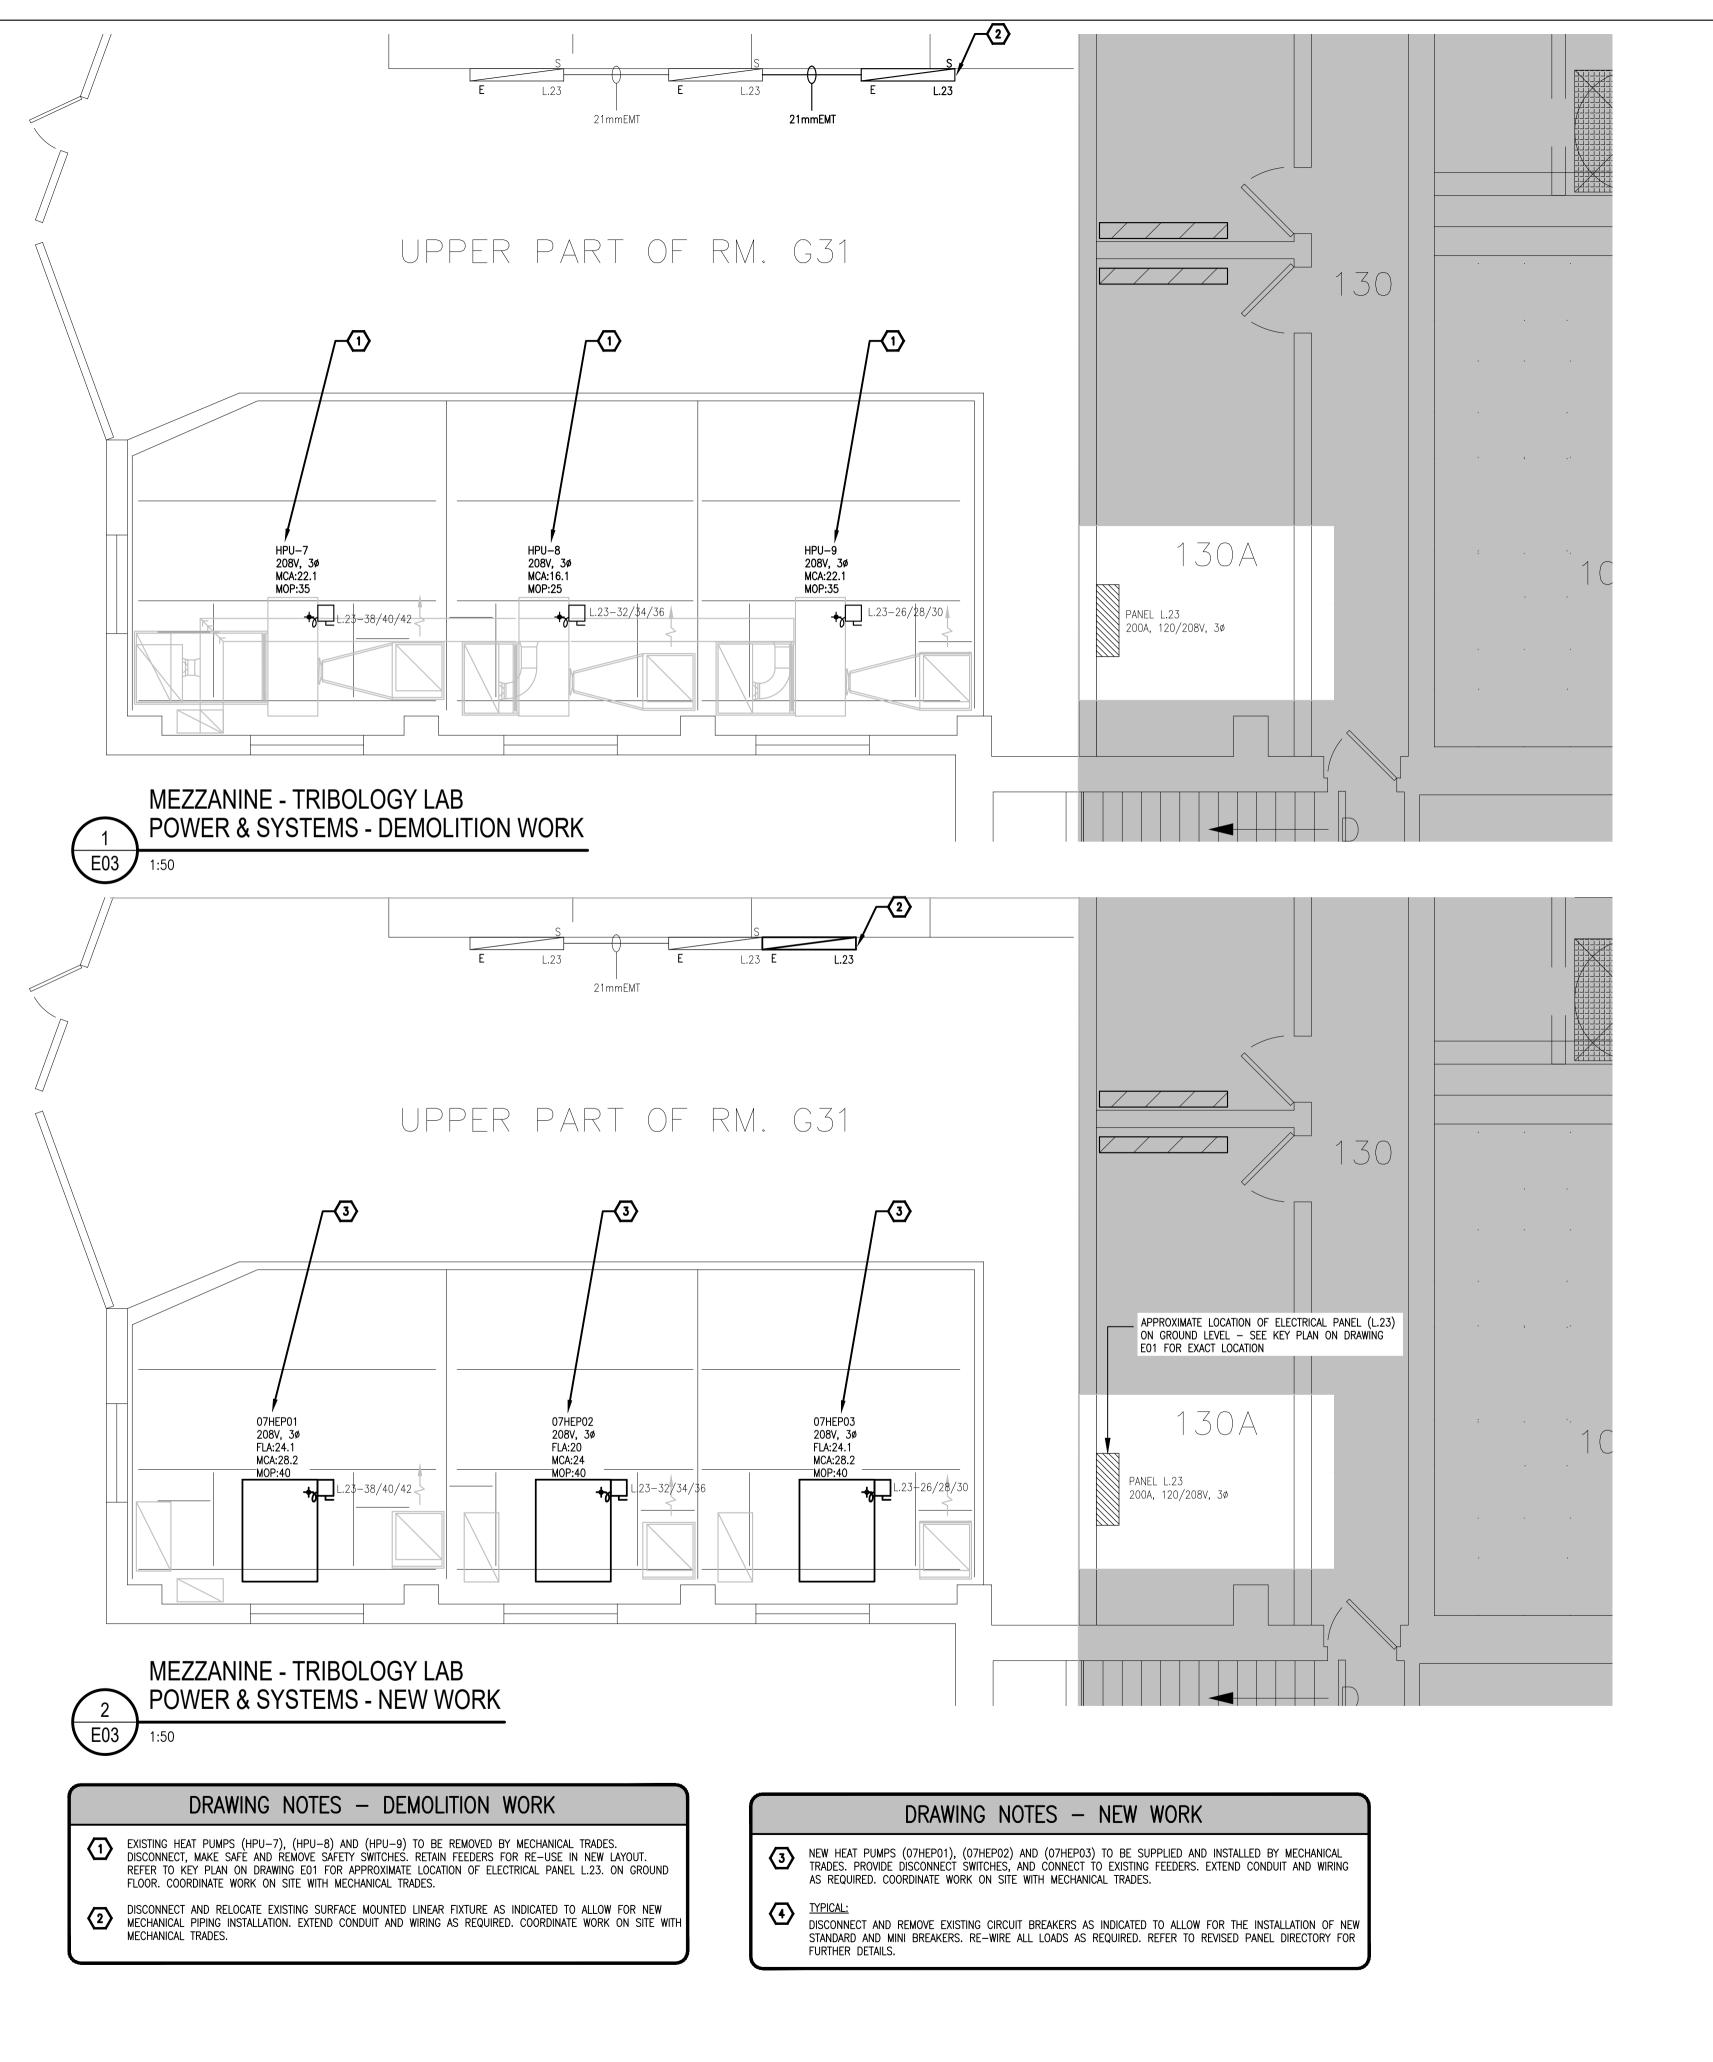

ASPM A1 (841x594)

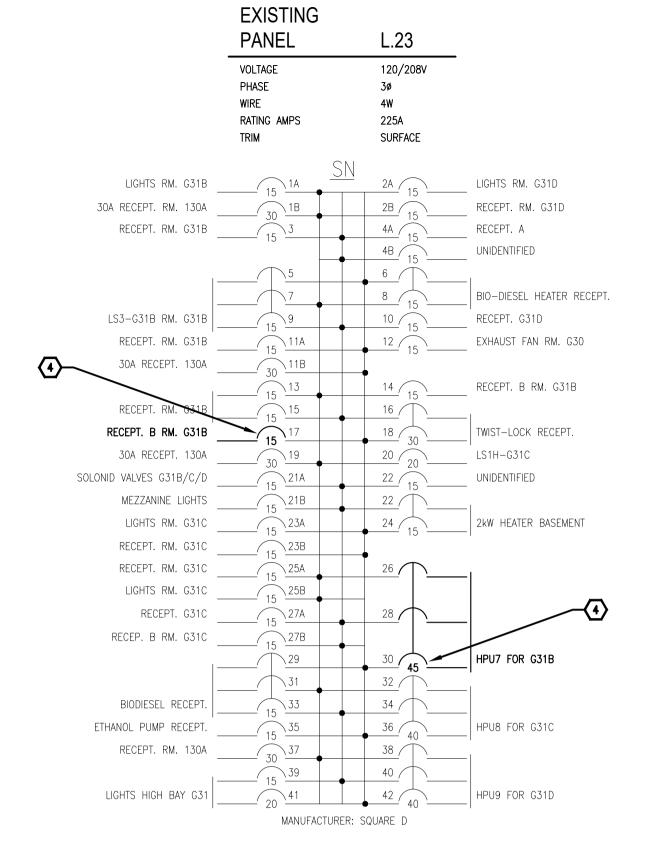

	RATING AMPS TRIM	225A SURFACE	
		SN	
LIGHTS RM. G31B _	15 1A —	2A 15	LIGHTS RM. G31D
30A RECEPT. RM. 130A _	30 1B	2B 15	RECEPT. RM. G31D
RECEPT. RM. G31B _	15 3	4A 15	RECEPT. A
		4B 15	UNIDENTIFIED
1-	5	6	<u> </u>
-	7	8 15	BIO-DIESEL HEATER RECEPT
LS3-G31B RM. G31B	15 9	10 15	RECEPT. G31D
RECEPT. RM. G31B _	15 11A	12 15	EXHAUST FAN RM. G30
30A RECEPT. 130A	30 11B		
	15 13	14 15	RECEPT. B RM. G31B
RECEPT. RM. <del>03</del> 1B	15 15	16	—— I
RECEPT. B RM. G31B	** 15 17A	18 30	TWIST-LOCK RECEPT.
ROOFTOP MAINTENANCE RECEPT. FOR NEW CHILLER	** 20 17B		,
30A RECEPT. 130A _	30 19	20 20	LS1H-G31C
SOLONID VALVES G31B/C/D	15 21A	22 15	UNIDENTIFIED
MEZZANINE LIGHTS _	15 21B	22	— I
LIGHTS RM. G31C	15 23A	24 15	2kW HEATER BASEMENT
RECEPT. RM. G31C	15 23B		
RECEPT. RM. G31C	15 25A	26	<b>—</b> I
LIGHTS RM. G31C	15 25B		
RECEPT. G31C	15 27A	28	
RECEP. B RM. G31C	15 27B		
1-	29	30 40 *	NEW 07HEP01 FOR G31B
_	31	32	i
BIODIESEL RECEPT.	15 33	34	
ETHANOL PUMP RECEPT	15 35	36 40	NEW 07HEP02 FOR G31C
RECEPT. RM. 130A	30 37	38	i
1-	15 39	40	
LIGHTS HIGH BAY G31	20 41	42 40	NEW 07HEP03 FOR G31D
M/	ANUFACTURER: SQUARE D  * PROVIDE NE		CU-E2

**EXISTING REVISED** 

120/208V

4W

PANEL

VOLTAGE PHASE

WIRE

National Research
Council Canada

erty Planning Planification et gestion gement Branch des biens immobiliers

Conseil national de recherches Canada

NRC · CNRC

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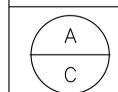


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d détail
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MONTREAL ROAD CAMPUS

MEZZANINE - TRIBOLOGY LAB POWER AND SYSTEMS

DEMOLITION AND NEW WORK

5988-E03