



3	ISSUED FOR TENDER	06/17/2022
2	ISSUED FOR RS4 99% SUBMISSION	10/30/2020
1	ISSUED FOR RS4 66% SUBMISSION	02-28/2020
0	ISSUED FOR RS3 SUBMISSION	08-17/2018

revisions	date
project	project

**SEWAGE TREATMENT UPGRADES
SPRINGHILL INSTITUTION
SPRINGHILL, NS**

**ELECTRICAL
EXISTING SITE PLANS**

designed	EH	conçu
date	2022-06-17	
drawn	GS	dessiné
date	2022-06-17	
approved	DD	approuvé
date	2022-06-17	
Tender		Soumission

PWSC Project Manager	Administrateur de projets TPSGC
project number	no. du projet
R.061876.001	
drawing no.	no. du dessin


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LEGEND

- NEW WORK
- - - EXISTING
- - - - REMOVALS
- CA - - - EXISTING UNDERGROUND COMMUNICATIONS
- PWR - - - EXISTING UNDERGROUND POWER
- CA - - - NEW UNDERGROUND COMMUNICATIONS
- PWR - - - NEW UNDERGROUND POWER
- ⊕ 15A, 125V DUPLEX RECEPTACLE
- ⊕ 20A, 125V DUPLEX RECEPTACLE
- ⊕ 20A, 125V DUPLEX GFI RECEPTACLE
- ⊕ JUNCTION BOX
- ☐ UNIT HEATER, H# INDICATES TYPE, REFER TO SCHEDULE
- ☐ FAN FORCED HEATER, H# INDICATES TYPE, REFER TO SCHEDULE
- ☐ BASEBOARD HEATER, H# INDICATES TYPE, REFER TO SCHEDULE
- ☐ SURFACE MOUNTED PANELBOARD
- ☐-xxA DISCONNECT, SIZE AS INDICATED
- \$ 15A, 120V TOGGLE SWITCH
- M\$ MOTOR RATED SWITCH FOR FAN CONTROLLED BY OCCUPANCY SENSOR
- V\$ TOGGLE SWITCH WITH VACANCY SENSOR
- LV\$ LOW VOLTAGE TOGGLE SWITCH
- MT\$ MECHANICAL TIMER
- ⊙ OCCUPANCY SENSOR SWITCH LOCATION
- WP ⊙ EXTERIOR WALL MOUNTED OCCUPANCY SENSOR
- ⌚ TIME CLOCK
- ⊕ LIGHTING CONTACTOR
- ⊕ DOOR CONTACT
- ⊕ ROOM TEMPERATURE SENSOR
- ☐ LINEAR LUMINAIRE
- ⊕ WALL MOUNTED LUMINAIRE
- ⊕ WALL /CEILING MOUNTED EXIT SIGN SHADING
- INDICATES NUMBER AND LOCATION OF FACES
- ARROW - INDICATES DIRECTION OF EXIT, TWO ARROWS REQUIRE TWO SIGNS INSTALLED AT THE SAME LOCATION
- ⊕-x EMERGENCY BATTERY PACK C/W DUAL HEADS
- DC-x INDICATES DC CIRCUIT NUMBER
- ⊕-x SINGLE/DUAL EMERGENCY REMOTE HEAD DC-x
- ⊕ DC-x INDICATES DC CIRCUIT NUMBER
- ⊕ SMOKE DETECTOR
- ⊕ FAP FIRE ALARM PANEL
- ⊕ PS FIRE ALARM PULL STATION
- ⊕ HD HEAT DETECTOR
- ⊕ FIM FIRE ALARM ISOLATION MODULE
- ⊕ DC DOOR CONTACT
- ⊕ HORN/STROBE
- ⊕ DATA OUTLET
- EX INDICATES EXISTING DEVICE TO REMAIN
- EM INDICATES LIGHTING CONNECTED TO EMERGENCY LIGHTING INVERTER
- REL INDICATES DEVICE/CIRCUIT TO BE RELOCATED
- DEL INDICATES DEVICE TO BE REMOVED
- GFR INDICATES GROUND FAULT RECEPTACLE
- MH INDICATES DEVICE MOUNTED HIGH
- WP INDICATES WEATHERPROOF DEVICE
- XP INDICATES HAZARDOUS LOCATION ZONE 1 EXPLOSION PROOF DEVICES

NOTES

- REFERENCE NOTES:**
- ALL CONDUIT WHICH ENTERS DIVIDED CABLE PIT THAT HAS BEEN MADE REDUNDANT BY THE REMOVAL OF EXISTING BUILDINGS TO BE SEALED TO ENSURE NO WATER ENTRY IS ALLOWED INTO CABLE PIT.
 - REMOVE ALL WIRING FROM UNDERGROUND CONDUIT MADE REDUNDANT BY THE REMOVAL OF EXISTING BUILDINGS. EMPTY UNDERGROUND CONDUITS TO BE SEALED AND ABANDONED.
 - EXISTING TRANSCLOSURE AND TRANSFORMER SHALL BE DEMOLISHED.

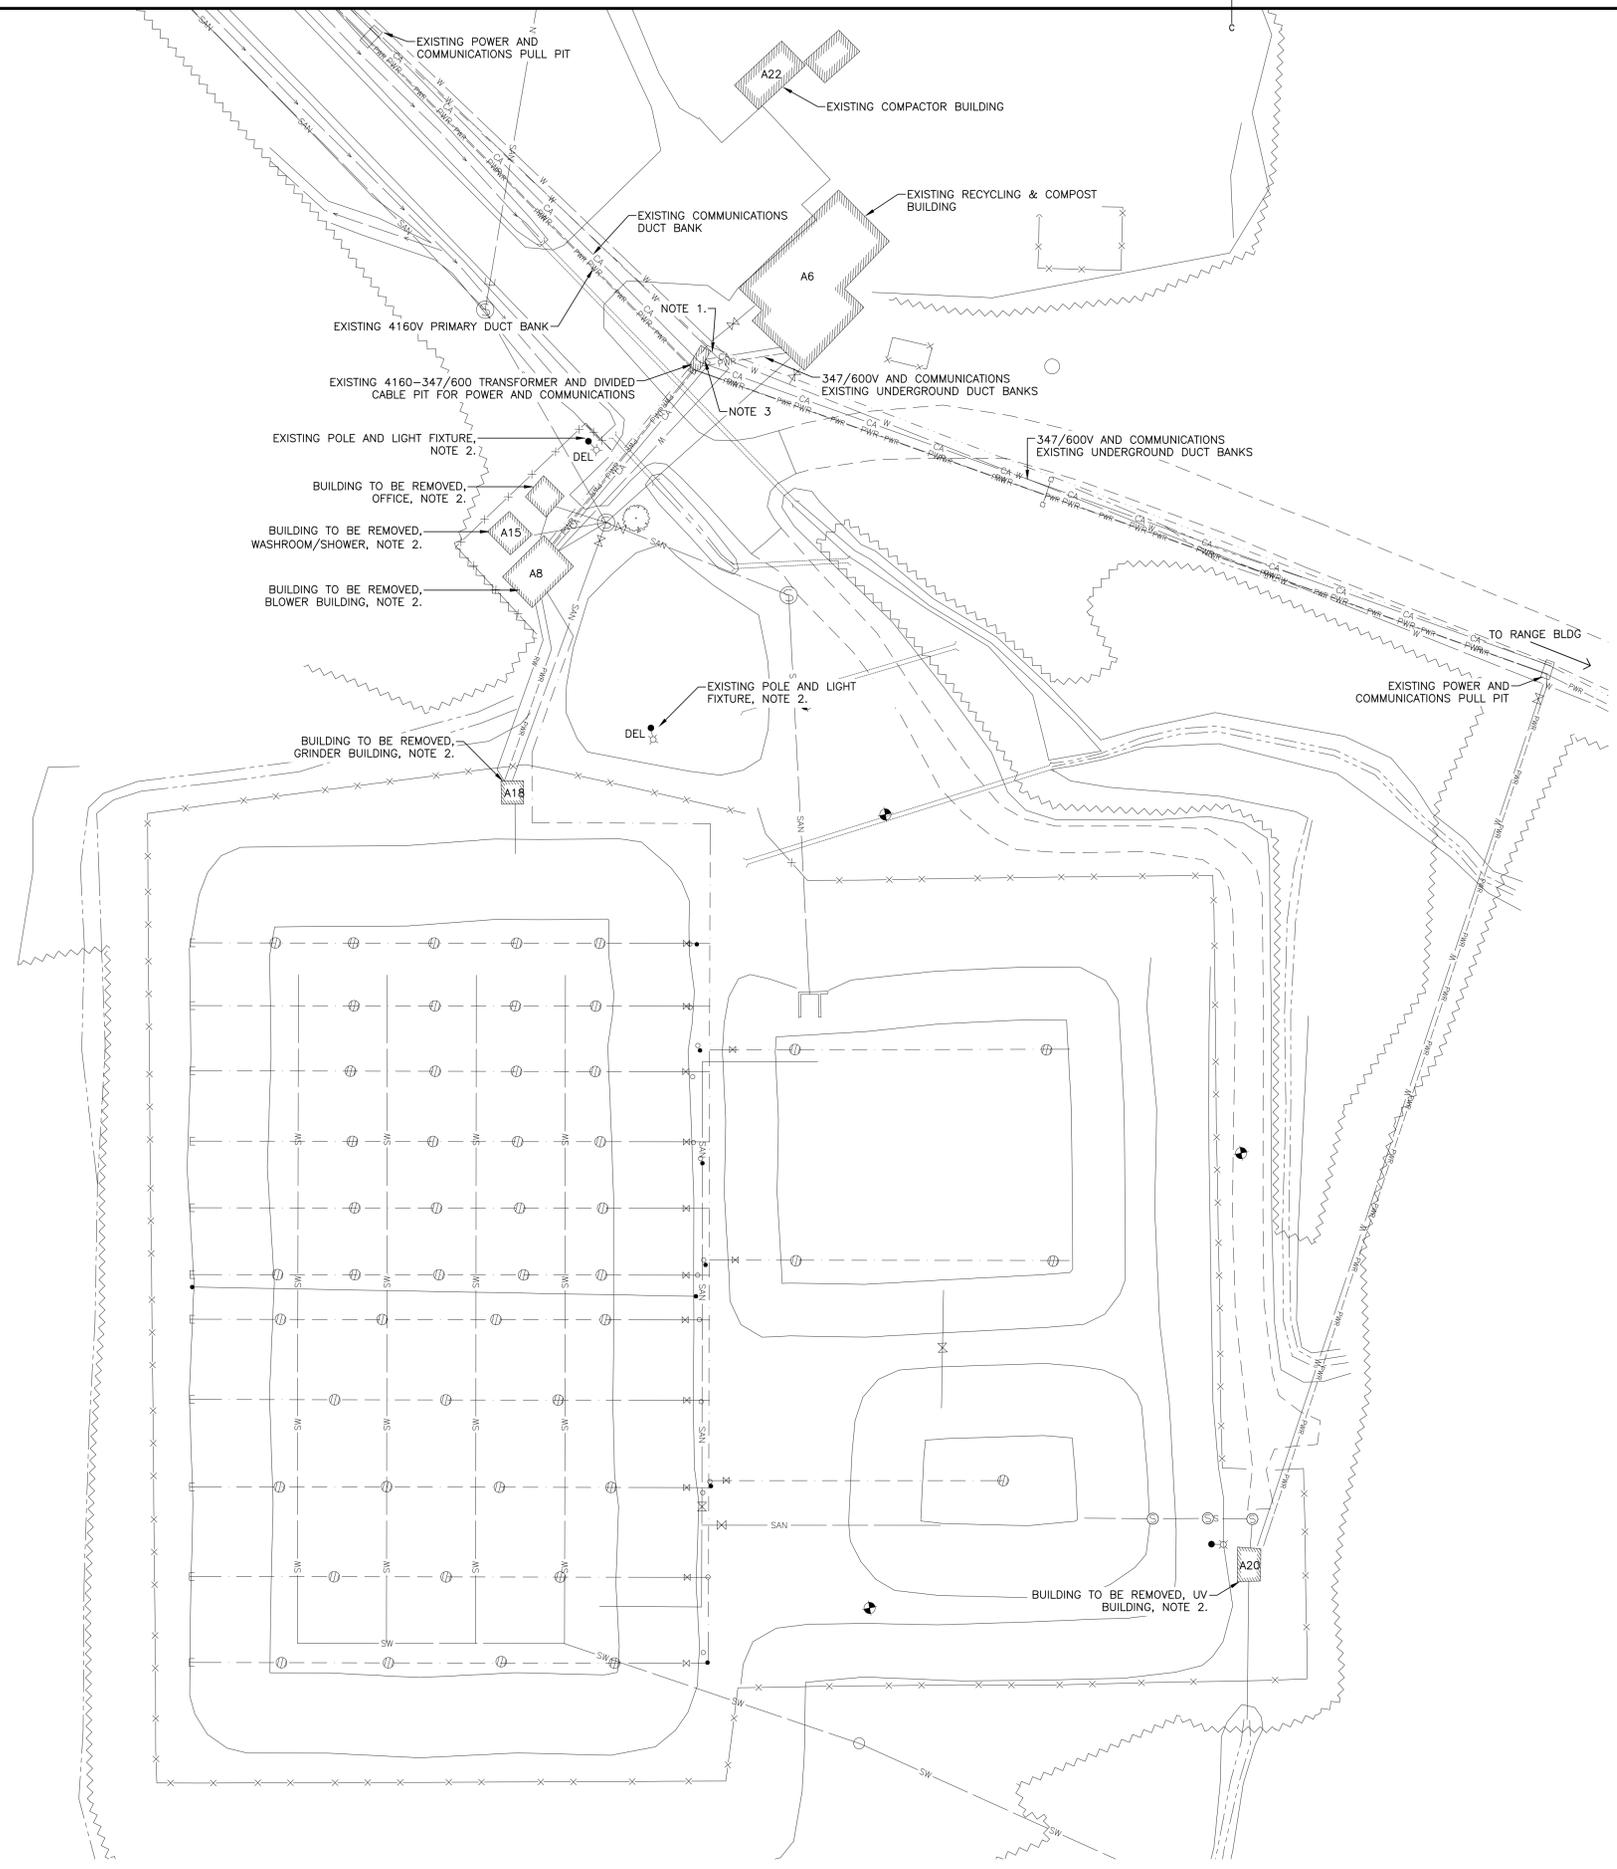

SITE PLAN - EXISTING

SCALE : 1:400

