


TYPICAL ADDITIONAL WALL  
REINFORCING AT PIPE PENETRATION

SCALE : 1:20


0mm 500mm 1000mm 1500mm 2000mm 2500mm

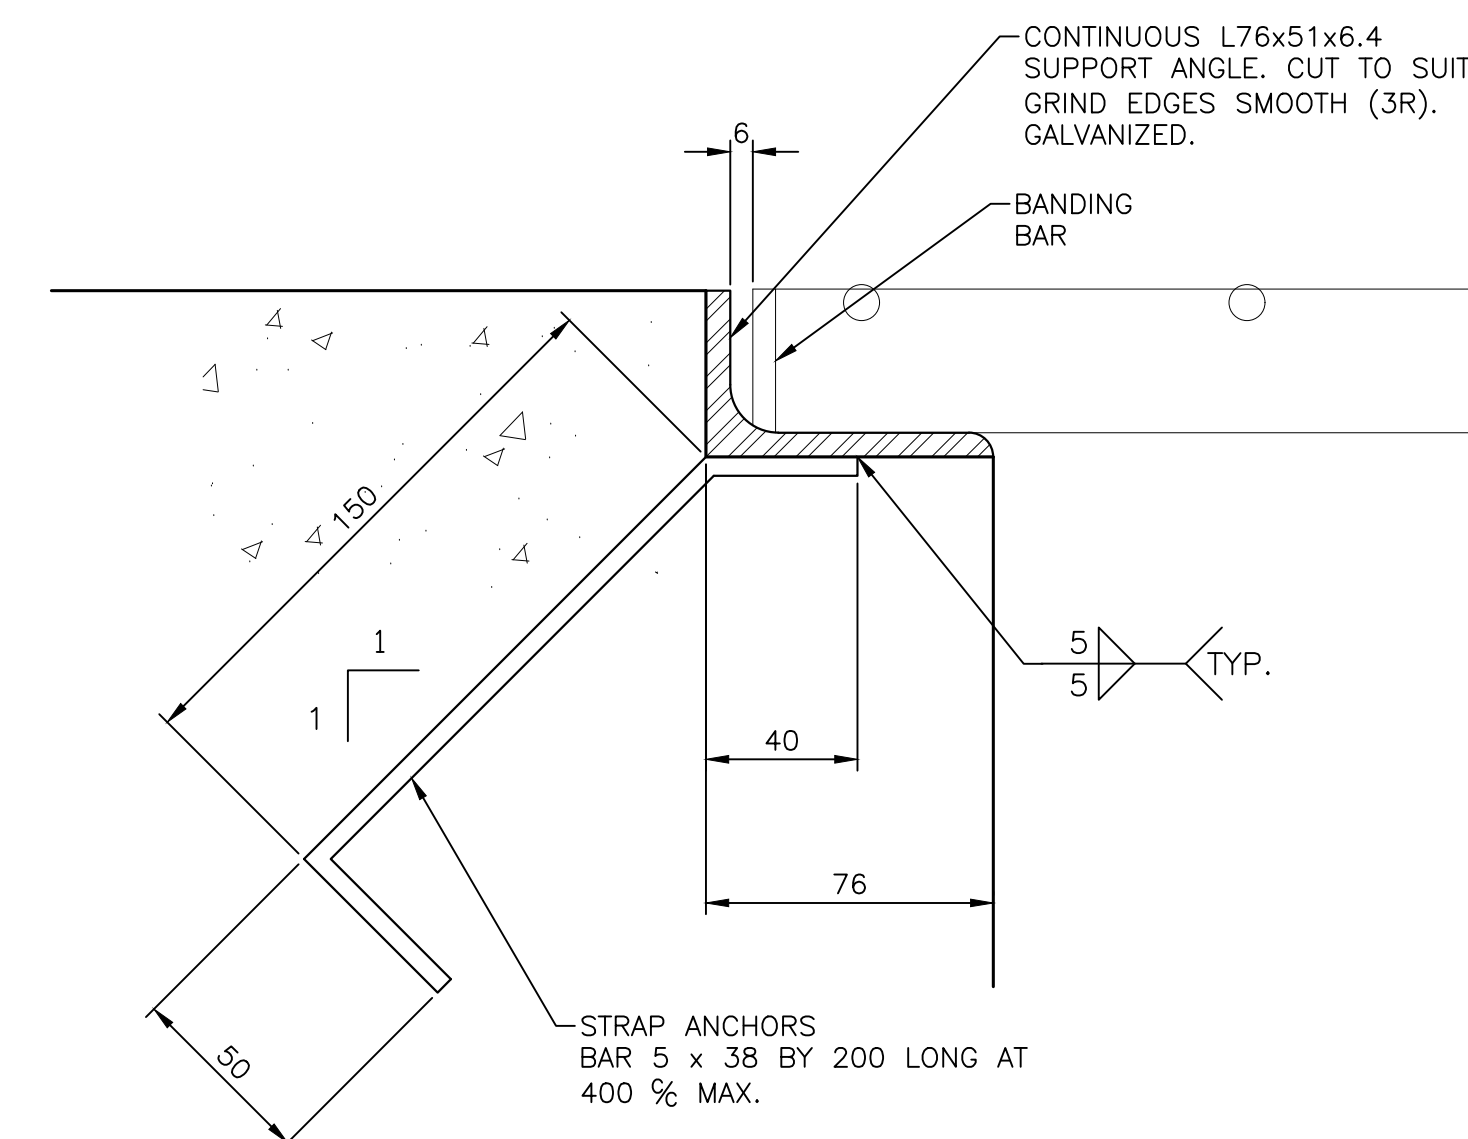

GRATING DETAIL

SCALE : 1:2


0mm 50mm 100mm 150mm 200mm 250mm

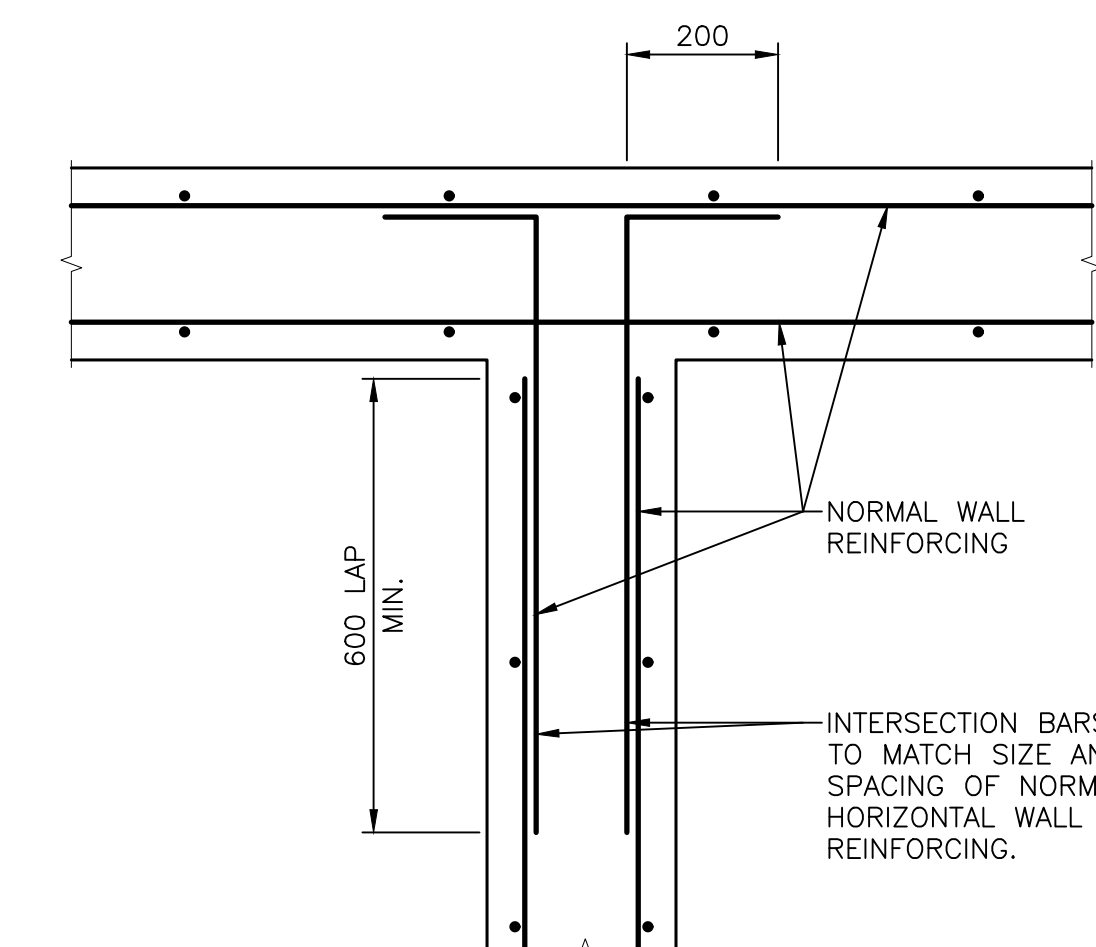

TYPICAL WALL INTERSECTION REINFORCING

SCALE : 1:10


0mm 100 200 300 400 500 600 700 800 900 1000mm

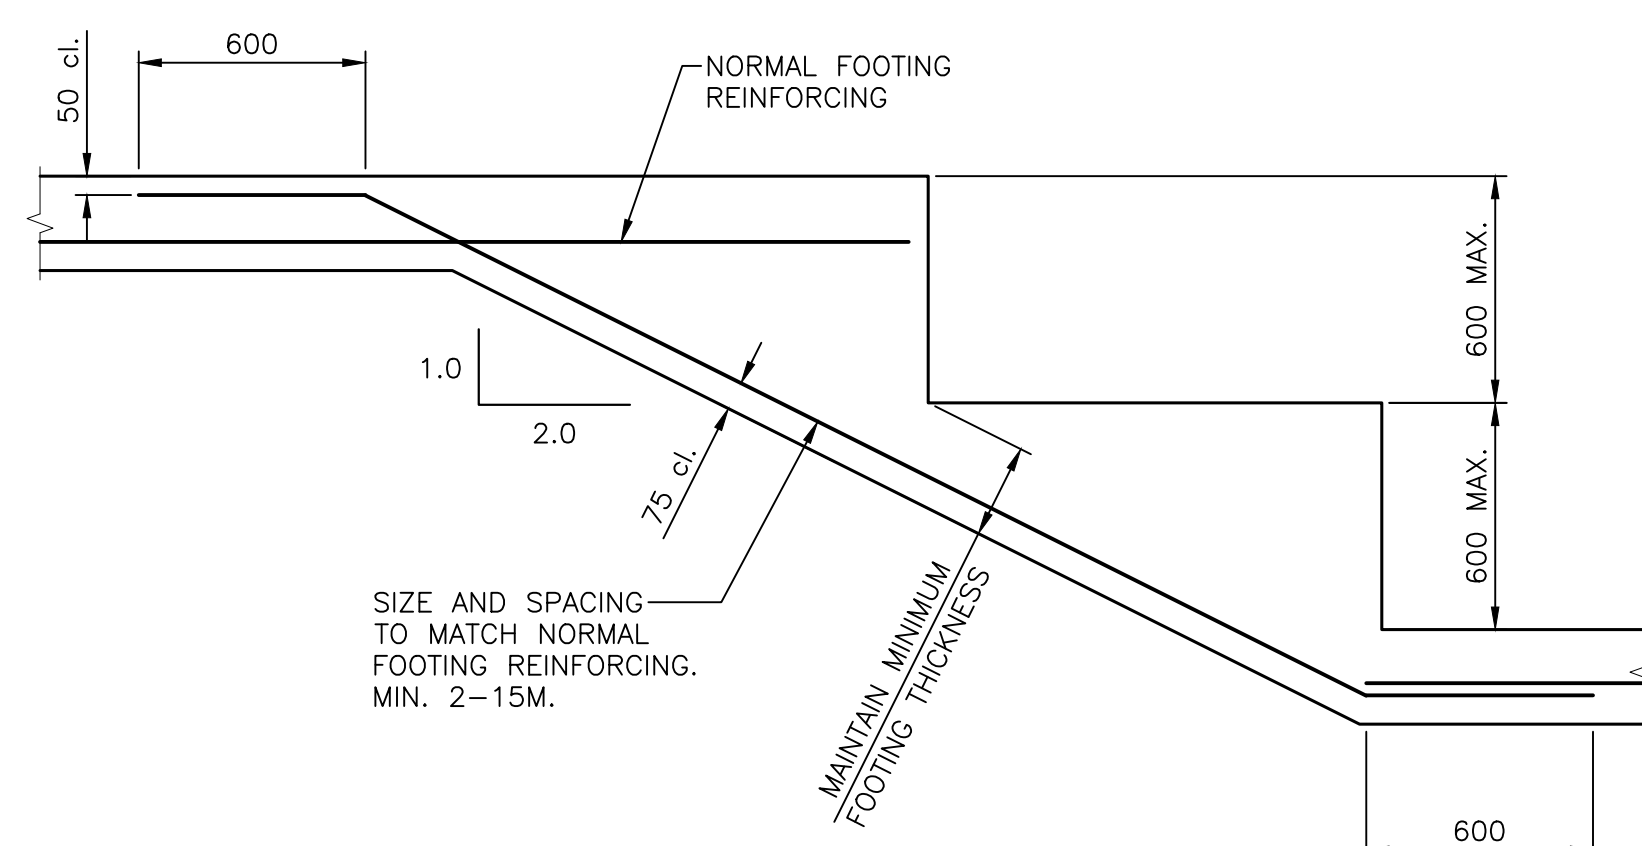

TYPICAL STEP FOOTING

SCALE : N.T.S.


01/03

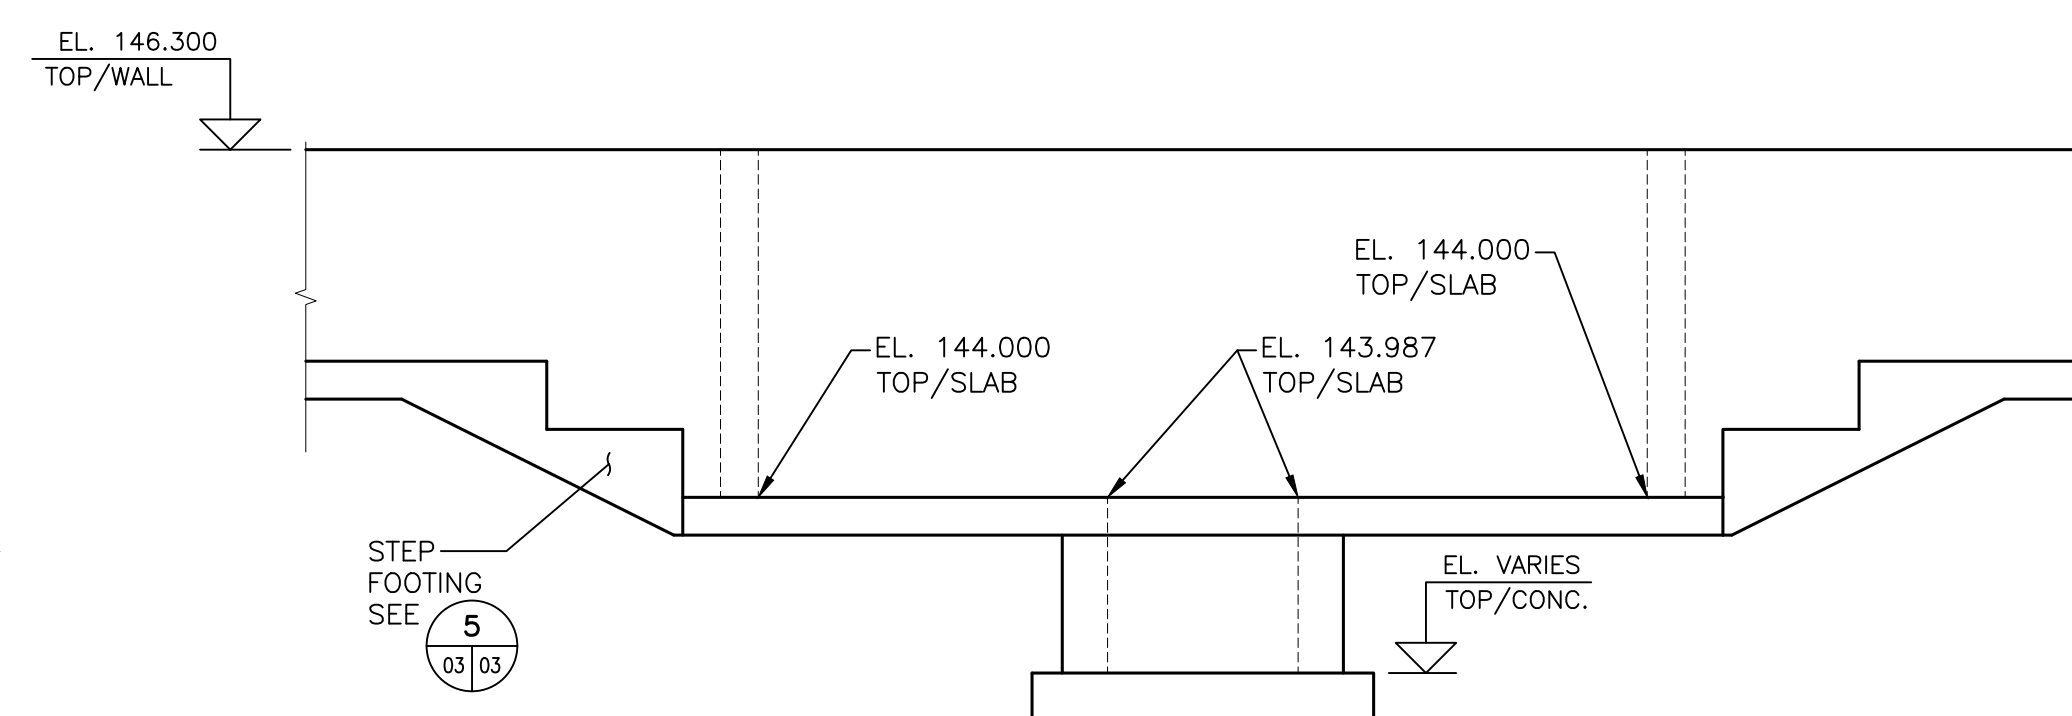

END WALL ELEVATION - UV ROOM

SCALE : 1:50


0m 1m 2m 3m 4m 5m

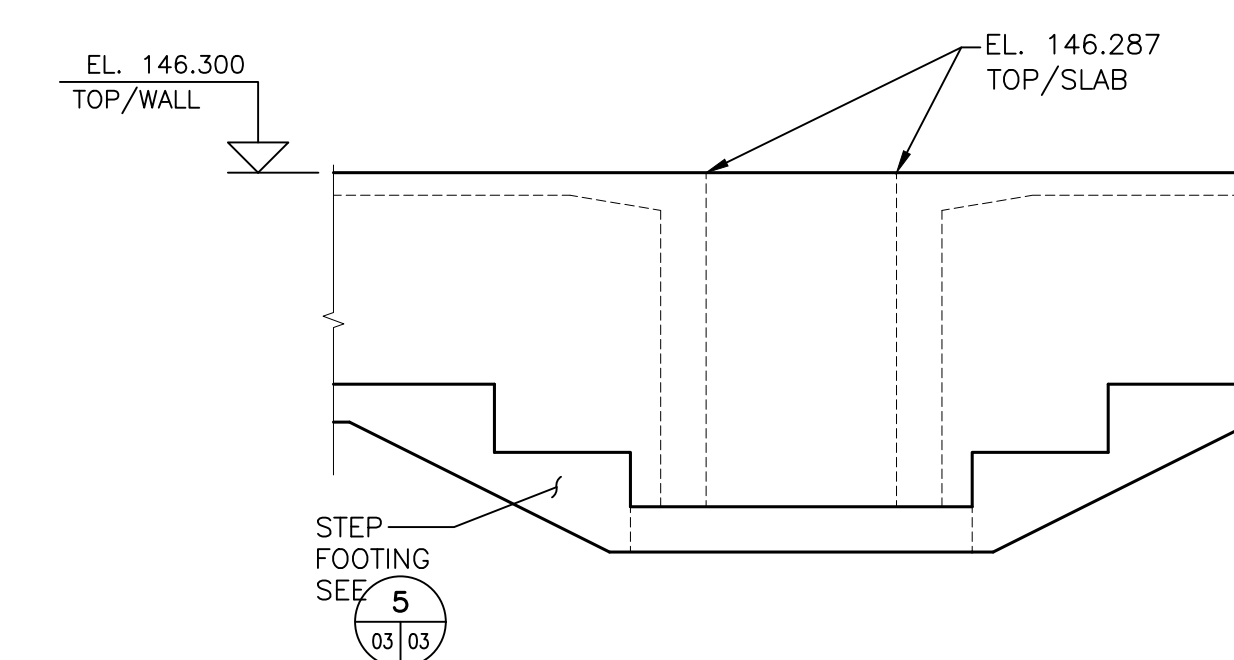

END WALL ELEVATION - HEADWORKS ROOM

SCALE : 1:50

0m 1m 2m 3m 4m 5m

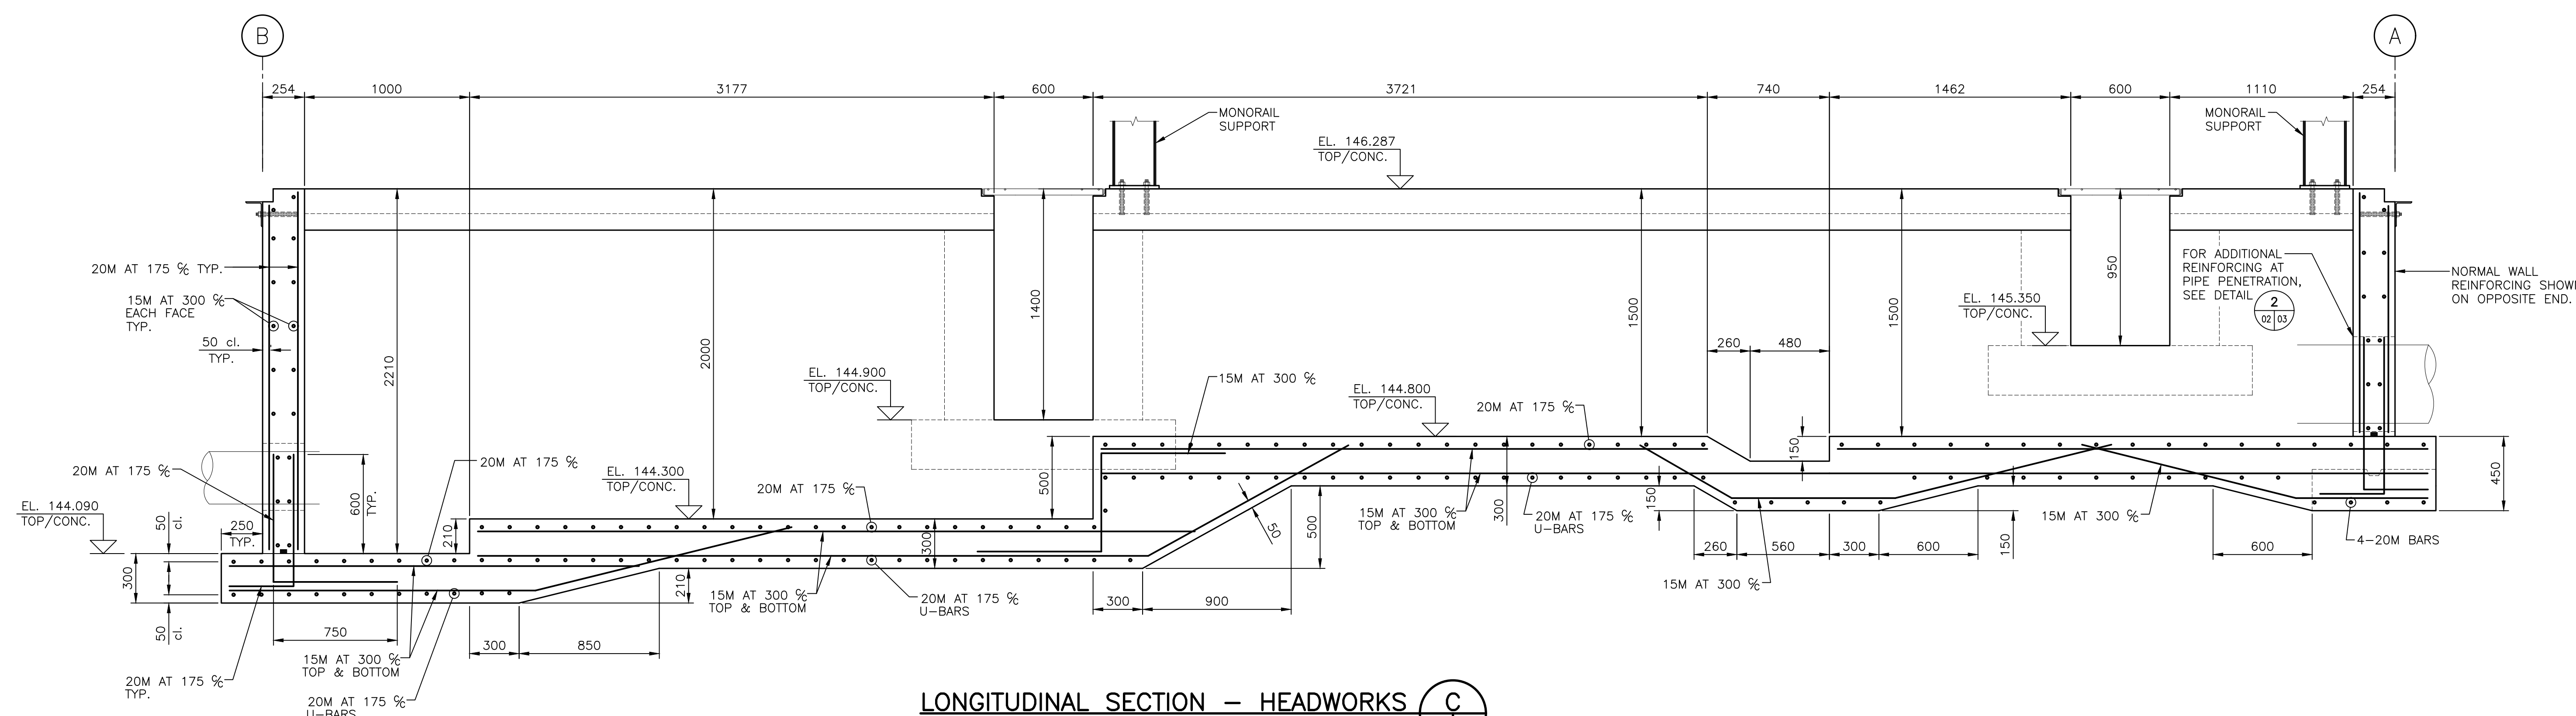

LONGITUDINAL SECTION - HEADWORKS

SCALE : 1:20

0mm 500mm 1000mm 1500mm 2000mm 2500mm

01/03



3	ISSUED FOR TENDER	04/14/2022
2	ISSUED FOR RS4 99% SUBMISSION	10-30/2020
1	ISSUED FOR RS4 66% SUBMISSION	06-14/2019
0	ISSUED FOR STATUS	JAN.4/2019
revisions		date

project

SEWAGE TREATMENT  
UPGRADES  
SPRINGHILL INSTITUTION  
SPRINGHILL, NS

drawing

TREATMENT BUILDING  
HEADWORKS ROOM  
FOUNDATION PLAN,  
SECTIONS AND DETAILS

designed RBV

conçu

date JAN. 2019

drawn RK

dessiné

date JAN. 2019

approved

approuvé

date

Tender

Soumission

PWGSC Project Manager

Administrateur de projets TPSGC

project number

no. du projet

R.061876.001

drawing no.

no. du dessin

S03