NRC BUILDING S77 - RM 4099 STEAM BOILER


100 SUSSEX DRIVE, OTTAWA, ON. MECHANICAL

	GENERAL LEGEND
SYMBOL	DESCRIPTION
	EXISTING PIPING/DUCTWORK/EQUIPMENT
	EXISTING PIPING/DUCTWORK/EQUIPMENT TO BE REMOVED/RELOCATED
	NEW/RELOCATED PIPING/DUCTWORK/EQUIPMENT
	EXISTING PIPING/DUCTWORK/EQUIPMENT BELOW SLAB
	NEW PIPING/DUCTWORK/EQUIPMENT BELOW SLAB
(E)	DENOTES EXISTING EQUIPMENT
(R)	DENOTES RELOCATED EQUIPMENT
(N)	DENOTES NEW EQUIPMENT
(X)	DENOTES EQUIPMENT TO BE REMOVED


	DRAWING LIST
SYMBOL	DESCRIPTION
6092-M01	MECHANICAL - DRAWING LIST, LEGENDS & KEY PLAN
6092-M02	MECHANICAL - SCHEDULES & DETAILS
6092-M03	MECHANICAL - RM 3052 - DEMOLITION AND NEW WORK
6092-M04	MECHANICAL - RM 4099 - DEMOLITION AND NEW WORK
6092-M05	MECHANICAL - RM 4099 - UTILITIES SCHEMATICS

	CONTROLS LEGEND									
SYMBOL	DESCRIPTION									
/*\	LOW VOLTAGE CONTROL WIRING									
T	TEMPERATURE SENSOR									

SYMBOL	DESCRIPTION
	PIPING BELOW GRADE/SLAB
— LPS ——	LOW PRESSURE STEAM
— LPC ——	LOW PRESSURE CONDENSATE
— HPS —	HIGH PRESSURE STEAM
— HPC ——	HIGH PRESSURE CONDENSATE
SAN	SANITARY
— CWS ——	CHILLED WATTER SUPPLY
— CWR ——	CHILLED WATER RETURN
— HWS ——	HEATING WATER SUPPLY
— HWR ——	HEATING WATER RETURN
— DCW ——	DOMESTIC COLD WATER
V	VENT PIPING
⊜ FD1	FLOOR DRAIN (TYPE)
— — —	PIPING OFFSET
	BRANCH PIPING DOWN
-	PIPING DOWN
<u> </u>	PIPING UP
→	REDUCER
—	FLOW DIRECTION
\$	PIPE BREAK
С	CAP
	P-TRAP
9	DRAIN ASSEMBLY
—ICO	CLEAN OUT
— ⊚C0	FLOOR CLEAN OUT
M 3 ^x	ISOLATION VALVES
⋈ NO	NORMALLY OPEN ISOLATION VALVE
⋈ NC	NORMALLY CLOSED ISOLATION VALVE
×	PRESSURE REDUCING VALVE (PRV)
₽ P	SOLENOID VALVE
及	TWO-WAY DDC CONTROL VALVE
\forall	STRAINER
~	CHECK VALVE
⋈	STOP CHECK VALVE
\bowtie	FLEXIBLE CONNECTION
IļI	UNION
⊳≵	RELIEF VALVE
MA	DRAIN VALVE C/W CAP & CHAIN
ρ ^τ	THERMOMETER
 ⊘PG X	PRESSURE GAUGE
\otimes	STEAM TRAP

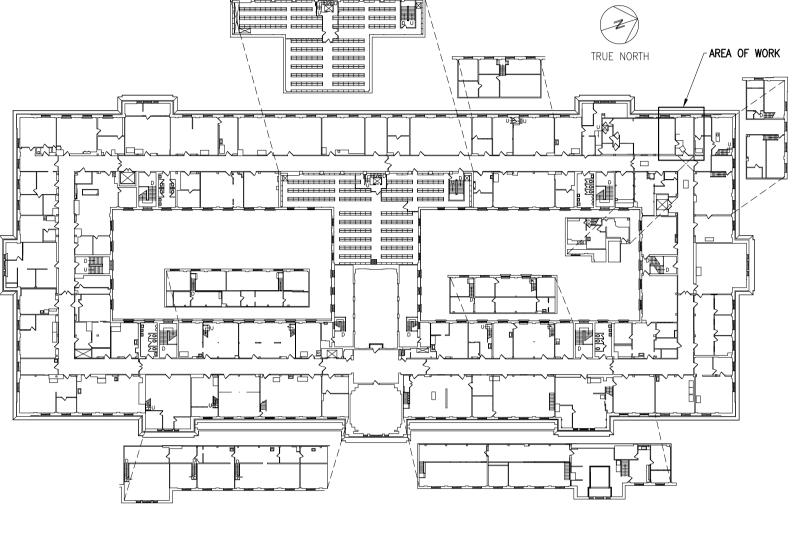



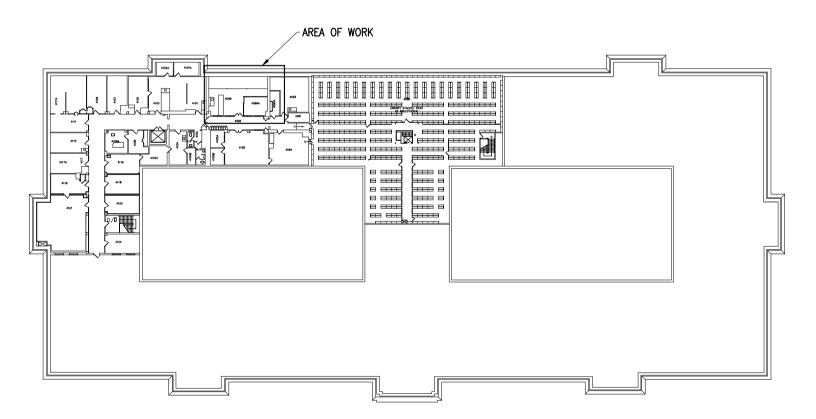



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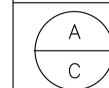
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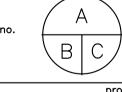
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A Detail no.
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sur dessin no.
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dessin no.



dessin

BUILDING S77 RM 4099 STEAM BOILER

100 SUSSEX DRIVE, OTTAWA, ON.

MECHANICAL DRAWING LIST, LEGENDS, AND KEY PLANS

designed		conçu	date		date
	R.L.				
drawn		dessiné	scale		échelle
	K.N.		AS NOTED/	COMME IND	DIQUÉ
checked		vérifié	sheet		feuille
	R.L.		of	/de _	
approved		approuvé	W.O.no.		D.T.no.
	R.L.				
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6092-M01

	CONTROL VALVE SCHEDULE												
EQUIPMENT	FLUID TYPE	VALVE TYPE	EQUIPMENT SERVED	INLET PRESSURE (PSI)	MAWP (PSI)	STEAM CAPACITY (LBS/HR)	VALVE SIZE (ØIN)	VALVE MAX P.D. (PSI)	CONTROL TYPE	BASIS OF DESIGN	VALVE FAILURE POSITION	ACTUATOR	
CV1	HPS	2-WAY	CHEMAP	36	40	40	1/2	5	OPEN/CLOSED	ARMSTRONG PYTHON CV1500	FAIL CLOSED	BELIMO-SVK	
CV2	HPS	2-WAY	NBS MF128S	72	80	68	1/2	5	MODULATING	ARMSTRONG PYTHON CV1500	FAIL CLOSED	BELIMO-SVK	
CV3	HPS	2-WAY	FDI FERMENTER	72	80	150	1/2	5	MODULATING	ARMSTRONG PYTHON CV1500	FAIL CLOSED	BELIMO-SVK	
CV4	HPS	2-WAY	NBS	72	80	68	1/2	5	MODULATING	ARMSTRONG PYTHON CV1500	FAIL CLOSED	BELIMO-SVK	
CV5	HPS	2-WAY	MBR	54	60	110	1/2	5	OPEN/CLOSED	ARMSTRONG PYTHON CV1500	FAIL CLOSED	BELIMO-SVK	
CV6	HPS	2-WAY	AUTOCLAVE	72	80	148	1/2	5	OPEN/CLOSED	ARMSTRONG PYTHON CV1500	FAIL CLOSED	BELIMO-SVK	
CV7	HPS	2-WAY	STERILIZER	45	50	60	1/2	5	OPEN/CLOSED	ARMSTRONG PYTHON CV1500	FAIL CLOSED	BELIMO-SVK	
NOTES: 1.	FOR DETAIL	S REFER TO	SPECIFICATIONS.										

CONDENSATE COOLER SCHEDULE												
TAG	FLOOR	ROOM	MAX CONDENSATE FLOW (GPM)	CONDENSATE INLET SIZE (IN)	CONDENSATE OUTLET SIZE (IN)	COLD WATER INLET SIZE (IN)	BASIS OF DESIGN	REMARKS				
CC1	4	ROOM 4099	5	3/4	1 1/4	1/2		* ASTM A48 CAST IRON BODY * CONDENSATE DISCHARGE TEMPERATURE TO BE SET TO 135°F MAX.				

					OUCT HEATER	R SCHEDULE		
T10	FLOOR	50014	AIR FLOW	CAPACITY	DUCT CONNECTION	ELECTRICAL DATA	DAGIO OF DEGICAL	DEL UDIO
TAG FLOOR	ROOM	(CFM)	(kW)	SIZE (LxW)(IN)	V/PH/Hz	BASIS OF DESIGN	REMARKS	
DH-1			2051	9	18 x 15	600/3/60	NAILOR DHRS	* DUCT HEATERS TO BE SUPPLIED AND INSTALLED BY DIV.23, WIRED BY DIV.26. CONTROLS BY DIV.25.
DH-2	3	ROOM 3053	8799	36	46 x 28	600/3/60	NAILOR DHRS	* C/W SCR CONTROL, INTEGRAL DISCONNECT SWITCH * DUCT CONNECTION SIZE LISTED IS APPROXIMATE.
DH-3			1422	6	16 x 10	600/3/60	NAILOR DHRS	MEASURE EXACT DUCT SIZE AT COIL LOCATION ON SITE, AND SUBMIT NEW COILS TO SUIT.

CONNECTION INLET P			
TAC I LOCATION I FUNCTION I TYPE I PRESSURE I	PRESSURE DROP (kPa)	BASIS OF DESIGN	REMARKS
BFP1 ROOM 4099 BOILER FEEDWATER REDUCED PRESSURE 1/2 -	-	WATTS 009QT-S	* C/W STRAINER * RELIEF PIPED TO NEAREST DRAIN

	PRV & SRV SCHEDULE												
			PRV						SF	?V			
PRV TAG	EQUIPMENT SERVED	INLET PRESSURE (PSI)	OUTLET PRESSURE (PSI)	STEAM CAPACITY (LBS/HR)	VALVE SIZE (ØIN)	BASIS OF DESIGN	SRV TAG	EQUIPMENT SERVED	MAWP (PSI)	RELIEF PRESSURE SETPOINT (PSI)	RELIEF CAPACITY (LBS/HR)	VALVE SIZE (ØIN)	
PRV1	CHEMAP	90	36	40	1/2	ARMSTRONG GP-2000	SRV1	CHEMAP	40	40	40	1/2	
PRV2	NBS MF128S	90	72	68	1/2	ARMSTRONG GP-2000	SRV2	NBS MF128S	80	80	68	1/2	
PRV3	FDI FERMENTER	90	72	150	1/2	ARMSTRONG GP-2000	SRV3	FDI FERMENTER	80	80	150	1/2	
PRV4	NBS	90	72	68	1/2	ARMSTRONG GP-2000	SRV4	NBS	80	80	68	1/2	
PRV5	MBR	90	54	110	1/2	ARMSTRONG GP-2000	SRV5	MBR	60	60	110	1/2	
PRV6	AUTOCLAVE	90	72	148	1/2	ARMSTRONG GP-2000	SRV6	AUTOCLAVE	80	80	148	1/2	
PRV7	STERILIZER	90	45	60	1/2	ARMSTRONG GP-2000	SRV7	STERILIZER	50	50	60	1/2	
PRV8	STEAM BOILER	100	90	307	1/2	ARMSTRONG GP-2000	_	_	_	_	_	_	

	STEAM BOILER												
TAC	LO	CATION	PHYSICAL	DATA	STEAM OUTPUT	DESIGN PRESSURE	OPERATING PRESSURE	INCOMING WATER SUPPLY PRESSURE	ELEC	CTRICAL DATA	DACIC OF DECION	DEMADICO	
TAG	FLOOR	ROOM	DIMENSIONS (LxWxH)(IN)	WEIGHT (LBS)	(LBS/HR)	(PSI)	(PSI)	(PSI)	KW	V/PH/Hz	BASIS OF DESIGN	REMARKS	
B1	4	ROOM 4099	38x32x58	625	307	100	90	ATMOSPHERIC FEEDWATER TANK	105	600/3/60	CHROMALOX CES-102 LW 600/3 102KW	* CARBON STEEL VESSEL, INCOLOY ELEMENTS, MECHANICAL FLOAT LEVEL CONTROL, ASME. * C/W HIGH PRESSURE WATER FEED PUMP ES38020 (#300178004), BLOWDOWN SEPARATOR CBS-1	

EXPANSION TANK SCHEDULE												
TAG	LOCATION	FUNCTION	TYPE	OPERATING PRESSURE		OPERATING TEMPERATURE				ORIENTATION (HORIZONTAL/	BASIS OF DESIGN	REMARKS
IAG	LOCATION	FUNCTION	(DIAPHRAGM/ BLADDER)	MIN (PSI)	MAX (PSI)	MIN (°F)	MAX (°F)	(L)	VOLUME (L)	VERTICAL)	DASIS OF DESIGN	NEWARKS
ET1	ET1 RM. 4099 BOILER FEEDWATER DIAPHRAGM 20 125 50 75 24.2 12.1 VERTICAL AMTROL AX-10-DD * ASME, NON-POTABLE WATER											
	NOTES: 1. FOR DETAILS REFER TO SPECIFICATIONS.											

	WATER SOFTENER SYSTEM SCHEDULE												
TAO			MAX SUPPPLY	MAX TEMPERATURE	SOFTEN	ENER TANK BRINE TANK DIMENSIONS				ELECTRICAL	BASIS		
TAG	TAG FLOOR ROOM	ROOM	PRESSURE (PSI)	(°F)	QUANTITY	DIMENSION (Ø X H)(IN)	HARDNESS (ppm as CaCO3)	TDS (ppm)	рН	V/PH/Hz	OF DESIGN	REMARKS	
WTS1	4	ROOM 4099	125	100	2	9 x 48	18.1 x 34.5	0 - 0.3	2200 – 2800	8.5 – 10	115/1/60	CANATURE 85TA-30	* SOFTENER SYSTEM TO BE C/W PIPING MANIFOLD AND ELECTRONIC CONTROL VALVE WITH METER * MINERAL TANKS TO BE NSF/ANSI 44 CERTIFIED FOR MATERIALS AND STRUCTURAL INTEGRITY.
	OTES: 1. FOR DETAILS REFER TO SPECIFICATIONS. 2. CONTRACTOR TO SUPPLY AT TIME OF PROJECT CLOSEOUT (AFTER COMMISSIONING AND STARTUP OF THE SYSTEM) 30 (20KG) ADDITIONAL BAGS OF APPROVED SOFTENER SALT.												

AIR VELOCITY SENSOR
SUPPLY AIR TEMPERATURE SENSOR

SAT

ROOM TEMPERATURE
AI

SCR MODULATION
AC

STATUS
BI

NOTES:

1. AIR VELOCITY SENSOR SUPPLIED WITH DUCT HEATER AND INSTALLED BY DIV 23, WIRING BY DIV 25.

ELECTRIC DUCT HEATER CONTROL SEQUENCE


AIR TEMPERATURE, AND SPACE

HEATER TO MAINTAIN SPACE TEMPERATURE SETPOINT.

1. BAS TO MONITOR STATUS, DISCHARGE

TEMPERATURE, AND MODULATE DUCT



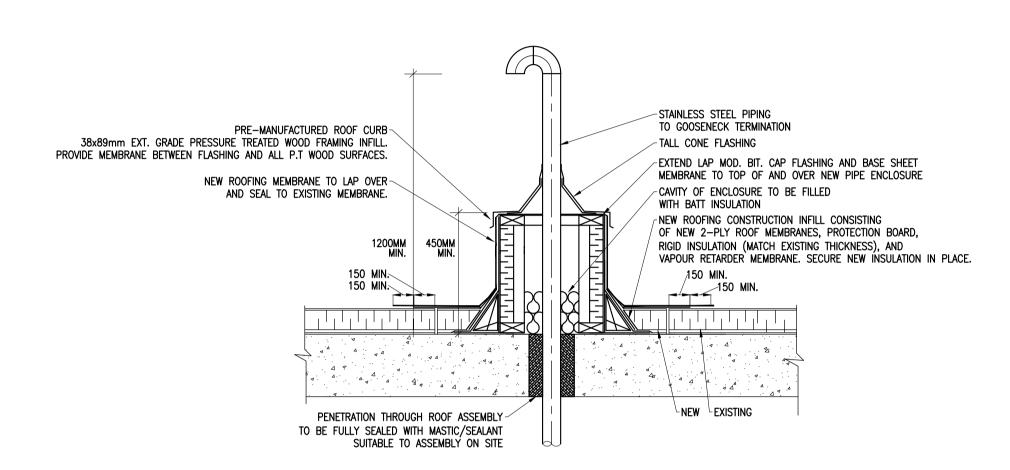



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Canada K2C 3R8

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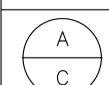
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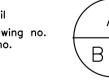
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BUILDING S77 RM 4099 STEAM BOILER

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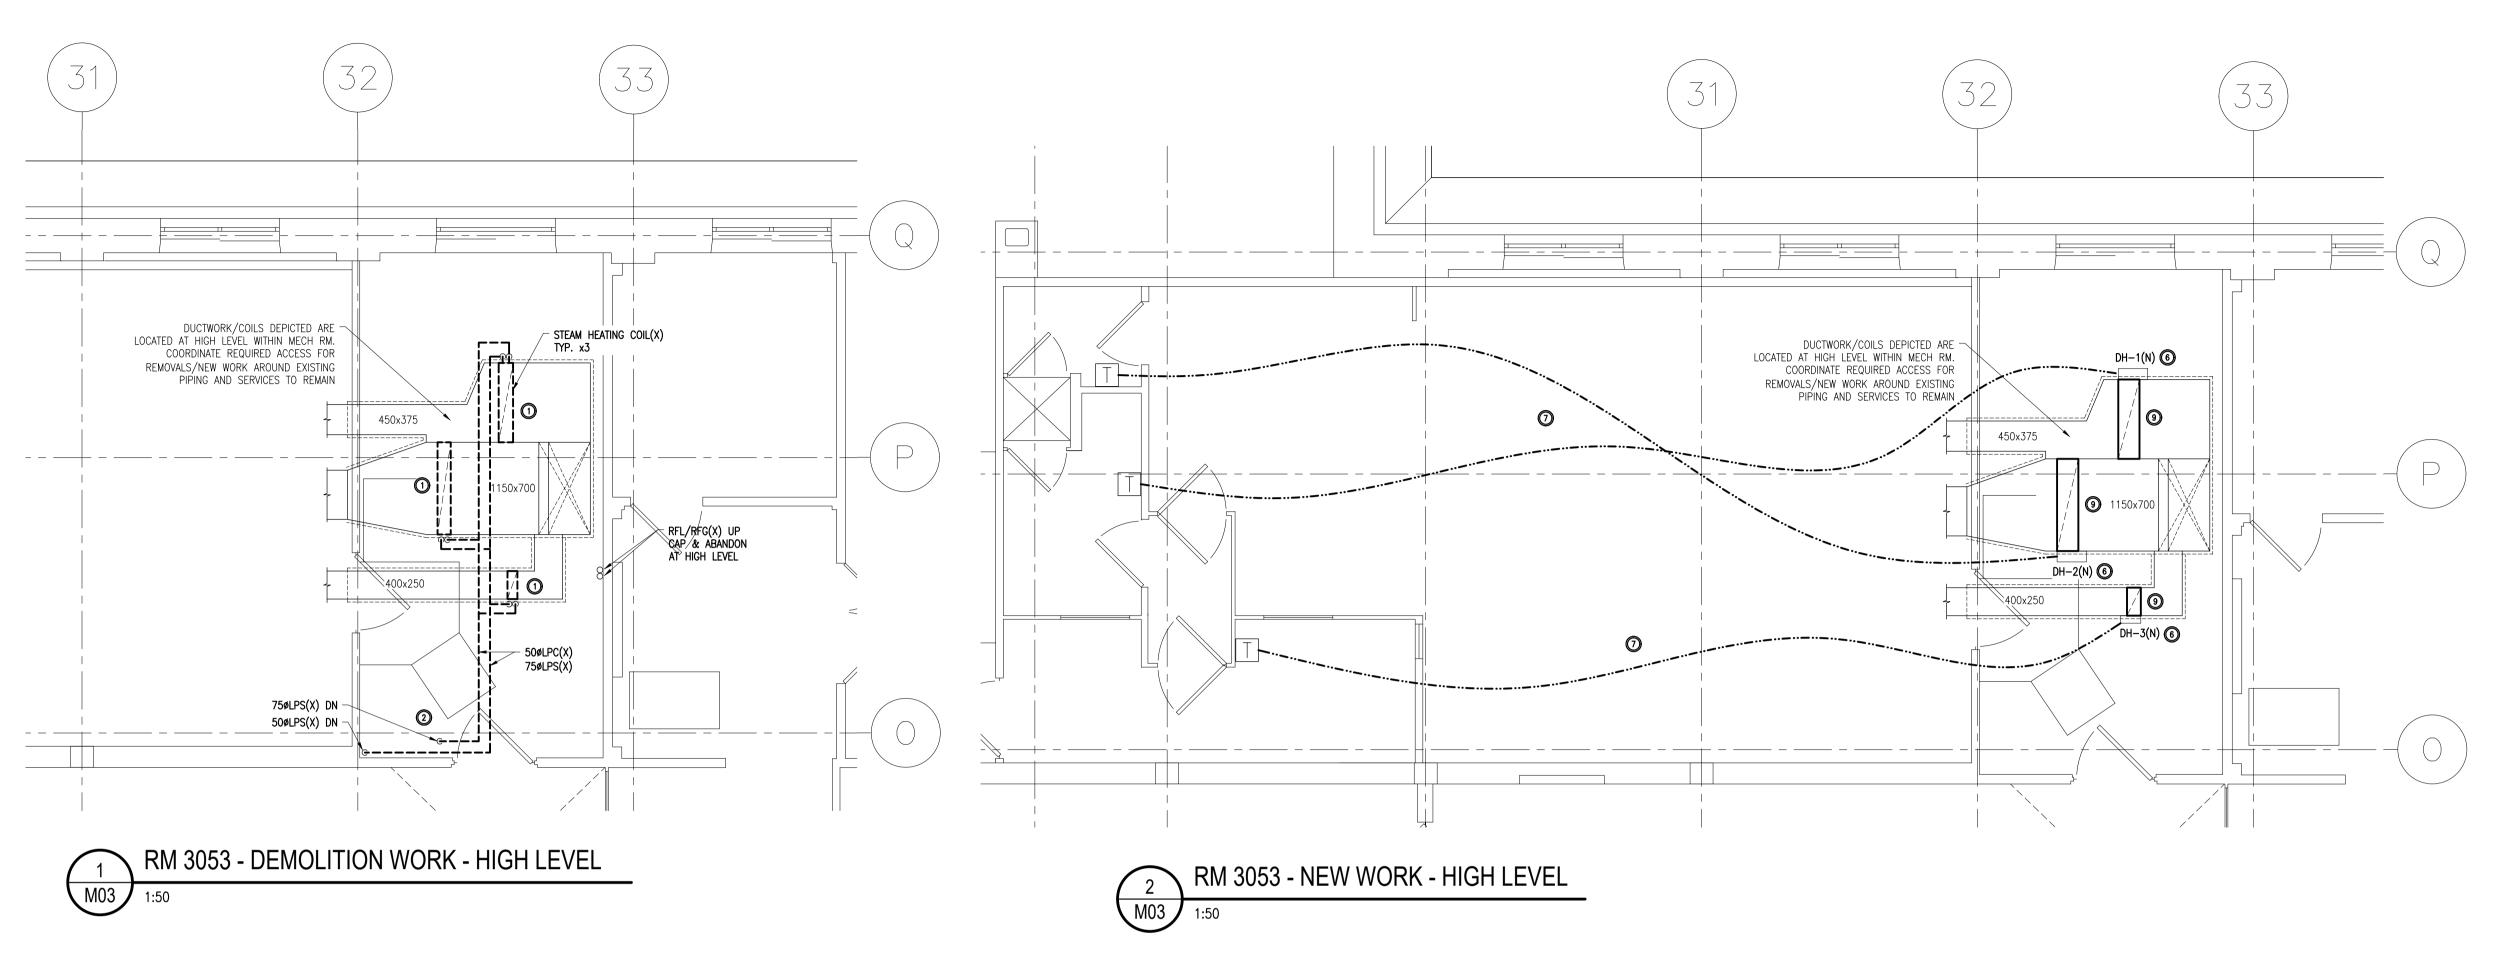
MECHANICAL

MECHANICAL SCHEDULES AND DETAILS

designed		conçu	date	date
	R.L.			
drawn		dessiné	scale	échelle
	K.N.		AS NOTED/COM	ME INDIQUÉ
checked		vérifié	sheet	feuille
	R.L.		of/de	_
approved		approuvé	W.O.no.	D.T.no.
	R.L.			
1				
dwg.no.				dessin no.

6092-M02

10 20mm 40 60 80 100 120 140 160 180 200m



DX COOLING COIL(X) HILLED WATER COIL(E) -CHWS/CHWR(E) -RFL/RFG(X) — UP TO 4TH FLOOR ROOF PENETRATION SRV VENT TO ATM(X) 50øLPS(X) -– 75øLPS(X) UP 50øLPS(X) UP -


RM 3053 - DEMOLITION WORK - LOW LEVEL

DESCRIPTION OF WORK

- REMOVE EXISTING STEAM HEATING COILS IN HIGH LEVEL SUPPLY AIR DUTCWORK AS INDICATED C/W ALL ASSOCIATED STEAM/CONDENSATE PIPING, TRAPS, VALVES, CONTROLS, AND ACCESSORIES.
- REMOVE EXISTING STEAM AND CONDENSATE PIPING AS INDICATED C/W ASSOCIATED TRAPS, VALVES, CONTROLS, AND RELATED ACCESSORIES. CAP CONDENSATE PIPING AT LOW LEVEL. REMOVE LOW PRESSURE STEAM PIPING, PREVIOUSLY SERVING COILS, BACK TO TAKEOFF AT HPS RISER AND CAP. COORDINATE WORK AND ANY REQUIRED ISOLATION/SHUTDOWNS WITH NRC DEPARTMENTAL REPRESENTATIVE.
- REMOVE EXISTING DECOMMISSIONED DX COOLING COIL FROM LOW LEVEL AHU RETURN DUCTWORK AS INDICATED C/W ALL ASSOCIATED REFRIGERANT PIPING, VALVES, CONTROLS, AND ACCESSORIES. PIPING TO BE REMOVED BACK TO CEILING/ROOF PENETRATION AND CAPPED/ABANDONED IN PLACE. EXISTING CHILLED WATER COOLING COIL AND ALL ASSOCIATED PIPING AND CONTROLS TO REMAIN. ALLOW FOR REMOVAL OF DUCTWORK/TRANSITIONS UP AND DOWNSTREAM OF DX COIL AS REQUIRED TO SUIT REMOVALS. PROVIDE NEW DUCTWORK AND INSULATION FOLLOWING REMOVAL OF COIL
- COORDINATE WITH DEPARTMENTAL REPRESENTATIVE FOR ALL REQUIRED DISCONNECTIONS, ISOLATIONS, SHUTDOWNS, AND PHASING REQUIRED THROUGHOUT SCOPE OF WORK.
- PROVIDE NEW ELECTRIC DUCT HEATING COILS AS INDICATED. MODIFY DUCTWORK UP AND DOWNSTREAM OF HEATING COILS AS REQUIRED TO SUIT NEW COIL INSTALLATION. CONTRACTOR IS REQUIRED TO MAKE ALL NECESSARY MODIFICATIONS TO ALLOW FOR THE INSTALLATION/SERVICEABILITY OF THE NEW DUCT HEATERS. DUCT HEATERS TO BE INSTALLED BY MECHANICAL CONTRACTOR AND WIRED BY ELECTRICAL, REFERENCE DUCT HEATER SCHEDILE ON DRAWING.

(5) PATCH, SEAL, AND MAKE GOOD ANY OPENINGS REMAINING FROM REMOVED PIPING.

- PROVIDE NEW CONTROL WIRING FROM DUCT HEATERS TO ASSOCIATED ROOM TEMPERATURE SENSORS LOCATED WITHIN PATH LAB. COORDINATE EXACT LOCATIONS ON
- (8) SIGNAGE/NOTES TO BE PLACED ON BAS, AHU, AND ENTRANCE TO PATH LAB INDICATING THAT EQUIPMENT/LAB IS NOT CAPABLE TO OPERATE AS A LEVEL 2. 4 ALLOW FOR PATCHING AND REPAIRING OF ALL INSULATION AFFECTED BY EXECUTION OF WORK INCLUDING CHILLED WATER PIPING, DUCTWORK, AND ASSOCIATED PIPING WHETHER NEW, MODIFIED, EXISTING, OR DAMAGED DURING EXECUTION OF WORK.

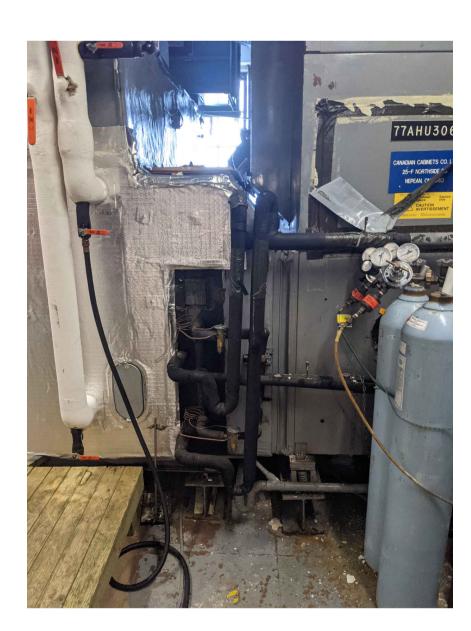

RM-3053 EXISTING DX COIL TO REMOVE



RM-3053 EXIST. HIGH ELVEL LPS/LPC PIPING M03

Planification et gestion

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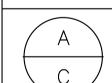
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sur dessin no.

dessin

C Drawing no. dessin no. **BUILDING S77**

RM 4099 STEAM BOILER


100 SUSSEX DRIVE, OTTAWA, ON. drawing


MECHANICAL RM 3053


DEMOLITION AND NEW WORK

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approved		approuvé	W.O.no.	D.T.no.
	R.L.			
dwg.no.				dessin no.

6092-M03

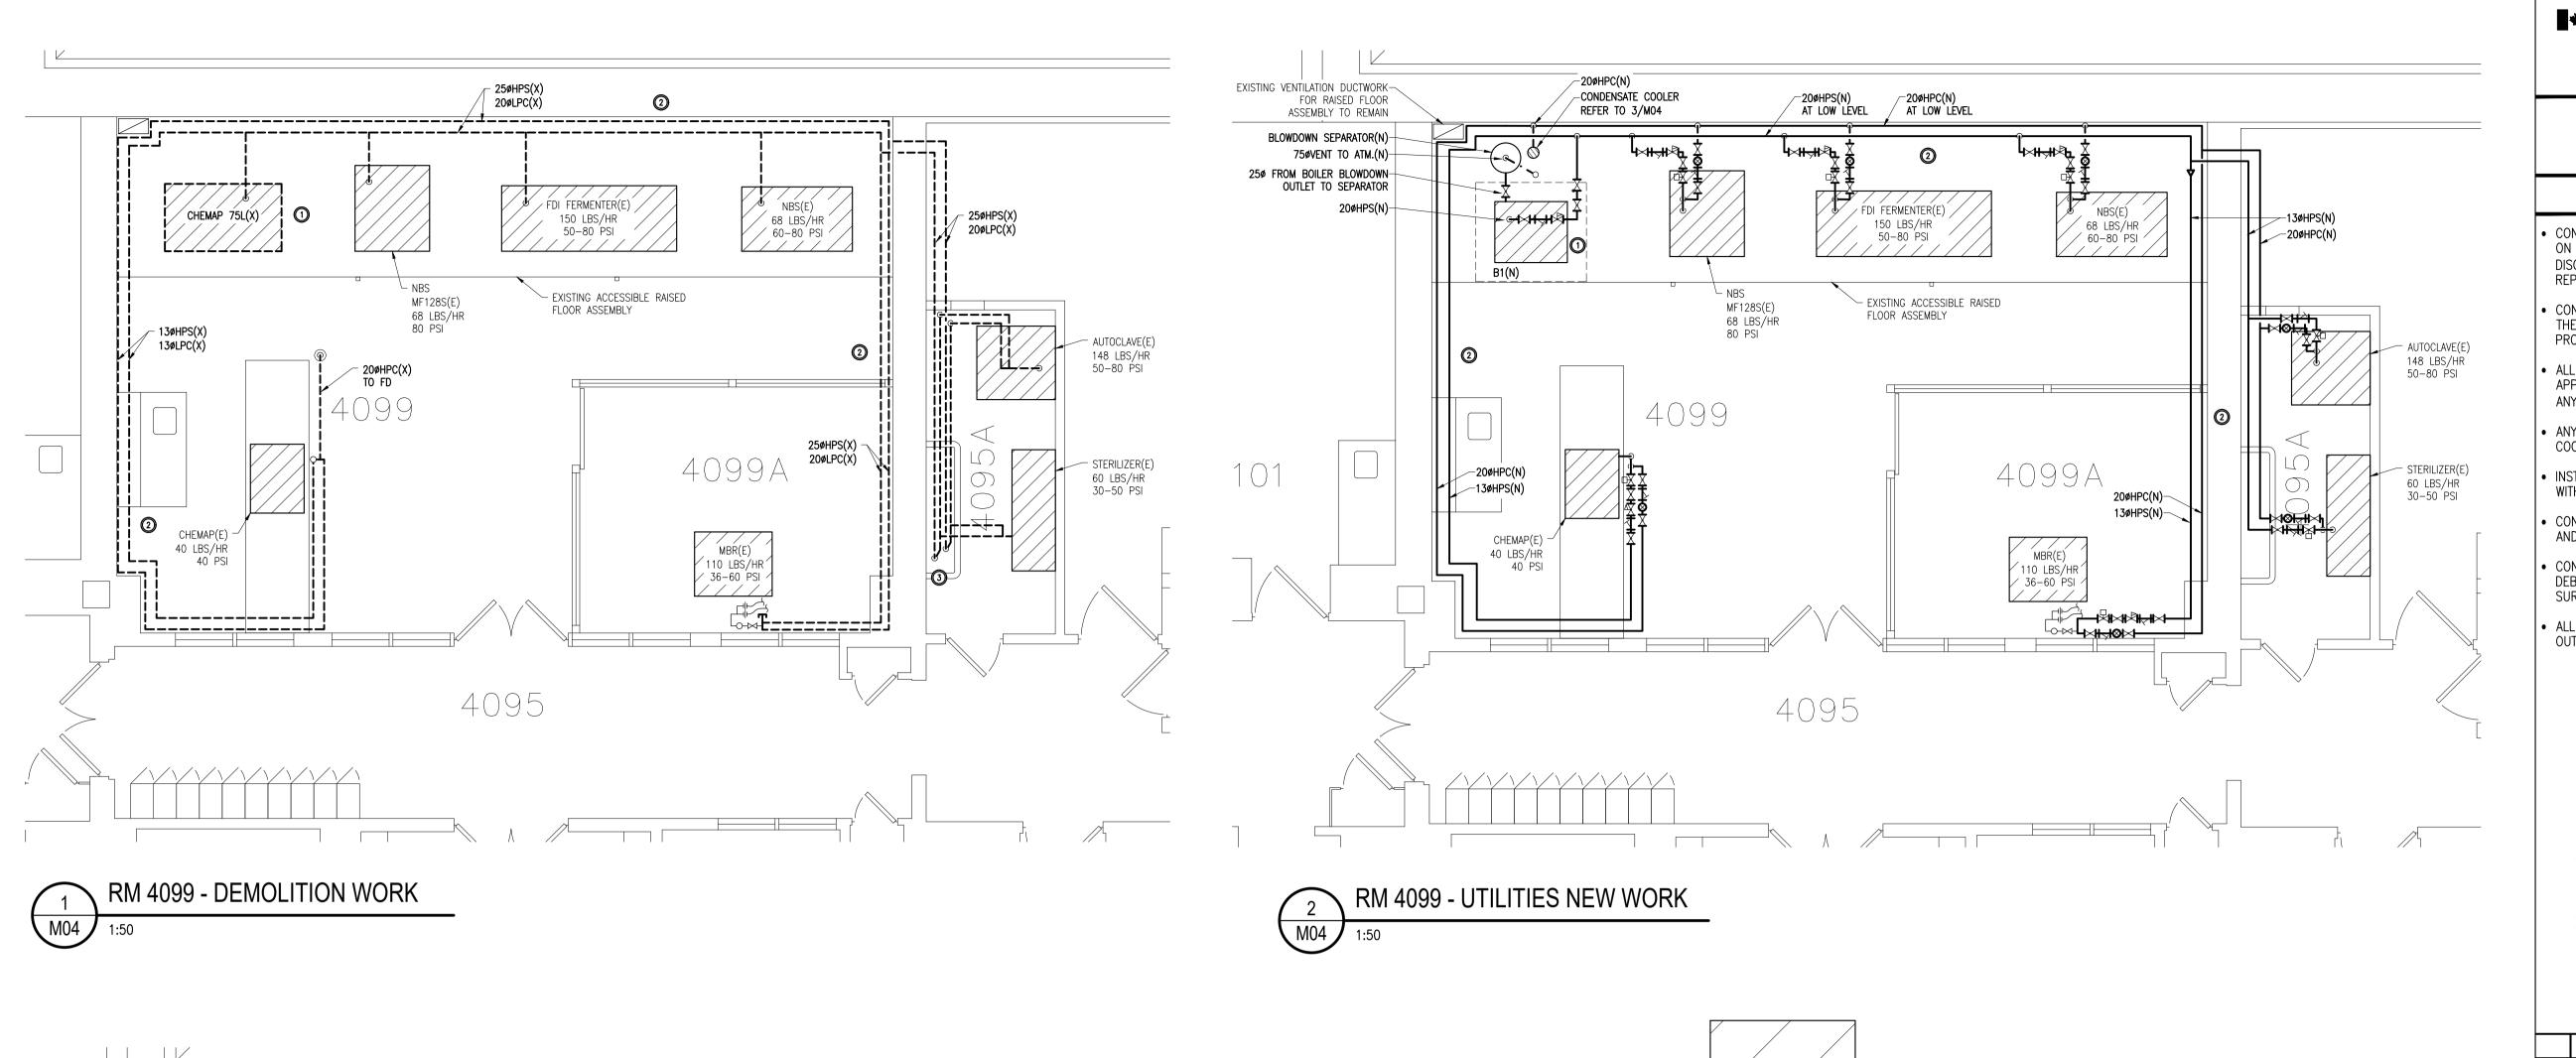

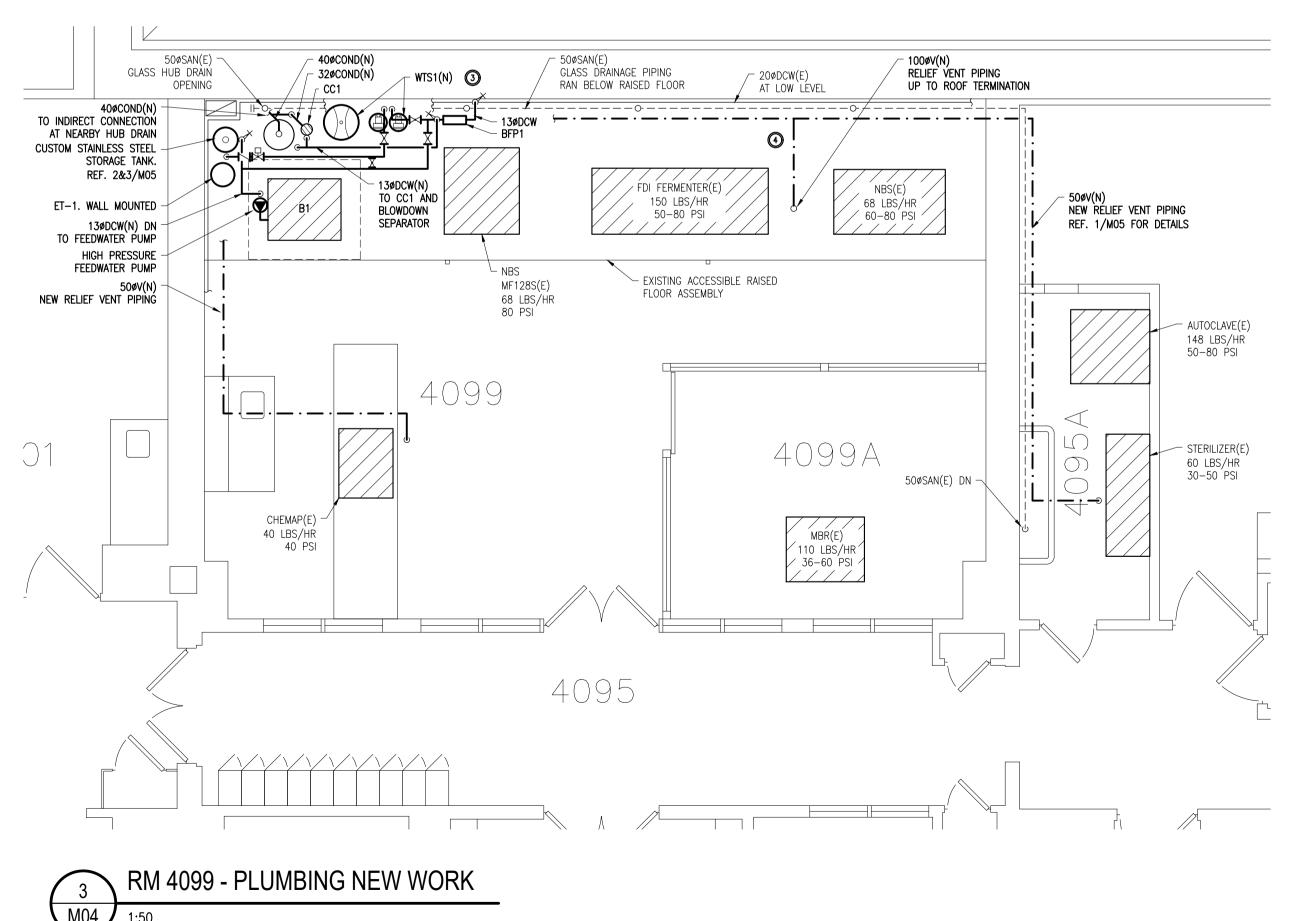

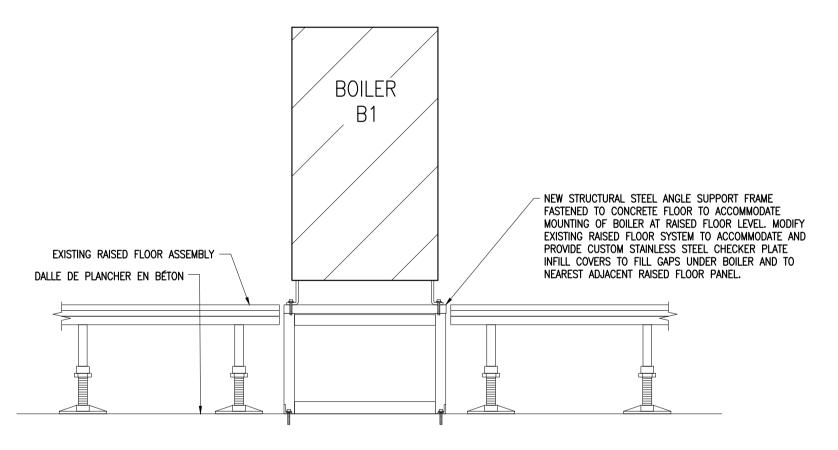



DEMOLITION WORK NOTES

- TEMOVE EXISTING CHEMAP 75L FERMENTER AS INDICATED C/W ASSOCIATED BASE FRAME, PIPING, CONTROLS, AND ACCESSORIES. REMOVE EXISTING HIGH PRESSURE STEAM AND CONDENSATE PIPING BEING RAN AROUND PERIMETER OF LAB AT LOW LEVEL AS INDICATED C/W ASSOCIATED VALVES, PRVs, SRVs, TRAPS, AND ACCESSORIES BACK TO CONNECTION AT ASSOCIATED LAB EQUIPMENT. MISC. SPECIALTY GAS, DCW, AND CHILLED WATER PIPING BEING RAN ADJACENT TO EXISTING
 - STEAM/CONDENSATE PIPING AT LOW LEVEL IS TO REMAIN. COORDINATE REMOVALS WITH NRC DEPARTMENTAL REPRESENTATIVE AND LAB EQUIPMENT OPERATORS TO ENSURE EQUIPMENT IS PROPERLY DISCONNECTED AND HANDLED AS NECESSARY TO ACCOMMODATE
- CAP/ABANDON MAIN STEAM SUPPLY AND CONDENSATE PIPING AT GROUND LEVEL IN RM 4095A. COORDINATE WITH DEPARTMENTAL REPRESENTATIVE FOR ALL REQUIRED DISCONNECTIONS, ISOLATIONS, SHUTDOWNS, AND PHASING REQUIRED THROUGHOUT SCOPE OF WORK.
- (5) PATCH, SEAL, AND MAKE GOOD ANY OPENINGS REMAINING FROM REMOVED PIPING.
- (6) REMOVE EXISTING STEAM SAFETY RELIEF VENT PIPING TO MAIN AND CAP. EXISTING 500 STEAM VENTING PIPE TO REMAIN IN PLACE C/W EXISTING PROCESS VENT CONNECTIONS. LABEL VENT PIPE AS PROCESS VENT.

NEW WORK NOTES

- PROVIDE NEW BOILER B1 AS INDICATED C/W ASSOCIATED BLOWDOWN SEPARATOR, PIPING, CONTROLS, AND ACCESSORIES. INSTALL IN ACCORDANCE WITH MANUFACTURERS INSTALLATION INSTRUCTIONS. BOILER BASE FRAME TO BE FASTENED DOWN TO FINISHED FLOOR, BELOW RAISED FLOOR ASSEMBLY ON WHICH IT IS INSTALLED. ALLOW FOR PAINTED STEEL STRUCTURAL SUPPORT STAND. REFERENCE CONCEPTUAL DETAIL 4/MO4.
- PROVIDE NEW STEAM AND CONDENSATE PIPING AS INDICATED C/W ASSOCIATED PRVs, SRVs, CONTROL VALVES, TRAPS, AND ACCESSORIES. REFERENCE VALVE SCHEDULES AND PIPING SCHEMATIC FOR ADDITIONAL SYSTEM DETAILS. SRV RELIEF PIPING TO BE TIED INTO EXISTING VENT PIPE DISTRIBUTION AT HIGH LEVEL.
- PROVIDE NEW WATER SOFTENER SYSTEM AS INDICATED C/W ASSOCIATED PIPING, CONTROLS, NORMALLY CLOSED BYPASS, AND ACCESSORIES. TREATED WATER TO BE DISTRIBUTED TO BOILER FEEDWATER PUMP, BLOWDOWN SEPARATOR, AND CONDENSATE COOLER. COORDINATE EXACT EQUIPMENT LOCATIONS ON SITE AND INSTALL IN ACCORDANCE WITH MANUFACTURERS INSTALLATION INSTRUCTIONS.
- PROVIDE ALL NEW SAFETY RELIEF VENTS AND RELIEF VENTING TO COMMON SAFETY RELIEF VENT SYSTEM DISCHARGING TO ROOFTOP TERMINATION. PROVIDE CUTTING, PATCHING, AND ROOF WORK TO ACCOMMODATE. COORDINATE EXACT TERMINATION LOCATION ON SITE TO AVOID INTERFERENCE WITH EXISTING HIGH LEVEL DUCTWORK AND SERVICES TO REMAIN. REFERENCE DETAIL 2/M02.

Real Property Planning

and Management Branch

Planification et gestion des biens immobiliers

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GENERAL NOTES

CONTRACTOR TO VERIFY ALL DIMENSIONS AND CLEARANCES ON SITE PRIOR TO CONSTRUCTION AND REPORT ANY DISCREPANCIES AND/OR OMISSIONS TO DEPARTMENTAL REPRESENTATIVE.

- CONTRACTOR MUST VISIT THE SITE AND FULLY FAMILIARIZE THEMSELF WITH THE SCOPE OF THE WORK PRIOR TO PROJECT COMMENCEMENT.
- ALL TRADES TO COORDINATE WORK ON SITE, WITH APPROVAL OF DEPARTMENTAL REPRESENTATIVE TO AVOID ANY CONFLICTS AND/OR INTERFERENCE.
- ANY AND ALL REQUIRED SHUTDOWNS SHALL BE COORDINATED WITH DEPARTMENTAL REPRESENTATIVE.
- INSTALLATION OF ALL SYSTEMS SHALL BE IN ACCORDANCE WITH APPLICABLE CODES AND STANDARDS.
- CONTRACTOR TO BE RESPONSIBLE FOR REINSTATEMENT AND REPAIR OF ANY DAMAGE CAUSED BY WORK.
- CONTRACTOR SHALL PREVENT THE SPREAD OF DUST AND DEBRIS BEYOND AREA OF WORK AND CLEAN ALL SURFACES AT COMPLETION.
- ALL ISOLATIONS AND SHUTDOWNS TO BE PERFORMED OUTSIDE OF NORMAL WORKING HOURS.




05	2023-01-13	ISSUED FOR TENDER
04	2022-12-21	ISSUED FOR 100% REVIEW
03	2022-12-08	ISSUED FOR 99% REVIEW - MECHANICAL
02	2022-09-30	ISSUED FOR 66% REVIEW
01	2022-09-02	ISSUED FOR 33% REVIEW
No.	Date	Revision




Goodkey Weedmark Consulting Engineers

GOODKEY WEEDMARK & ASSOCIATES LIMITED 613 727-5111 Voice 613 727-5115 Fax 1688 Woodward Dr. Ottawa Ontario www.gwal.com Web Canada K2C 3R8

- O Verify all dimensions and site conditions and be responsible
- o Vérifier toutes les dimensions et l'etat des liéux et en assumer la responsabilité

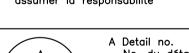

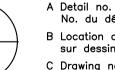

No. du détail B Location drawing no. sur dessin no. C Drawing no. dessin no.



projet

dessin

RM 4099 STEAM BOILER


100 SUSSEX DRIVE, OTTAWA, ON. drawing


BUILDING S77


MECHANICAL RM 4099 **DEMOLITION AND NEW WORK**

designed		conçu	date	date
	R.L.			
drawn		dessiné	scale	échelle
	K.N.		AS NOTED/C	OMME INDIQUÉ
checked		vérifié	sheet	feuille
	R.L.		of/	de <u> </u>
approved		approuvé	W.O.no.	D.T.no.
	R.L.			
dwg.no.				dessin no.


6092-M04

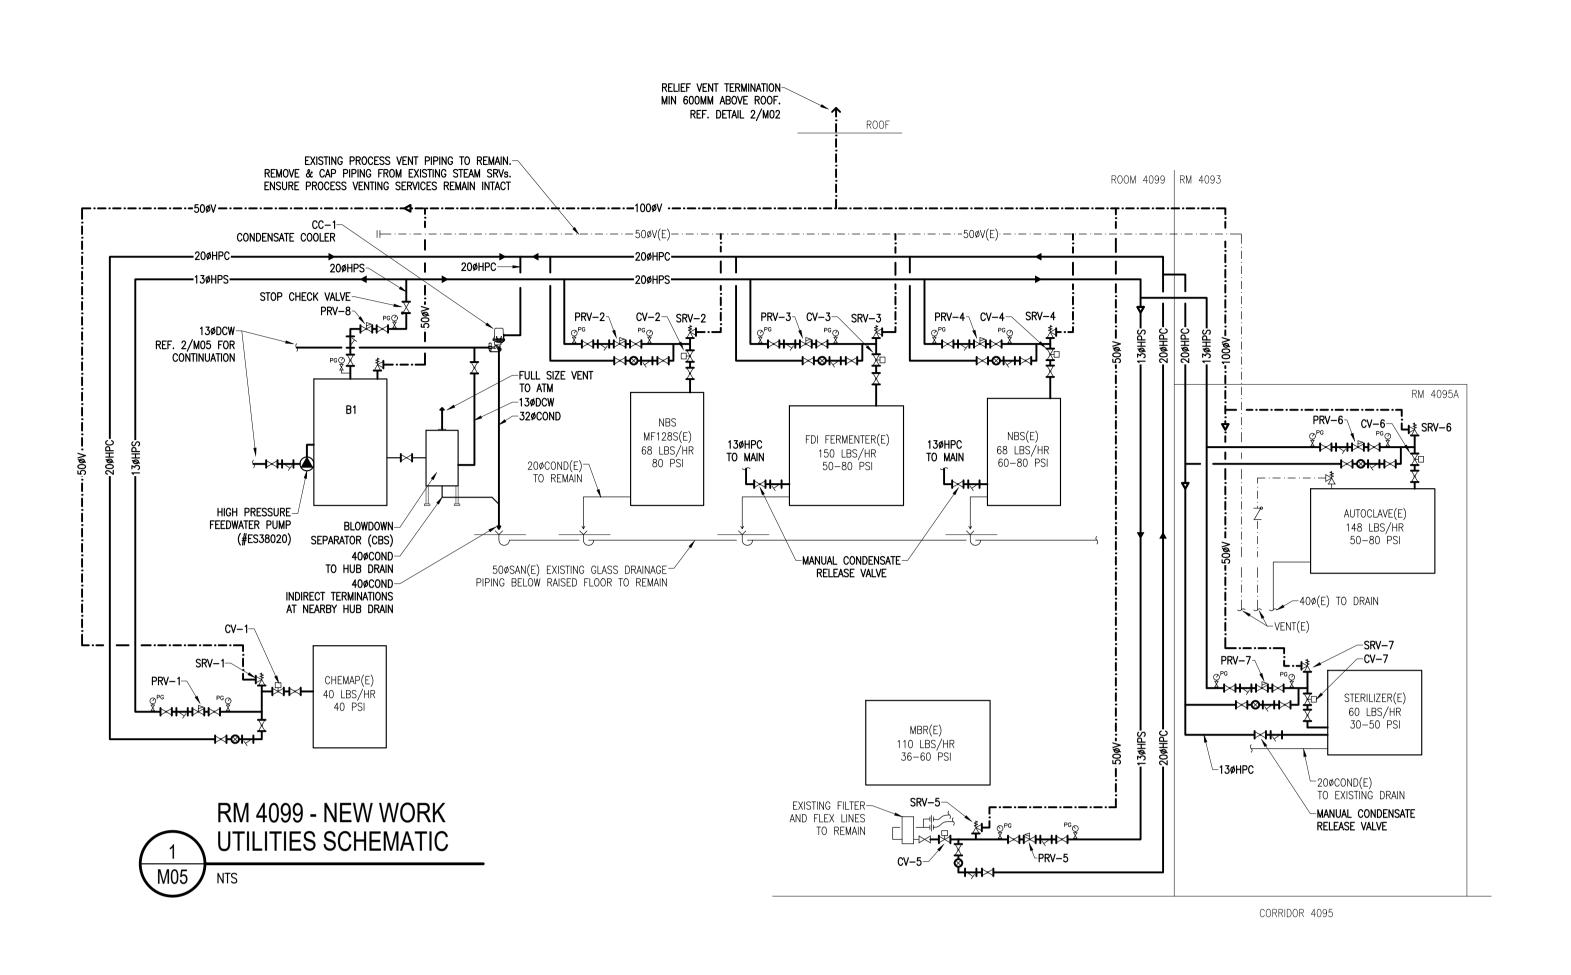

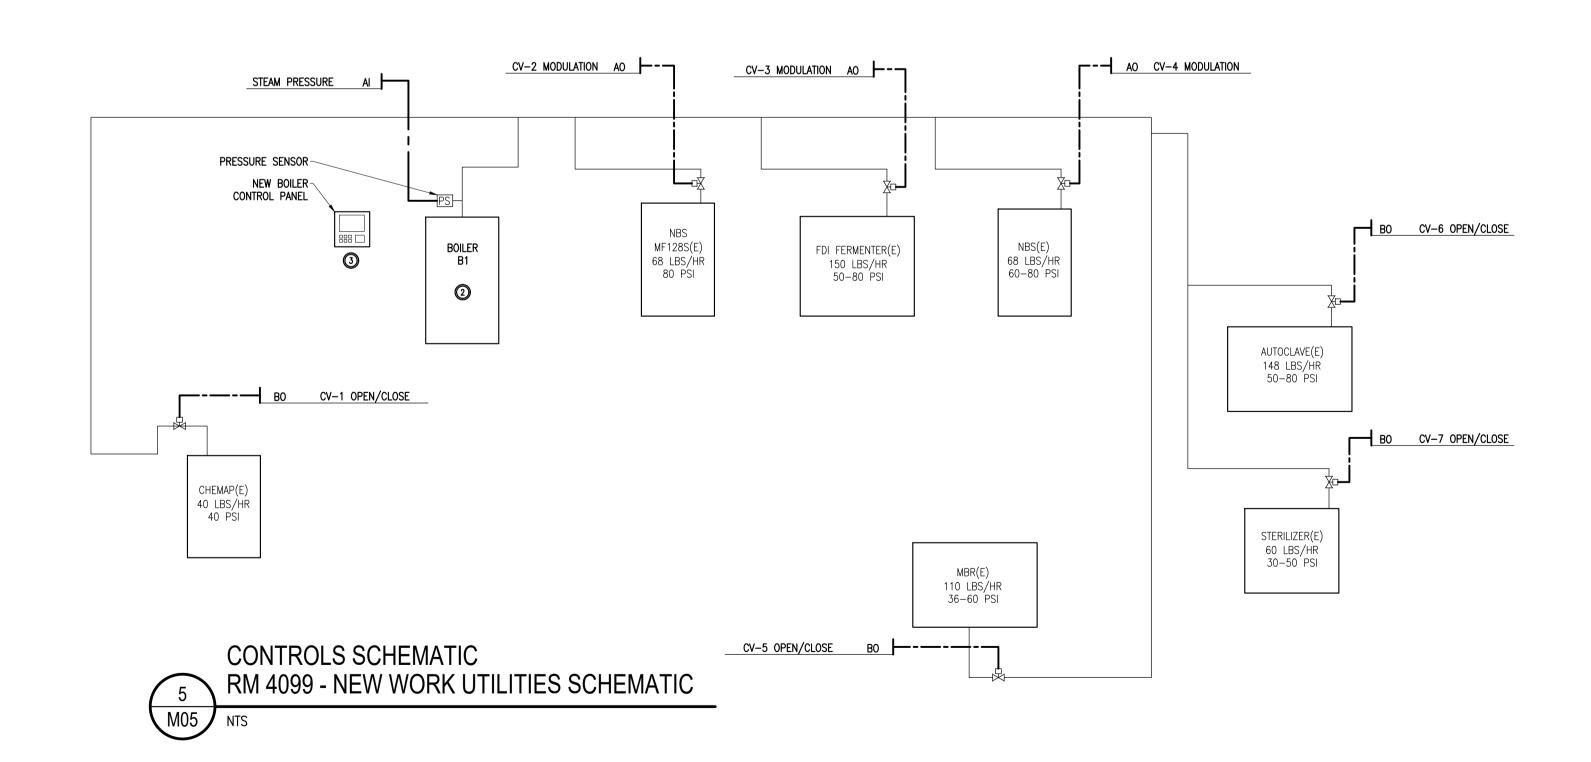

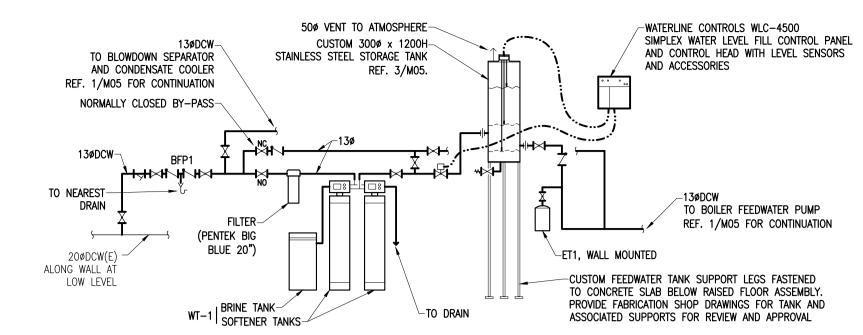


RM 4099 - NEW WORK WATER TREATMENT & BOILER FEEDWATER SCHEMATIC

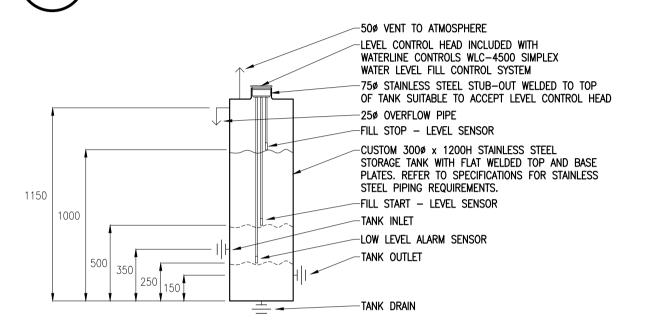


RM 4099 - NEW WORK

FEEDWATER STORAGE TANK DETAIL

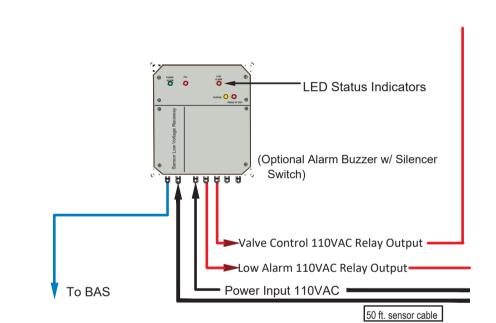

FEEDWATER TANK CONTROL PANEL WIRING
M05 NTS

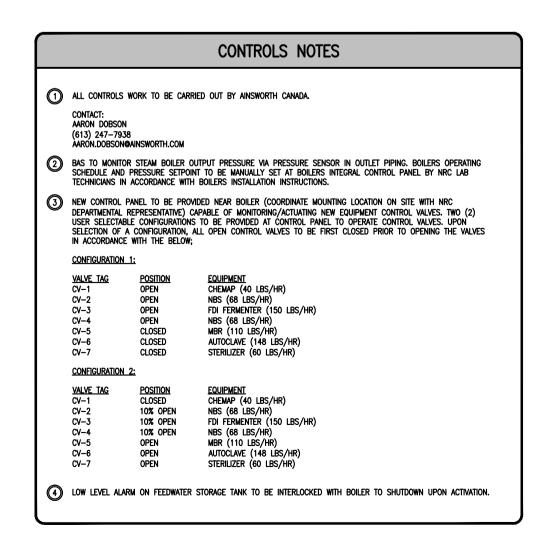

Nation Counci

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O Verify all dimensions and site conditions and be responsible for same

o Vérifier toutes les dimensions et l'etat des liéux et en assumer la responsabilité

A

drawing

A Detail no.
No. du détail
B Location drawing no.
sur dessin no.
C Drawing no.
dessin no.

ing no.

projet

dessin

BUILDING S77 RM 4099 STEAM BOILER

100 SUSSEX DRIVE, OTTAWA, ON.

MECHANICAL

RM 4099 UTILITIES SCHEMATICS

dwg.no.		6002	-1405	dessin no.
approved	R.L.	approuvé	W.O.no.	D.T.no.
checked	R.L.	vérifié	sheet of/	feuille de <u> </u>
drawn	K.N.	dessiné	scale AS NOTED/C	échelle OMME INDIQUÉ
designed	R.L.	conçu	date	date

6092-M05

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